Addendum 01

DOCUMENT 00 9100

DATE: March 7th, 2023

PROJECT: Tipp City Government Building Infill Addition

280 South Garber Drive Tipp City, OH 45371

PROJECT #: 22094.0

OWNER: City of Tipp City

Contact: Doug Arnold 280 South Garber Drive Tipp City, OH 45371

ARCHITECT: Garmann Miller

38 South Lincoln Drive

P.O. Box 71

Minster, Ohio 45865

TO: Prospective Bidders

This addendum form is a part of the Contract Documents and modifies the Bidding Documents dated February 2, 2023 with amendments and additions noted below.

Acknowledge receipt of this Addendum on the Bid Form. Failure to do so may disqualify the Bidder.

This addendum consists of 02 pages, updated TOC, 02 specification sections, 05 re-issued drawing sheets.

FOR INFORMATION ONLY

1. Pre-bid meeting minutes and the pre-bid meeting sign-in sheet are attached.

CHANGES TO THE PROJECT MANUAL

- 1. Table of Contents: Replace in its entirety.
- 2. Section 00 41 13 Bid Form: Replace in its entirety.
- 3. Section 01 22 00 Unit Prices: Add section in its entirety.
- 4. Section 07 22 16 Roof Board Insulation:



- a. Delete Article 3.03 Metal Deck Preparation. (There is no acoustic deck on the project)
- Article 3.04 Installation of Vapor Barrier, Paragraph A. Install Vapor Retarder:
 Delete Subparagraph 1. At acoustical metal deck, install acoustical insulation in roof deck flutes first. (There is no acoustic deck on the project)
- 5. Section 07 54 19 PVC Thermoplastic Single-Ply Roofing:
 - a. Article 2.04 Deck Sheathing and Cover Boards, Paragraph A. Deck Sheathing and Cover Board: Change thickness to 1/2 inch thick.
 - b. Article 2.06 Accessories: Update Paragraph 3:
 - Roof Walkway Pads: Install as indicated on drawings and per manufacturer's recommendations
 - 1) Pressure-Sensitive Walkway Pads (with Factory-Applied Tape on the underside of the walkway) adhere to the membrane surface with manufacturer's recommended adhesive.

CHANGES TO THE DRAWINGS

- 1. Drawing Sheet AD5.1 Roof Demolition Plan / Details: Detail 1 Demolition Roof Plan: Revise detail as shown.
- 2. Drawing Sheet A5.1 Roof Plan: Roof Plan and Roof Details revise as shown.
- 3. Drawing Sheet FP1.1 FIRE PROTECTION PLAN: Detail 1 FIRE PROTECTION PLAN MEZZANINE: Revised the drawings to show the mezzanine level of the fire suppression system.
- 4. Drawing Sheet M2.1 First Floor Mechanical Plan: Add keynotes 7 and 8 as shown.
- 5. Drawing Sheet E5.1 Roof Electrical Plan: Detail 1 Roof Electrical Plan: Revised the drawing to show the modifications needed to the lightning protection system on the existing portion of the building.

ATTACHMENTS

The following attachments are included and are part of this addendum:

Pre-bid meeting minutes and the pre-bid meeting sign-in sheet.

Specification Sections: Table of Contents, 00 41 13, and 01 22 00

Drawing Sheets AD5.1, A5.1, FP1.1, M2.1, E5.1.

END OF ADDENDUM





Pre-bid meeting

Project name Meeting date Tipp City Gov't Center Infill Addition – Renovation Project 03/02/2023

GM project no. Meeting locatio 22094.0

Meeting location Tipp City Gov't Center

Notes from meeting are added in red below.

Outline

- 1. Attendees: Sign in sheet
- 2. Introductions
- 3. Project overview
 - a. Infill addition
 - b. Roof replacement
 - i. Modified bitumen roof and EPDM roof / Both have one roof system with steel deck
 - ii. No tear off should be needed
 - iii. Will ask for unit cost if any wet insulation is found
 - iv. To be clarified in the addendum
 - c. Window replacement
- 4. Bidding
 - a. Date: March 23, 2023 at 11:00.00 AM
 - b. Location:

Tipp City Government Center 260 S Garber Drive Tipp City, Ohio 45371

- a. Use the bid form provided
- b. Plans have been submitted to **Miami County Dept. of Development** for review and permits, costs to be paid by owner.
- 5. Bid categories
 - a. Single-prime contractor
- 6. Alternates
 - a. None
- 7. Contingency amounts to be included in bid
 - a. General construction: \$90,000.00
- 8. Contracts will be administered by Garmann Miller
 - a. All questions and correspondence to go through Garmann Miller
 - b. All RFIs to go through Garmann Miller
 - c. Pay applications to go to Garmann Miller



d. Garmann Miller will schedule a preconstruction meeting with the contractor after the notice of award

9. Schedule

- a. Tentative award date April 3rd City Council meeting
- b. Start of construction April 15th, 2023
- c. Milestone dates none at this time
- d. Completion date March 25, 2024
 - i. Liquidated Damages yes, refer to Article 8 in the supplementary conditions

10. General conditions

- a. Waste Removal: Each prime contractor
- b. General Contractor
 - i. Responsible for construction schedule and general supervision
 - ii. Submit preliminary schedule 10 days after notice to proceed
 - iii. Responsible for scheduling and administering job meetings; prepare agenda, responsible for meeting minutes and distributing copies
- c. Responsible for field office
- d. Responsible for telephone service/fax to field office.
- e. Responsible for sanitary facilities
- f. Barriers
- g. Fencing
- h. Exterior and interior enclosures
- i. Project sign not required

11. Temporary electricity

- a. Electrical contractor to provide temporary power, temporary lighting, temporary service to general contractor job trailer. Can connect to existing building for temporary power.
- b. Cost of electricity: by Owner
- 12. Temporary heat / ventilation / cooling / dehumidification, as required
 - a. Prior to building enclosure & after building enclosure:
 - i. Method by contractor
 - ii. Cost by contractor

13. Temporary water

- a. Connect to existing building
- 14. Substitution request by 10 days prior to bid.

15. Correspondence

- a. Correspondence to run through the Garmann Miller
- b. Construction Administration Jason Fleming jfleming@creategm.com
- c. Architectural/General Andrew Huelsman ahuelsman@creategm.com
- d. Mechanical/Plumbing/Fire Suppression Andrew Huelsman



- e. Electrical **Ashley Minton aminton@creategm.com**
- f. Technology Doug Arnold arnoldd@tippcity.net

Questions

1. Can the interior renovation portion of the project be completed during normal working hours.

Answer: Yes, this work can be done in normal working hours. The occupants will be temporarily relocated. The exact timing on this work will need to be coordinated with the owner. Temporary barriers/dust containment, as necessary, is the responsibility of the contractor as indicated in the specifications.

TABLE OF CONTENTS

DIVISION 00 - PROCUREMENT AND CONTRACTING REQUIREMENTS		
00 11 13	ADVERTISEMENT FOR BIDS	
00 11 30	ABBREVIATED SCOPE OF WORK	
00 21 13	AIA A701 INSTRUCTIONS TO BIDDERS	
00 22 13	SUPPLEMENTARY INSTRUCTIONS TO BIDDERS	
00 31 19	EXISTING CONDITION INFORMATION	
00 41 13	BID FORM	
00 45 19	NON-COLLUSION AFFIDAVIT	
00 45 21	CONTRACTOR'S AFFIDAVIT	
00 50 00	CONTRACTING FORMS AND SUPPLEMENTS	
00 52 13	AIA A101 STANDARD FORM OF AGREEMENT	
00 61 16	CONDITIONAL LIEN WAIVER AND RELEASE UPON PROGRESS PAYMENT	
00 63 13	GM REQUEST FOR INFORMATION	
00 72 13	AIA A201 GENERAL CONDITIONS	
00 73 00	SUPPLEMENTARY CONDITIONS	
DIVISION 01 - GEN	ERAL REQUIREMENTS	
01 11 00	SUMMARY OF WORK	
01 20 00	PRICE AND PAYMENT PROCEDURES	
01 21 00	ALLOWANCES	
01 22 00	UNIT PRICES	
01 30 00	ADMINISTRATIVE REQUIREMENTS	
01 33 23	CONTRACTOR SUBMITTAL FORM	
01 43 00	QUALITY ASSURANCE	
01 45 25	MASONRY INSPECTION FORM	
01 45 33	CODE-REQUIRED SPECIAL INSPECTIONS AND PROCEDURES	
01 50 00	TEMPORARY FACILITIES AND CONTROLS	
01 51 00	TEMPORARY UTILITIES	
01 57 13	TEMPORARY EROSION AND SEDIMENT CONTROL	
01 60 00	PRODUCT REQUIREMENTS	
01 60 00.01	SUBSTITUTION REQUEST FORM	
01 70 00	EXECUTION AND CLOSEOUT REQUIREMENTS	
01 78 00	CLOSEOUT SUBMITTALS	
01 79 00	DEMONSTRATION AND TRAINING	

DIVISION 02 - EXISTING CONDITIONS

02 41 00 DEMOLITION

22094.00 Tipp City Government Center Infill Addition Bid Documents – Addendum 01

DIVISION 03 - CONCRETE

03 15 21	UNDER SLAB VAPOR/TERMITE/GAS BARRIER
03 30 00	CAST-IN-PLACE CONCRETE
03 35 11	CONCRETE FLOOR FINISHES

DIVISION 04 - MASONRY

04 05 13	MASONRY MORTARING
04 05 16	MASONRY GROUTING
04 05 19	MASONRY ANCHORAGE & REINFORCING
04 05 23	MASONRY ACCESSORIES
04 20 00	UNIT MASONRY

DIVISION 05 - METALS

05 12 00	STRUCTURAL STEEL FRAMING
05 21 00	STEEL JOIST FRAMING
05 31 00	STEEL DECKING
05 50 00	METAL FABRICATIONS
05 51 00	METAL STAIRS
05 52 13	METAL PIPE AND TUBE RAILINGS
05 53 00	METAL GRATINGS

DIVISION 06 - WOOD, PLASTICS, AND COMPOSITES

06 10 00	ROUGH CARPENTRY
06 41 00	ARCHITECTURAL WOOD CASEWORK

DIVISION 07 - THERMAL AND MOISTURE PROTECTION

07 01 50.19	PREPARATION FOR RE-ROOFING
07 21 13	BOARD INSULATION
07 21 16	BLANKET INSULATION
07 21 19	FOAMED-IN-PLACE INSULATION
07 22 16	ROOF BOARD INSULATION
07 24 00	EXTERIOR INSULATION AND FINISH SYSTEMS
07 42 13.13	FORMED METAL WALL PANELS
07 54 19	PVC THERMOPLASTIC SINGLE-PLY ROOFING
07 62 00	SHEET METAL FLASHING AND TRIM
07 71 00	ROOF SPECIALTIES
07 72 00	ROOF ACCESSORIES
07 84 00	FIRESTOPPING
07 92 00	JOINT SEALANTS

DIVISION 08 - OPENINGS

08 11 13	HOLLOW METAL DOORS AND FRAMES
08 14 16	FLUSH WOOD DOORS
08 31 00	ACCESS DOORS AND PANELS
08 43 13	ALUMINUM-FRAMED STOREFRONTS
08 71 00	DOOR HARDWARE
08 80 00	GLAZING

DIVISION 09 - FINISHES

09 21 16	GYPSUM BOARD ASSEMBLIES
09 22 16	NON-STRUCTURAL METAL FRAMING
09 51 00	ACOUSTICAL CEILINGS
09 65 00	RESILIENT FLOORING
09 65 13	RESILIENT BASE & ACCESSORIES
09 68 13	TILE CARPETING
09 69 00	ACCESS FLOORING
09 91 13	EXTERIOR PAINTING
09 91 23	INTERIOR PAINTING

DIVISION 10 - SPECIALTIES

10 14 67	TACTILE SIGNAGE
10 28 00	TOILET ACCESSORIES
10 44 00	FIRE PROTECTION SPECIALTIES

DIVISION 12 - FURNISHINGS

12 24 00	WINDOW SHADES
12 36 00	COUNTERTOPS

DIVISION 21 – FIRE SUPPRESSION

21 05 01	FIRE PROTECTION MATERIALS AND METHODS
21 05 03	WORK IN EXISTING BUILDING
21 05 53	FIRE SUPPRESSION IDENTIFICATION
21 13 00	FIRE PROTECTION SYSTEMS
21 22 00	CLEAN AGENT FIRE EXTINGUISHING SYSTEM

DIVISION 22 – PLUMBING

22 05 01	PLUMBING MATERIALS AND METHODS	
22 05 03	WORK IN EXISTING BUILDING	
22 05 53	PLUMBING IDENTIFICATION	
22 07 19	PLUMBING PIPING INSULATION	
22094.00 Tipp City Government		
Center Infill Addition	Table of Contents	

22 10 05	PLUMBING PIPING
22 10 06	PLUMBING PIPING SPECIALTIES
22 40 00	PLUMBING FIXTURES
	TING, VENTILATING, AND AIR-CONDITIONING (HVAC)
23 05 01	MECHANICAL MATERIALS AND METHODS
23 05 03	WORK IN EXISTING BUILDING
23 05 48	VIBRATION AND SEISMIC CONTROLS
23 05 53	HVAC IDENTIFICATION
23 05 93	TESTING, ADJUSTING, AND BALANCING
23 07 13	DUCT INSULATION
23 07 19	HVAC PIPING INSULATION
23 31 00	HVAC DUCTS AND CASINGS
23 33 00	AIR DUCT ACCESSORIES
23 34 23	HVAC EXHAUST FANS
23 37 00	AIR OUTLETS AND INLETS
23 74 13	PACKAGED OUTDOOR CENTRAL STATION AIR HANDLING UNITS
23 81 25	COMPUTER ROOM AIR CONDITIONERS
23 82 00	CONVECTION HEATING AND COOLING UNITS
DIVISION 26 – ELE	
26 01 01	GENERAL PROVISIONS
26 01 01 26 05 03	GENERAL PROVISIONS WORK IN EXISTING BUILDINGS
26 01 01 26 05 03 26 05 05	GENERAL PROVISIONS WORK IN EXISTING BUILDINGS MINOR ELECTRICAL DEMOLITION
26 01 01 26 05 03 26 05 05 26 05 06	GENERAL PROVISIONS WORK IN EXISTING BUILDINGS MINOR ELECTRICAL DEMOLITION TEMPORARY WORK
26 01 01 26 05 03 26 05 05 26 05 06 26 05 19	GENERAL PROVISIONS WORK IN EXISTING BUILDINGS MINOR ELECTRICAL DEMOLITION TEMPORARY WORK CONDUCTORS
26 01 01 26 05 03 26 05 05 26 05 06	GENERAL PROVISIONS WORK IN EXISTING BUILDINGS MINOR ELECTRICAL DEMOLITION TEMPORARY WORK CONDUCTORS GROUNDING AND BONDING
26 01 01 26 05 03 26 05 05 26 05 06 26 05 19 26 05 26 26 05 29	GENERAL PROVISIONS WORK IN EXISTING BUILDINGS MINOR ELECTRICAL DEMOLITION TEMPORARY WORK CONDUCTORS GROUNDING AND BONDING HANGERS AND SUPPORTS
26 01 01 26 05 03 26 05 05 26 05 06 26 05 19 26 05 26	GENERAL PROVISIONS WORK IN EXISTING BUILDINGS MINOR ELECTRICAL DEMOLITION TEMPORARY WORK CONDUCTORS GROUNDING AND BONDING
26 01 01 26 05 03 26 05 05 26 05 06 26 05 19 26 05 26 26 05 29	GENERAL PROVISIONS WORK IN EXISTING BUILDINGS MINOR ELECTRICAL DEMOLITION TEMPORARY WORK CONDUCTORS GROUNDING AND BONDING HANGERS AND SUPPORTS
26 01 01 26 05 03 26 05 05 26 05 06 26 05 19 26 05 26 26 05 29 26 05 33.13	GENERAL PROVISIONS WORK IN EXISTING BUILDINGS MINOR ELECTRICAL DEMOLITION TEMPORARY WORK CONDUCTORS GROUNDING AND BONDING HANGERS AND SUPPORTS CONDUIT
26 01 01 26 05 03 26 05 05 26 05 06 26 05 19 26 05 26 26 05 29 26 05 33.13 26 05 33.16	GENERAL PROVISIONS WORK IN EXISTING BUILDINGS MINOR ELECTRICAL DEMOLITION TEMPORARY WORK CONDUCTORS GROUNDING AND BONDING HANGERS AND SUPPORTS CONDUIT BOXES
26 01 01 26 05 03 26 05 05 26 05 06 26 05 19 26 05 26 26 05 29 26 05 33.13 26 05 33.16 26 05 50	GENERAL PROVISIONS WORK IN EXISTING BUILDINGS MINOR ELECTRICAL DEMOLITION TEMPORARY WORK CONDUCTORS GROUNDING AND BONDING HANGERS AND SUPPORTS CONDUIT BOXES BASIC MATERIALS AND METHODS
26 01 01 26 05 03 26 05 05 26 05 06 26 05 19 26 05 26 26 05 29 26 05 33.13 26 05 33.16 26 05 50 26 05 53	GENERAL PROVISIONS WORK IN EXISTING BUILDINGS MINOR ELECTRICAL DEMOLITION TEMPORARY WORK CONDUCTORS GROUNDING AND BONDING HANGERS AND SUPPORTS CONDUIT BOXES BASIC MATERIALS AND METHODS IDENTIFICATION
26 01 01 26 05 03 26 05 05 26 05 06 26 05 19 26 05 26 26 05 29 26 05 33.13 26 05 33.16 26 05 50 26 05 53 26 05 55	GENERAL PROVISIONS WORK IN EXISTING BUILDINGS MINOR ELECTRICAL DEMOLITION TEMPORARY WORK CONDUCTORS GROUNDING AND BONDING HANGERS AND SUPPORTS CONDUIT BOXES BASIC MATERIALS AND METHODS IDENTIFICATION CONNECTORS
26 01 01 26 05 03 26 05 05 26 05 06 26 05 19 26 05 26 26 05 29 26 05 33.13 26 05 33.16 26 05 50 26 05 53 26 05 55 26 05 83	GENERAL PROVISIONS WORK IN EXISTING BUILDINGS MINOR ELECTRICAL DEMOLITION TEMPORARY WORK CONDUCTORS GROUNDING AND BONDING HANGERS AND SUPPORTS CONDUIT BOXES BASIC MATERIALS AND METHODS IDENTIFICATION CONNECTORS EQUIPMENT WIRING
26 01 01 26 05 03 26 05 05 26 05 06 26 05 19 26 05 26 26 05 29 26 05 33.13 26 05 33.16 26 05 50 26 05 53 26 05 55 26 05 83 26 24 16	GENERAL PROVISIONS WORK IN EXISTING BUILDINGS MINOR ELECTRICAL DEMOLITION TEMPORARY WORK CONDUCTORS GROUNDING AND BONDING HANGERS AND SUPPORTS CONDUIT BOXES BASIC MATERIALS AND METHODS IDENTIFICATION CONNECTORS EQUIPMENT WIRING PANELBOARDS
26 01 01 26 05 03 26 05 05 26 05 06 26 05 19 26 05 26 26 05 29 26 05 33.13 26 05 33.16 26 05 50 26 05 53 26 05 55 26 05 83 26 24 16 26 27 26	GENERAL PROVISIONS WORK IN EXISTING BUILDINGS MINOR ELECTRICAL DEMOLITION TEMPORARY WORK CONDUCTORS GROUNDING AND BONDING HANGERS AND SUPPORTS CONDUIT BOXES BASIC MATERIALS AND METHODS IDENTIFICATION CONNECTORS EQUIPMENT WIRING PANELBOARDS WIRING DEVICES
26 01 01 26 05 03 26 05 05 26 05 06 26 05 19 26 05 26 26 05 29 26 05 33.13 26 05 33.16 26 05 50 26 05 53 26 05 55 26 05 83 26 24 16 26 27 26 26 28 16.16	GENERAL PROVISIONS WORK IN EXISTING BUILDINGS MINOR ELECTRICAL DEMOLITION TEMPORARY WORK CONDUCTORS GROUNDING AND BONDING HANGERS AND SUPPORTS CONDUIT BOXES BASIC MATERIALS AND METHODS IDENTIFICATION CONNECTORS EQUIPMENT WIRING PANELBOARDS WIRING DEVICES ENCLOSED SWITCHES

DIVISION 28 – ELECTRONIC SAFETY AND SECURITY

22094.00 Tipp City Government

28 31 01 FIRE ALARM DETECTION SYSTEM

DIVISION 31 - EARTHWORK

31 10 00	SITE CLEARING
31 22 00	GRADING
31 23 16	EXCAVATION
31 23 23	FILL

DIVISION 32 – EXTERIOR IMPROVEMENTS

32 11 23	AGGREGATE BASE AND SURFACING
32 12 16	ASPHALT PAVING
32 13 13	CONCRETE PAVING

SECTION 00 41 13 - BID FORM THE PROJECT AND THE PARTIES

TO:

City of Tipp City

260 S Garber Drive Tipp City, Ohio45371

FOR:

Project: 22094.00 Tipp City Government Center Infill Addition

Project Number: 22094.00 260 S Garber Drive Tipp City, Ohio45371

DATE: _	(Bidder to enter date)
SUBMITT	ED BY:
Bid	der's Full Name:
	Address:
	City, State, Zip:
	Telephone:
	Fax No.:
	E-mail:
OFFER	
and me	ving examined the Place of The Work and all matters referred to in the Instructions to Bidders I the Contract Documents prepared by Garmann/Miller & Associates Inc. for the above ntioned project, we, the undersigned, hereby offer to enter into a Contract to perform the Work the Sum of:
Iter	n 1 - Contract A, General Construction - Base Bid:
	
	All Cash and Contingency Allowances described in Section 01 21 00 are included in the Bid Sum.
	have included the Bid Bond or security deposit as required by the Advertisement, Notice to ders, Instructions to Bidders.

22094.00 Tipp City Government Center Infill Addition Bid Documents - Addendum 01

This is a Tax Exempt Project.

Builders Risk Insurance is to be furnished by the Owner. State of Ohio Prevailing Wage Rates, have been included.

Bid Form

ACCEPTANCE

This offer shall be open to acceptance and is irrevocable for sixty days from the bid closing date.

If this bid is accepted by Owner within the time period stated above, we will:

Execute the Agreement within ten (10) days of receipt of Notice of Award.

Commence work within ten (10) days after written Notice to Proceed of this bid.

If this bid is accepted within the time stated, and we fail to commence the Work or we fail to provide the required Bond(s), the security deposit shall be forfeited as damages to Owner by reason of our failure, limited in amount to the lesser of the face value of the security deposit or the difference between this bid and the bid upon which a Contract is signed.

In the event our bid is not accepted within the time stated above, the required security deposit shall be returned to the undersigned, in accordance with the provisions of the Instructions to Bidders; unless a mutually satisfactory arrangement is made for its retention and validity for an extended period of time.

	portou or unio.			
CON	TRACT TIME			
	Owners desired start date	e: April 15, 2023		
	Owners desired completi	•	2024	
	If this Bid is accepted, we	•		
	•		n cortion data of	
	Complete the Work by M		er to enter completion dat	e or time frame prior to
	completion date listed.)	(5,00	or to ontor completion dat	o or amo namo prior to
UNIT	PRICES			
	The following are Unit Pri Unit Prices:	ices for specific porti	ons of the Work as listed.	The following is the list of
	The Owner, Architect, an Lack of agreement of Ur			r to the award of contract.
			oot to cut out, remove exist hat saturated insulation is	sting roof insulation and found during construction.
	\$		Per Squar	e Foot
ADD	ENDA			
	The following Addenda h	ave been received.	The modifications to the B	Bid Documents noted below
	have been considered ar			
	Addendum #	Dated	.	
	Addendum #	Dated	·	
	Addendum #	Dated	·	
	Addendum #	Dated	·	
DID 1	FORM OURRI EMENTO			
RID I	FORM SUPPLEMENTS			
	Bid Bond			
	Noncollusion Affidavit			
	Contractor's Affidavit			
BID I	FORM SIGNATURE(S)			

(Bidder - print the full name of your firm) was hereunto affixed in the presence of:	
·	
(Authorized signing officer)	
(Authorized eigning officer Title)	

(Authorized signing officer, Title)

SEALED SUBMISSION:

Bid is to be submitted in Duplicate.

Bid is to be submitted in a sealed envelope containing bid and bid form supplements and addressed as follows:

Prime Contract Bid for: City of Tipp City 260 S Garber Drive Tipp City, Ohio 45371

END OF BID FORM

SECTION 01 22 00 UNIT PRICES

PART 1 GENERAL

1.01 SECTION INCLUDES

- A. List of unit prices, for use in preparing Bids.
- Measurement and payment criteria applicable to Work performed under a unit price payment method.
- C. Defect assessment and non-payment for rejected work.

1.02 COSTS INCLUDED

A. Unit Prices included on the Bid Form shall include full compensation for all required labor, products, tools, equipment, plant, transportation, services and incidentals; erection, application or installation of an item of the Work; overhead and profit.

1.03 MEASUREMENT OF QUANTITIES

- Take all measurements and compute quantities. Measurements and quantities will be verified by Owner's representatives.
- B. Assist by providing necessary equipment, workers, and survey personnel as required.
- C. Measurement by Volume: Measured by cubic dimension using mean length, width and height or thickness.
- D. Measurement by Area: Measured by square dimension using mean length and width or radius.

1.04 PAYMENT


A. Payment for Work governed by unit prices will be made on the basis of the actual measurements and quantities of Work that is incorporated in or made necessary by the Work and accepted by the Architect, multiplied by the unit price.


1.05 SCHEDULE OF UNIT PRICES

- A. The Owner, Architect and Contractor must agree to all unit prices prior to the award of contract. A lack of agreement of unit prices is grounds for rejection of bids.
- B. Saturated Roof insulation encountered during construction
 - It is the intent of the project to overlay the existing roof with a new roof coverboard and membrane. In the event that saturated insulation is found during construction, provide a price per square foot to cut out, remove existing roof insulation and replace with new roof insulation.
 - a. Provide cost per square foot.

PART 2 PRODUCTS - NOT USED PART 3 EXECUTION - NOT USED

END OF SECTION

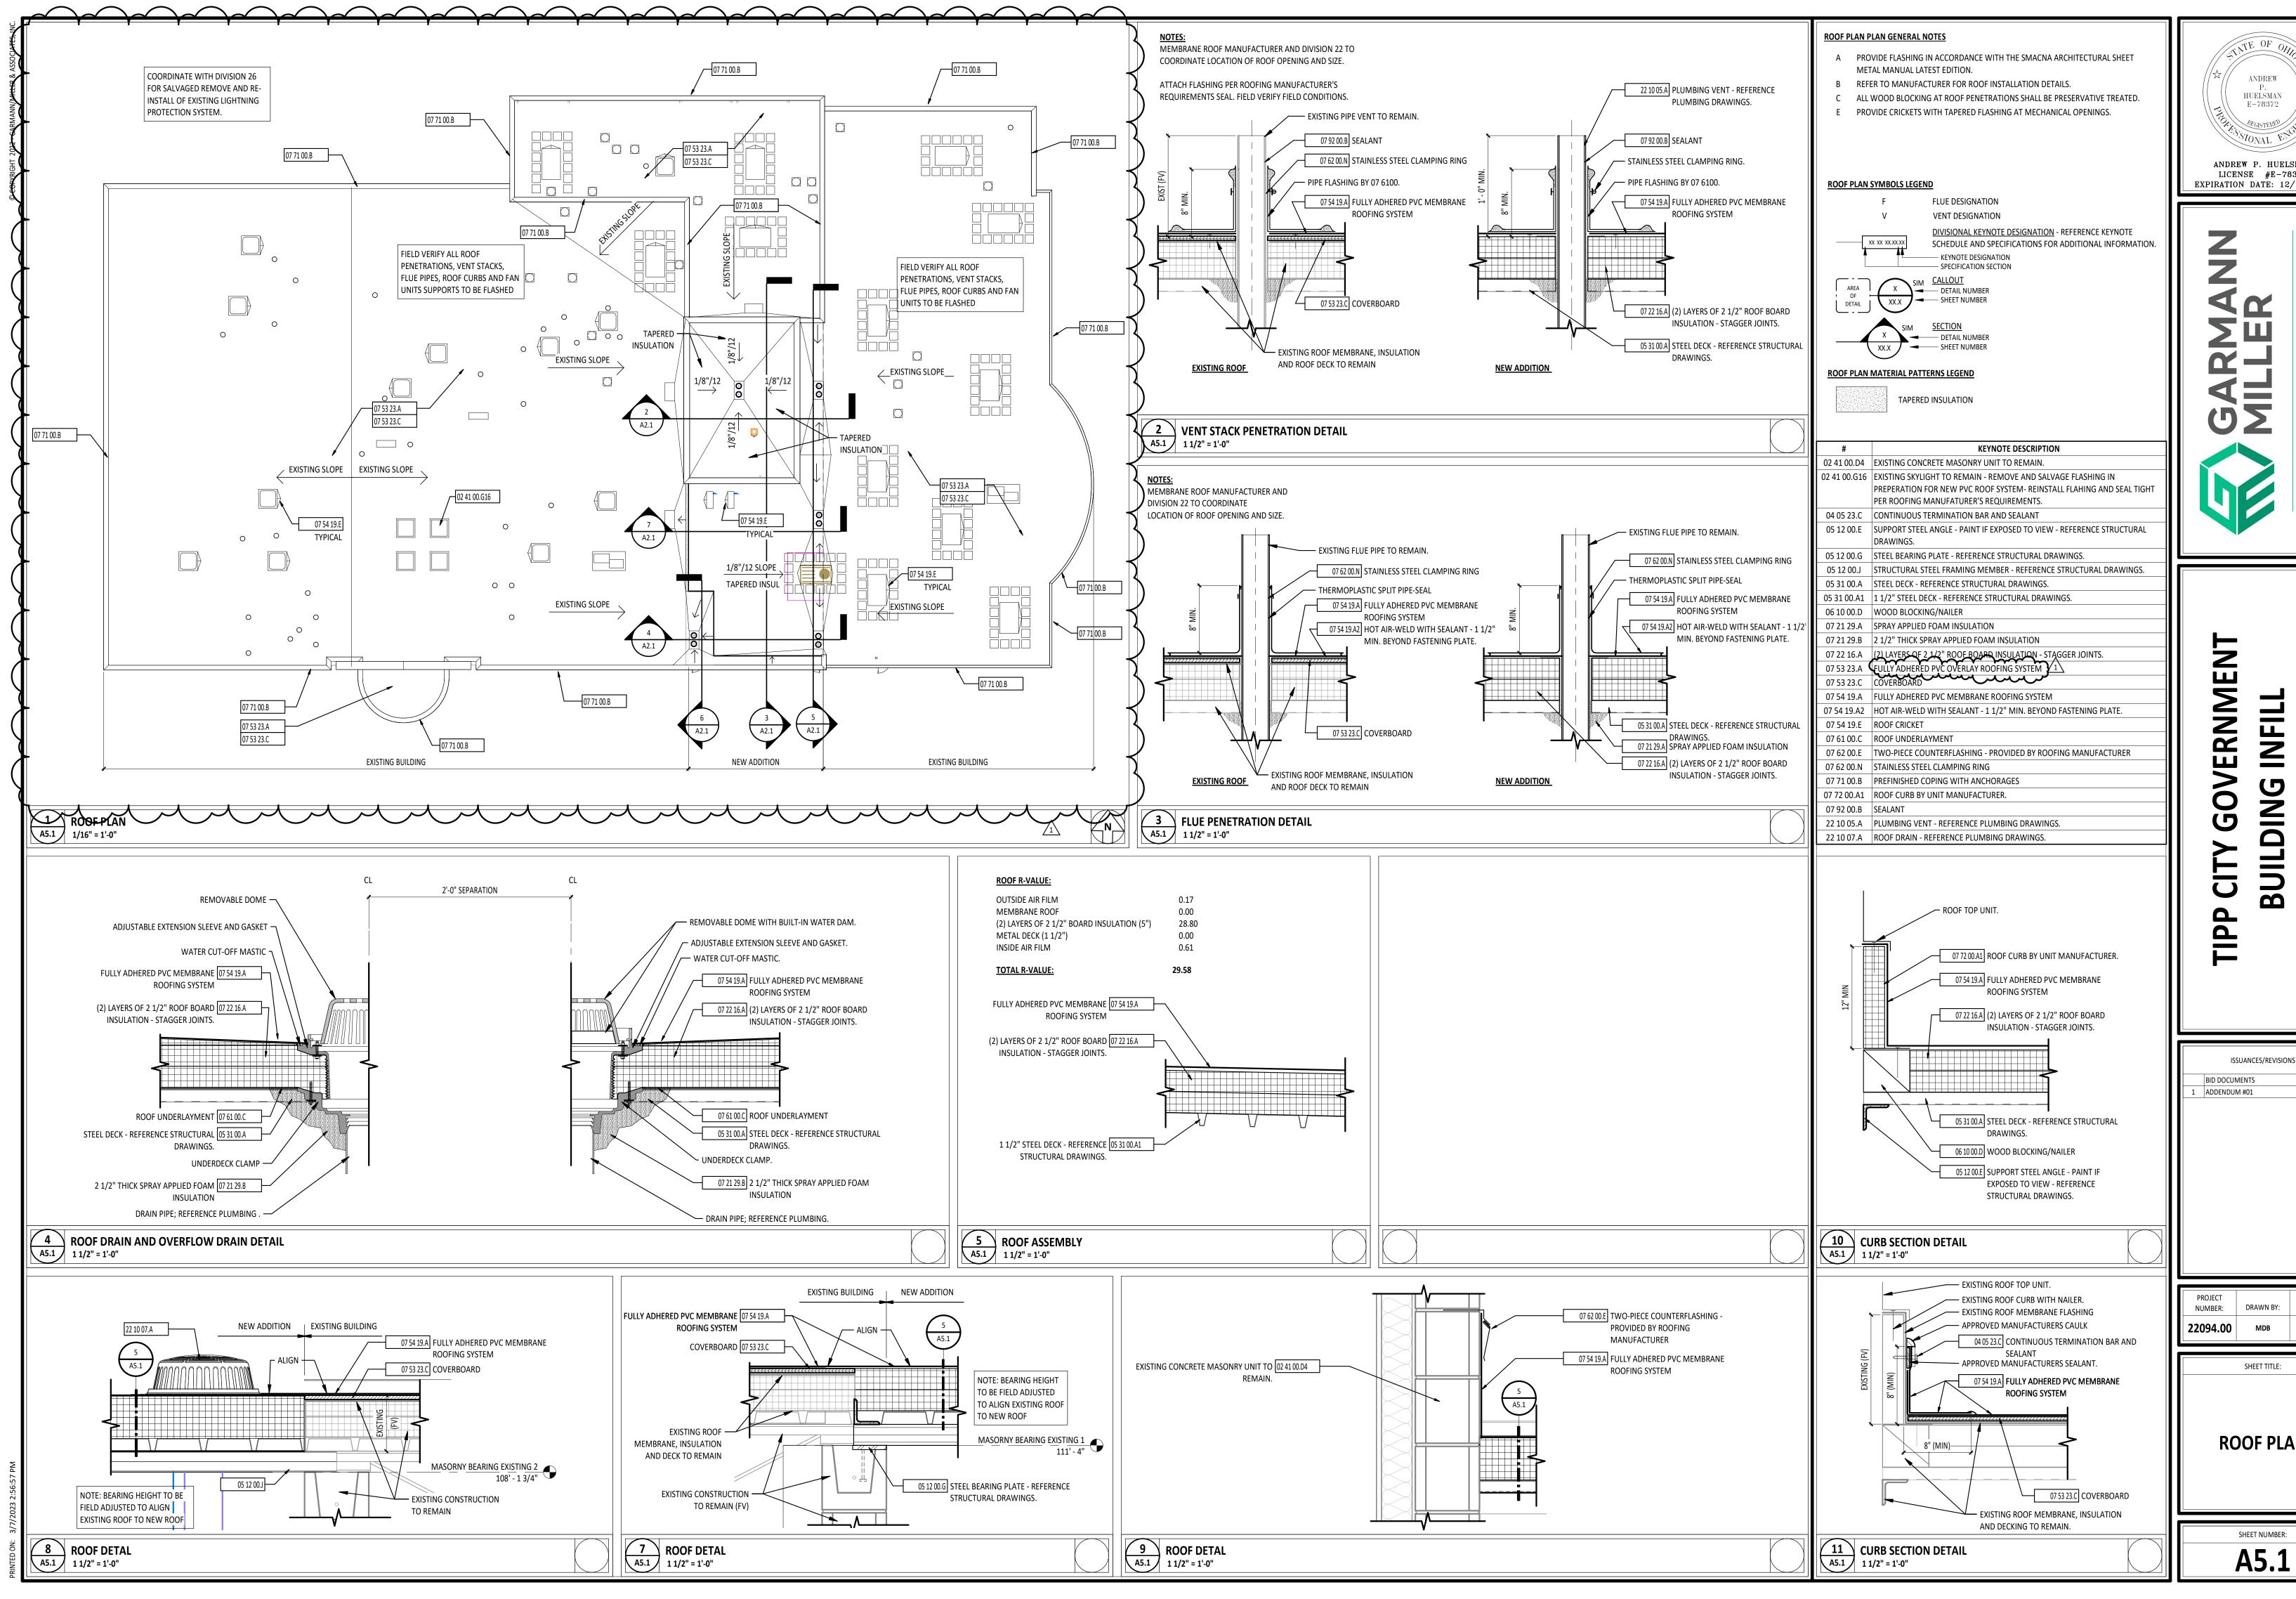

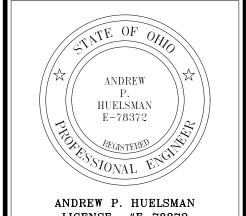


LICENSE #E-78372 EXPIRATION DATE: 12/31/2023


ISSUANCES/REVISIONS


DRAWN BY:

ROOF PLAN

SHEET NUMBER:

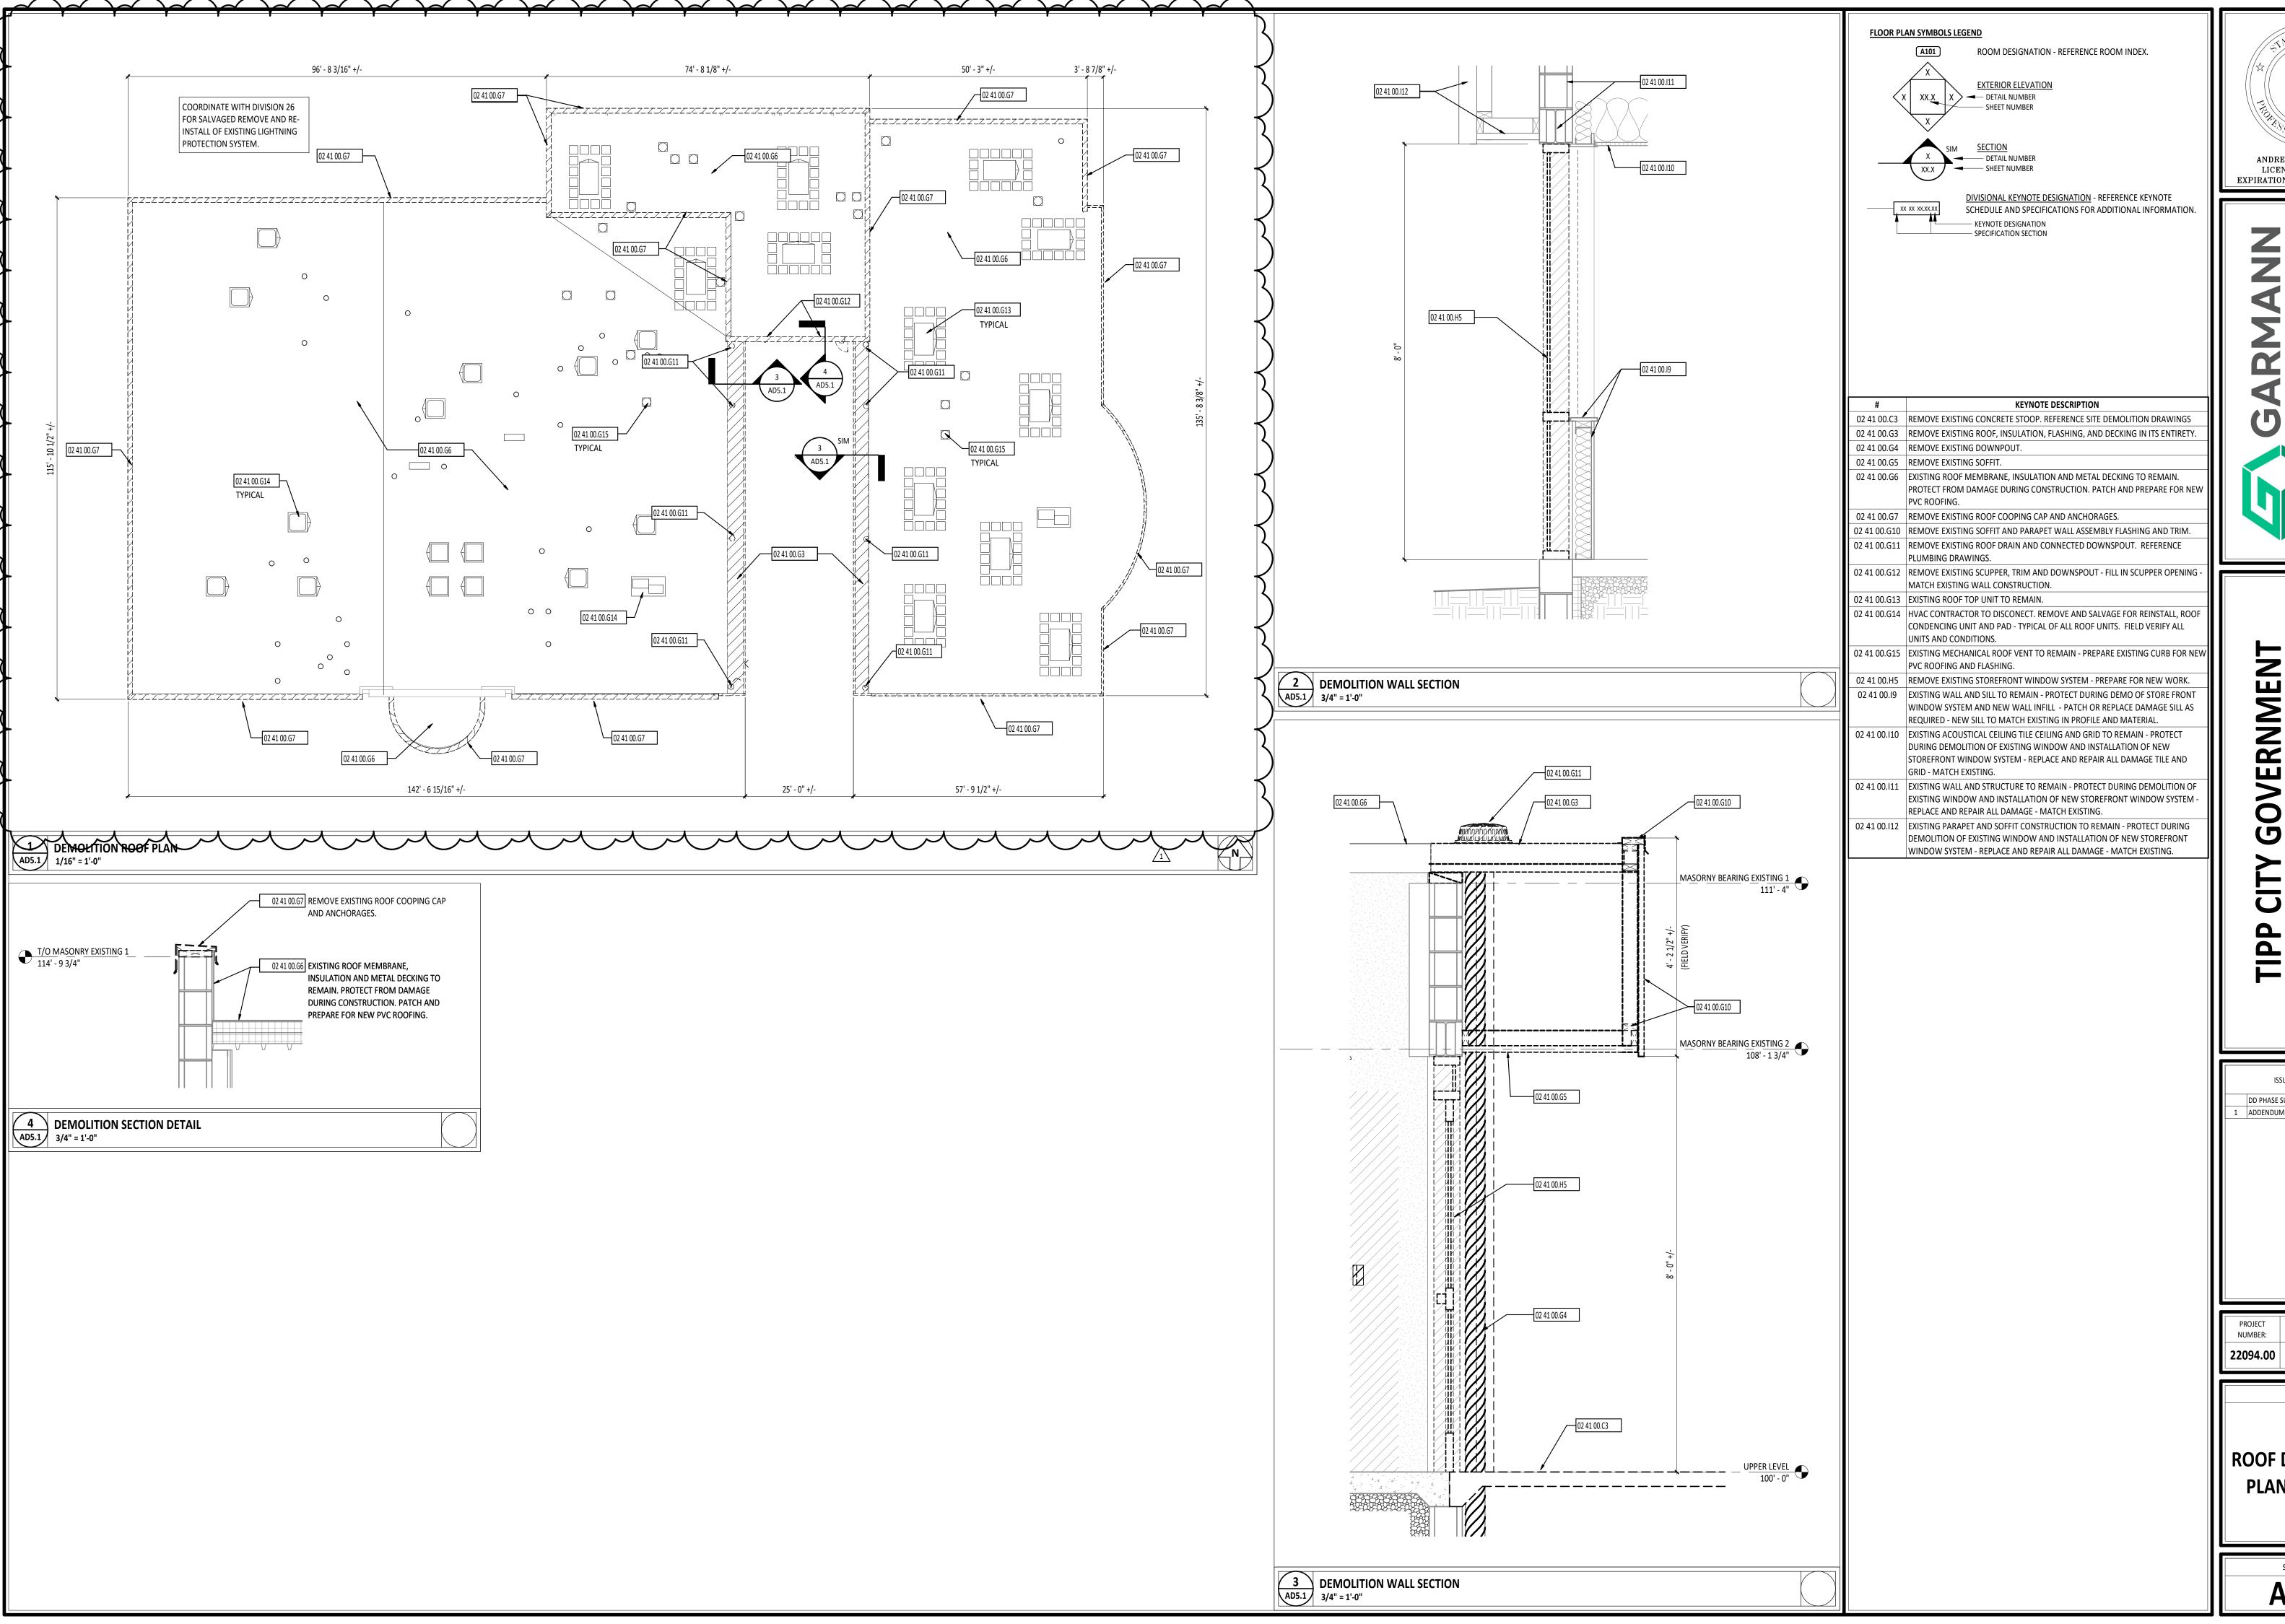

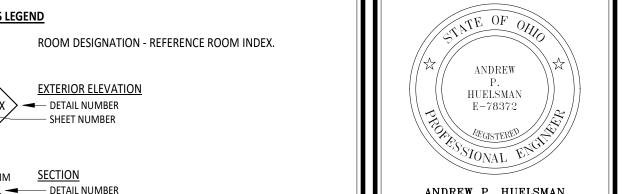

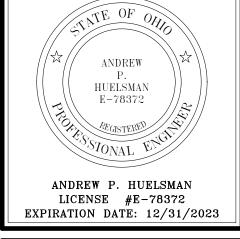


ERNMEN INFIL BUILD CITY TIPP

ISSUANCES/REVISIONS

SHEET TITLE:

ROOF DEMOLITION PLAN / DETAILS

> SHEET NUMBER: **AD5.1**

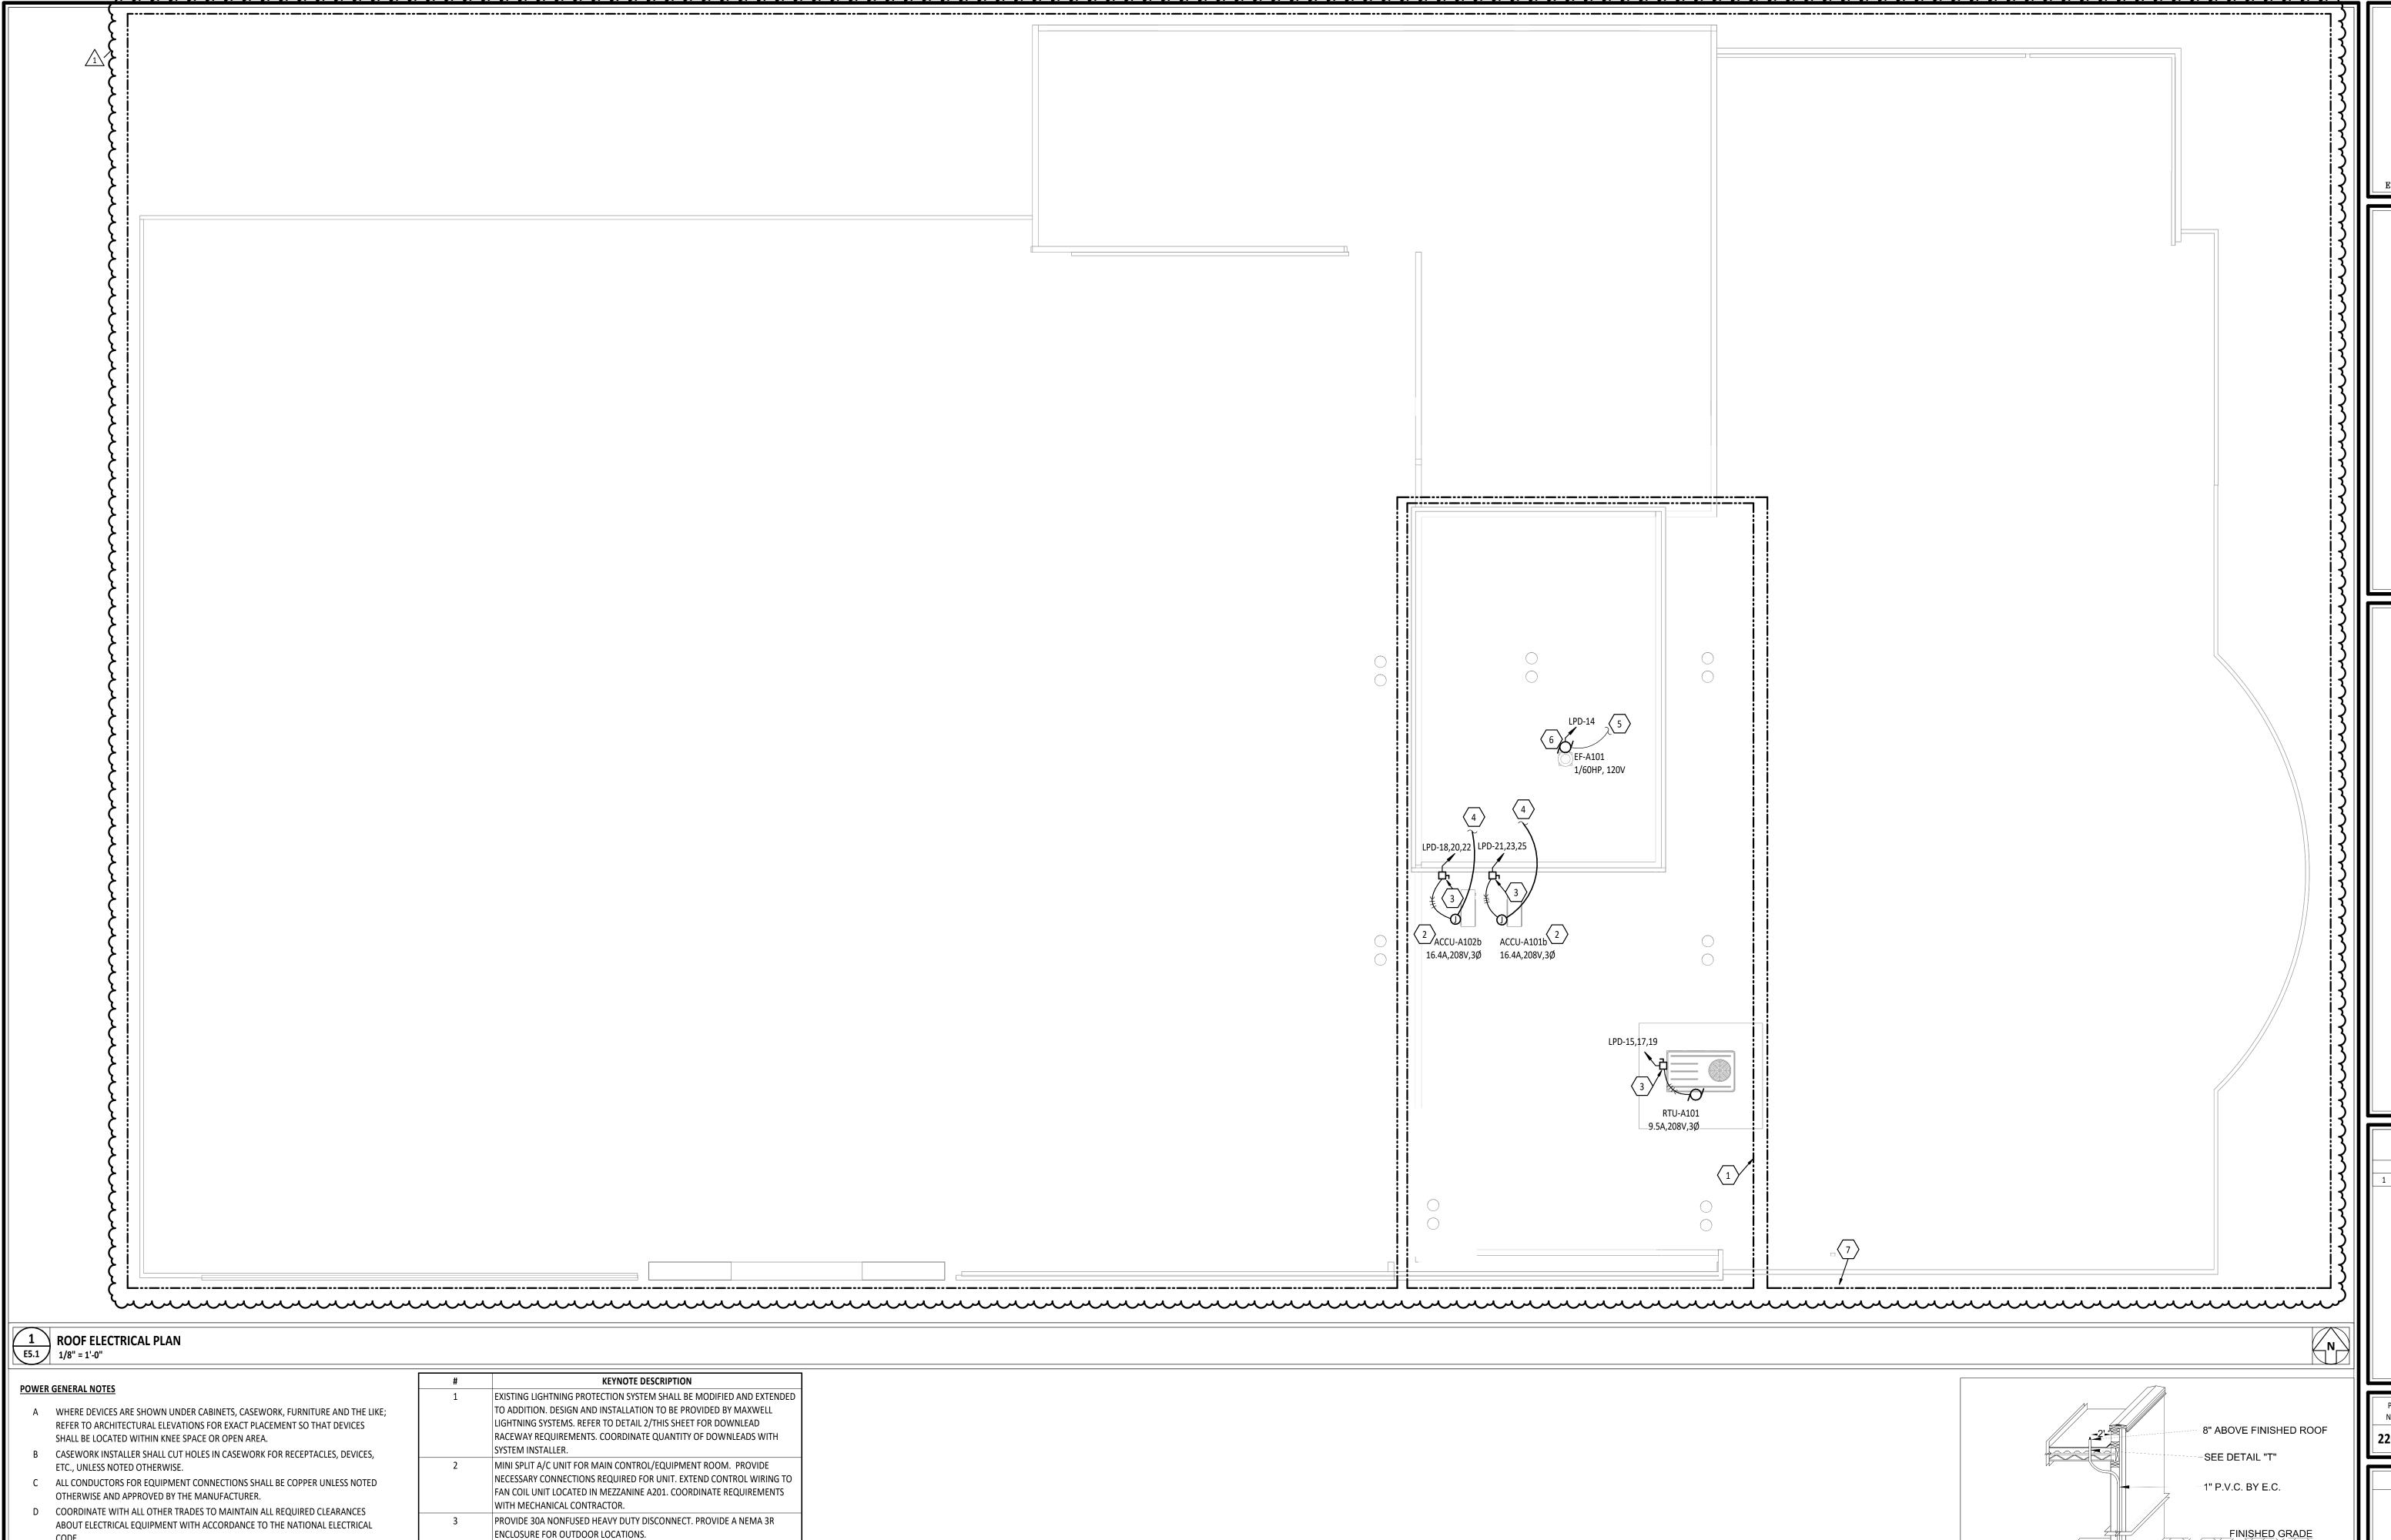

REFER TO DETAIL 3/E5.2 FOR CIRCUIT CONTINUATION.

REFER TO DETAIL 1/E3.1 FOR CIRCUIT CONTINUATION.

INSTALLER AND ROOFING CONTRACTOR.

ROOFTOP MOUNTED EXHAUST FAN PROVIDED WITH INTEGRAL DISCONNECT.

EXHAUST FAN SHALL TURN 'ON'OFF' WITH ROOM LIGHTS IN STORAGE A102.

PROVIDE NECESSARY ROOF PENETRATIONS, CONDUIT, WIRE AND ELECTRICAL

CONNECTIONS. COORDINATE WORK WITH MECHANICAL CONTRACTOR. EXISTING LIGHTNING PROTECTION SYSTEM SHALL BE DISCONNECTED, TEMPORARILY SUPPORTED AND RECONNECTED TO ALLOW FOR ROOF REPLACEMENT IN THE EXISTING PORTION OF THE BUILDING. LIGHTNING

PROTECTION SYSTEM SHALL BE MODIFIED AND RE-CERTIFIED BY MAXWELL

LIGHTNING SYSTEMS. COORDINATE WORK WITH LIGHTNING PROTECTION

E REFER TO MECHANICAL, PLUMBING, AND OTHER APPLICABLE DRAWINGS FOR EXACT


F MAINTAIN ALL FIRE RATINGS WHERE CONDUIT PENETRATES WALL, CEILINGS, AND

EQUIPMENT LOCATIONS.

FLOORS WITH ONLY U.L. LISTED FIRE ASSEMBLIES.

G ALL MOUNTING HEIGHTS REFER TO BOTTOM OF BOX, UNO.

HUELSMAN E-78372 ANDREW P. HUELSMAN LICENSE #E-78372 EXPIRATION DATE: 12/31/2023

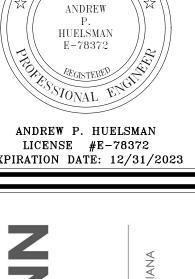

GOVERNMENT INFIL INFIL CITY

ISSUANCES/REVISIONS BID DOCUMENTS ADDENDUM #1

2094.00	AEM	CDS
PROJECT NUMBER:	DRAWN BY:	CHECKED BY:

SHEET TITLE:

ROOF ELECTRICAL PLAN

> SHEET NUMBER: E5.1

2 LIGHTNING PROTECTION DOWNLEAD DETAIL NTS

IRE PROTECTION GENERAL NOTES

- PROVIDE A COMPLETE WET TYPE FIRE PROTECTION SYSTEM AS REQUIRED TO ACCOMMODATE THE FLOOR PLAN AND CEILING TYPES INCLUDING MAINS, BRANCHES, HEADS, VALVES, AND ACCESSORIES AS REQUIRED. THE SYSTEM SHALL BE INSTALLED ACCORDING TO DIVISION 21 SPECIFICATIONS AND RECOMMENDATIONS OF THE STATE BUILDING CODE, LOCAL FIRE DEPARTMENT, AND ALL FEDERAL, STATE, AND LOCAL AUTHORITIES, NFPA, AND FACTORY MUTUAL.
- SPRINKLER PIPING SERVING EXPOSED AREAS SHALL BE ROUTED AS HIGH AS POSSIBLE. SPRINKLER PIPING SHALL BE ROUTED ABOVE THE BOTTOM CHORD OF THE ROOF TRUSSES. COORDINATE ROUTING OF SPRINKLER PIPING WITH BUILDING CONSTRUCTION, DUCTWORK, LIGHTING, AND ALL OTHER UTILITIES.
- PROVIDE BOLT OR SCREW FASTENED WIRE GUARDS FOR ALL SPRINKLER PIPES IN THE GYMNASIUMS AND MECHANICAL ROOMS.
- D COORDINATE THE LOCATION OF SPRINKLER HEADS AND PIPING WITH BUILDING CONSTRUCTION, DUCTWORK AND MECHANICAL PIPING IN MEZZANINES. ROUTE SPRINKLER PIPING ABOVE THE BOTTOM CHORD OF THE ROOF TRUSSES IN THE MEZZANINE. DO NOT SUPPORT SPRINKLER PIPING FROM DUCTWORK OR EQUIPMENT.

FIRE PROTECTION GENERAL NOTES

- E FIRE PROTECTION SPRINKLER MAINS AND ZONES SHALL BE ROUTED AS DENOTED ON DRAWINGS. ANY ALTERNATE ROUTING MUST BE APPROVED BY THE ARCHITECT/ENGINEER. THIS CONTRACTOR SHALL DETERMINE THE ACTUAL PIPE SIZING AND ROUTING REQUIRED AND COORDINATE WORK WITH ALL OTHER TRADES TO AVOID CONFLICTS.
- F THE SPRINKLER SYSTEM SHALL BE DESIGNED BASED UPON ACTUAL WATER FLOW TEST DATA OBTAINED AT OR NEAR THE JOB SITE.
- G DIVISION 21 CONTRACTOR SHALL COORDINATE WITH THE ELECTRICAL CONTRACTOR FOR PROPER INSTALLATION OF THE FIRE PROTECTION SYSTEMS ALARM DEVICES INVOLVED WITH FIRE SPRINKLER SYSTEM.
- H ALL SPRINKLER SYSTEM PIPING SHALL BE CONCEALED ABOVE THE SUSPENDED CEILING SYSTEM, UNLESS NOTED OTHERWISE. WRITTEN AUTHORIZATION SHALL BE OBTAINED FROM THE ARCHITECT PRIOR TO EXPOSING ANY PIPING IN ANY ROOM WHICH HAS A SUSPENDED CEILING.

FIRE PROTECTION GENERAL NOTES


- AN INSPECTOR'S TEST CONNECTION SHALL BE PROVIDED FOR EACH FIRE SPRINKLER ZONE. THIS CONTRACTOR SHALL PROVIDE FIXED PIPING FROM THE TEST CONNECTION TO AN ADEQUATELY SIZED RECEPTOR WHICH IS CAPABLE OF ACCEPTING THE FULL FLOW OF THE TEST. EXTERIOR DISCHARGE OF THE TEST CONNECTION SHALL BE PERMITTED ONLY BY SPECIFIC WRITTEN INSTRUCTION FROM THE ENGINEER.
- J SHOW ALL ROOM NUMBERS ON SHOP DRAWING PLANS.
- K ROUTE SPRINKLER PIPING SUCH THAT IT DOES NOT RUN ABOVE ELECTRICAL PANELS, SWITCHGEAR, OR SIMILAR EQUIPMENT. SPRINKLER MAINS SHALL NOT RUN THROUGH ELECTRICAL OR COMMUNICATION ROOMS. SPRINKLER HEADS IN THESE ROOMS SHALL BE SERVED BY A DEDICATED BRANCH LINE FOR EACH ROOM.
- L PROVIDE A COMPLETE LIGHT HAZARD WET-TYPE SPRINKLER SYSTEM FOR ALL FIRE ZONES AS SHOWN ON THE DRAWINGS. PROVIDE ORDINARY HAZARD IN SPACE WHERE REQUIRED. INSTALL SPRINKLER SYSTEM PER NFPA 13, STATE AND LOCAL FIRE MARSHALL AND DIVISION 21 OF THE SPECIFICATIONS.

FIRE PROTECTION GENERAL NOTES

- M PROVIDE ALTERATIONS TO THE EXISTING FIRE PROTECTION SYSTEM AS REQUIRED TO ACCOMMODATE THE NEW FLOOR PLAN AND NEW CEILING TYPES. PROVIDE A COMPLETE WET TYPE SYSTEM INCLUDING NEW MAINS, BRANCHES, HEADS, VALVES, AND ACCESSORIES AS REQUIRED. REUSE EXISTING SYSTEM EQUIPMENT WHERE APPLICABLE. THE SYSTEM SHALL BE INSTALLED ACCORDING TO MANUFACTURER'S SPECIFICATIONS AND RECOMMENDATIONS AND AS PER REQUIREMENTS OF THE STATE BUILDING CODE, LOCAL FIRE DEPARTMENT, AND ALL FEDERAL, STATE, AND LOCAL AUTHORITIES, NFPA, AND FACTORY MUTUAL.
- N THE BUILDINGS COMPLETE OPERATIONAL FIRE PROTECTION SYSTEMS SHALL REMAIN IN PLACE. THIS CONTRACTOR SHALL REPAIR ANY DAMAGE TO THIS SYSTEM CREATED BY THE REMOVAL OF ANY OTHER MECHANICAL SYSTEMS OR COMPONENTS.
- O THIS CONTRACTOR SHALL COORDINATE PHASING OF SPRINKLER WORK WITH ALL OTHER CONTRACTORS PRIOR TO STARTING WORK.
- P THIS CONTRACTOR SHALL PREPARE HYDRAULIC CALCULATIONS BASED UPON THE CONFIGURATION OF THE ACTUAL SYSTEM DESIGN AS SHOWN ON THIS CONTRACTOR'S SHOP DRAWINGS.

FIRE PROTECTION GENERAL NOTES

- Q THIS CONTRACTOR SHALL PROVIDE ALL ADDITIONAL SPRINKLER HEADS AS REQUIRED TO ENSURE AN APPROVED FIRE PROTECTION SYSTEM AT NO ADDITIONAL COST TO THE
- R PROVIDE AUXILIARY DRAIN VALVES AS REQUIRED BY NFPA. AUXILIARY DRAINS SHALL BE EXPOSED WITH 1" DRAIN VALVES. WHEN 5 OR MORE GALLONS ARE TRAPPED, THIS CONTRACTOR SHALL PROVIDE FIXED PIPING TO AN ADEQUATELY SIZED RECEPTOR WHICH IS CAPABLE OF ACCEPTING THE FULL FLOW OF THE DRAIN. WHEN LESS THAN 5 GALLONS ARE TRAPPED, A HOSE BIB SHALL BE PROVIDED AT THE DRAIN VALVE.
- AUXILIARY DRAINS SHALL NOT BE LOCATED ABOVE PLASTER OR GYPSUM BOARD CEILING SYSTEMS. ONLY BY A SPECIFIC WRITTEN INSTRUCTION FROM THE ENGINEER WILL A VARIANCE BE PROVIDED.

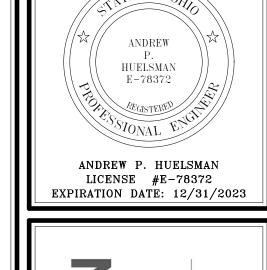


RNMEN ш Ш TIPP CITY

SHEET TITLE:


FIRE PROTECTION **PLAN**

FP1.1

KEYNOTE DESCRIPTION PROVIDE A SELF-CONTAINED FIRE SUPPRESSION SYSTEM THAT IS SUITABLE FOR USE IN TECHNOLOGY EQUIPMENT ROOMS. SYSTEM SHALL BE EQUAL TO FM200 SYSTEM, SHALL BE FM AND UL LISTED AND BE INSTALLED PER NFPA 2001 AND ALL STATE AND LOCAL FIRE CODES. CONNECT SYSTEM TO SMOKE AND HEAT DETECTOR. COORDINATE EXACT FIRE ALARM, POWER REQUIREMENTS AND SPACE WITH GENERAL, ELECTRICAL, FIRE ALARM AND TECHNOLOGY CONTRACTORS. REFER TO SPECIFICATIONS FOR ADDITIONAL INFORMATION. FIRE PROTECTION CONTRACTOR SHALL PROVIDE RELAYS FOR CONTROL OF DUCT PENETRATION DAMPERS AND SHALL WIRE TO THE FM-200 PANEL FOR CONTROL. EXISTING SPRINKLER RISER BELL LOCATED IN THIS APPROXIMATE LOCATION TO BE RELOCATED TO FRONT SIDE OF BUILDING. CONNECT TO EXISTING FIRE SUPPRESSION SYSTEM IN THIS APPROXIMATE LOCATION. SIZE PER HYDRAULIC CALCULATIONS. CONTRACTOR TO VERIFY EXISTING PIPE SIZE PRIOR TO BIDDING.

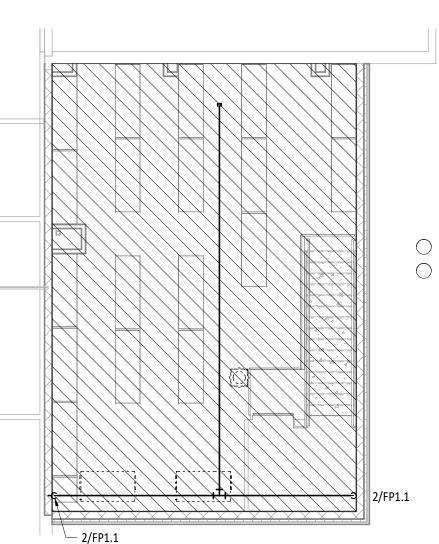




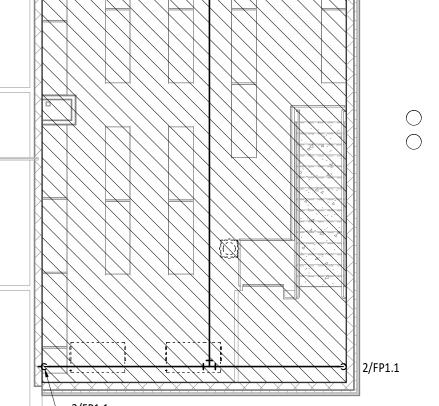

FIRE PROTECTION PLAN
1/8" = 1'-0"

1 FIRE PROTECTION PLAN - MEZZANINE NTS

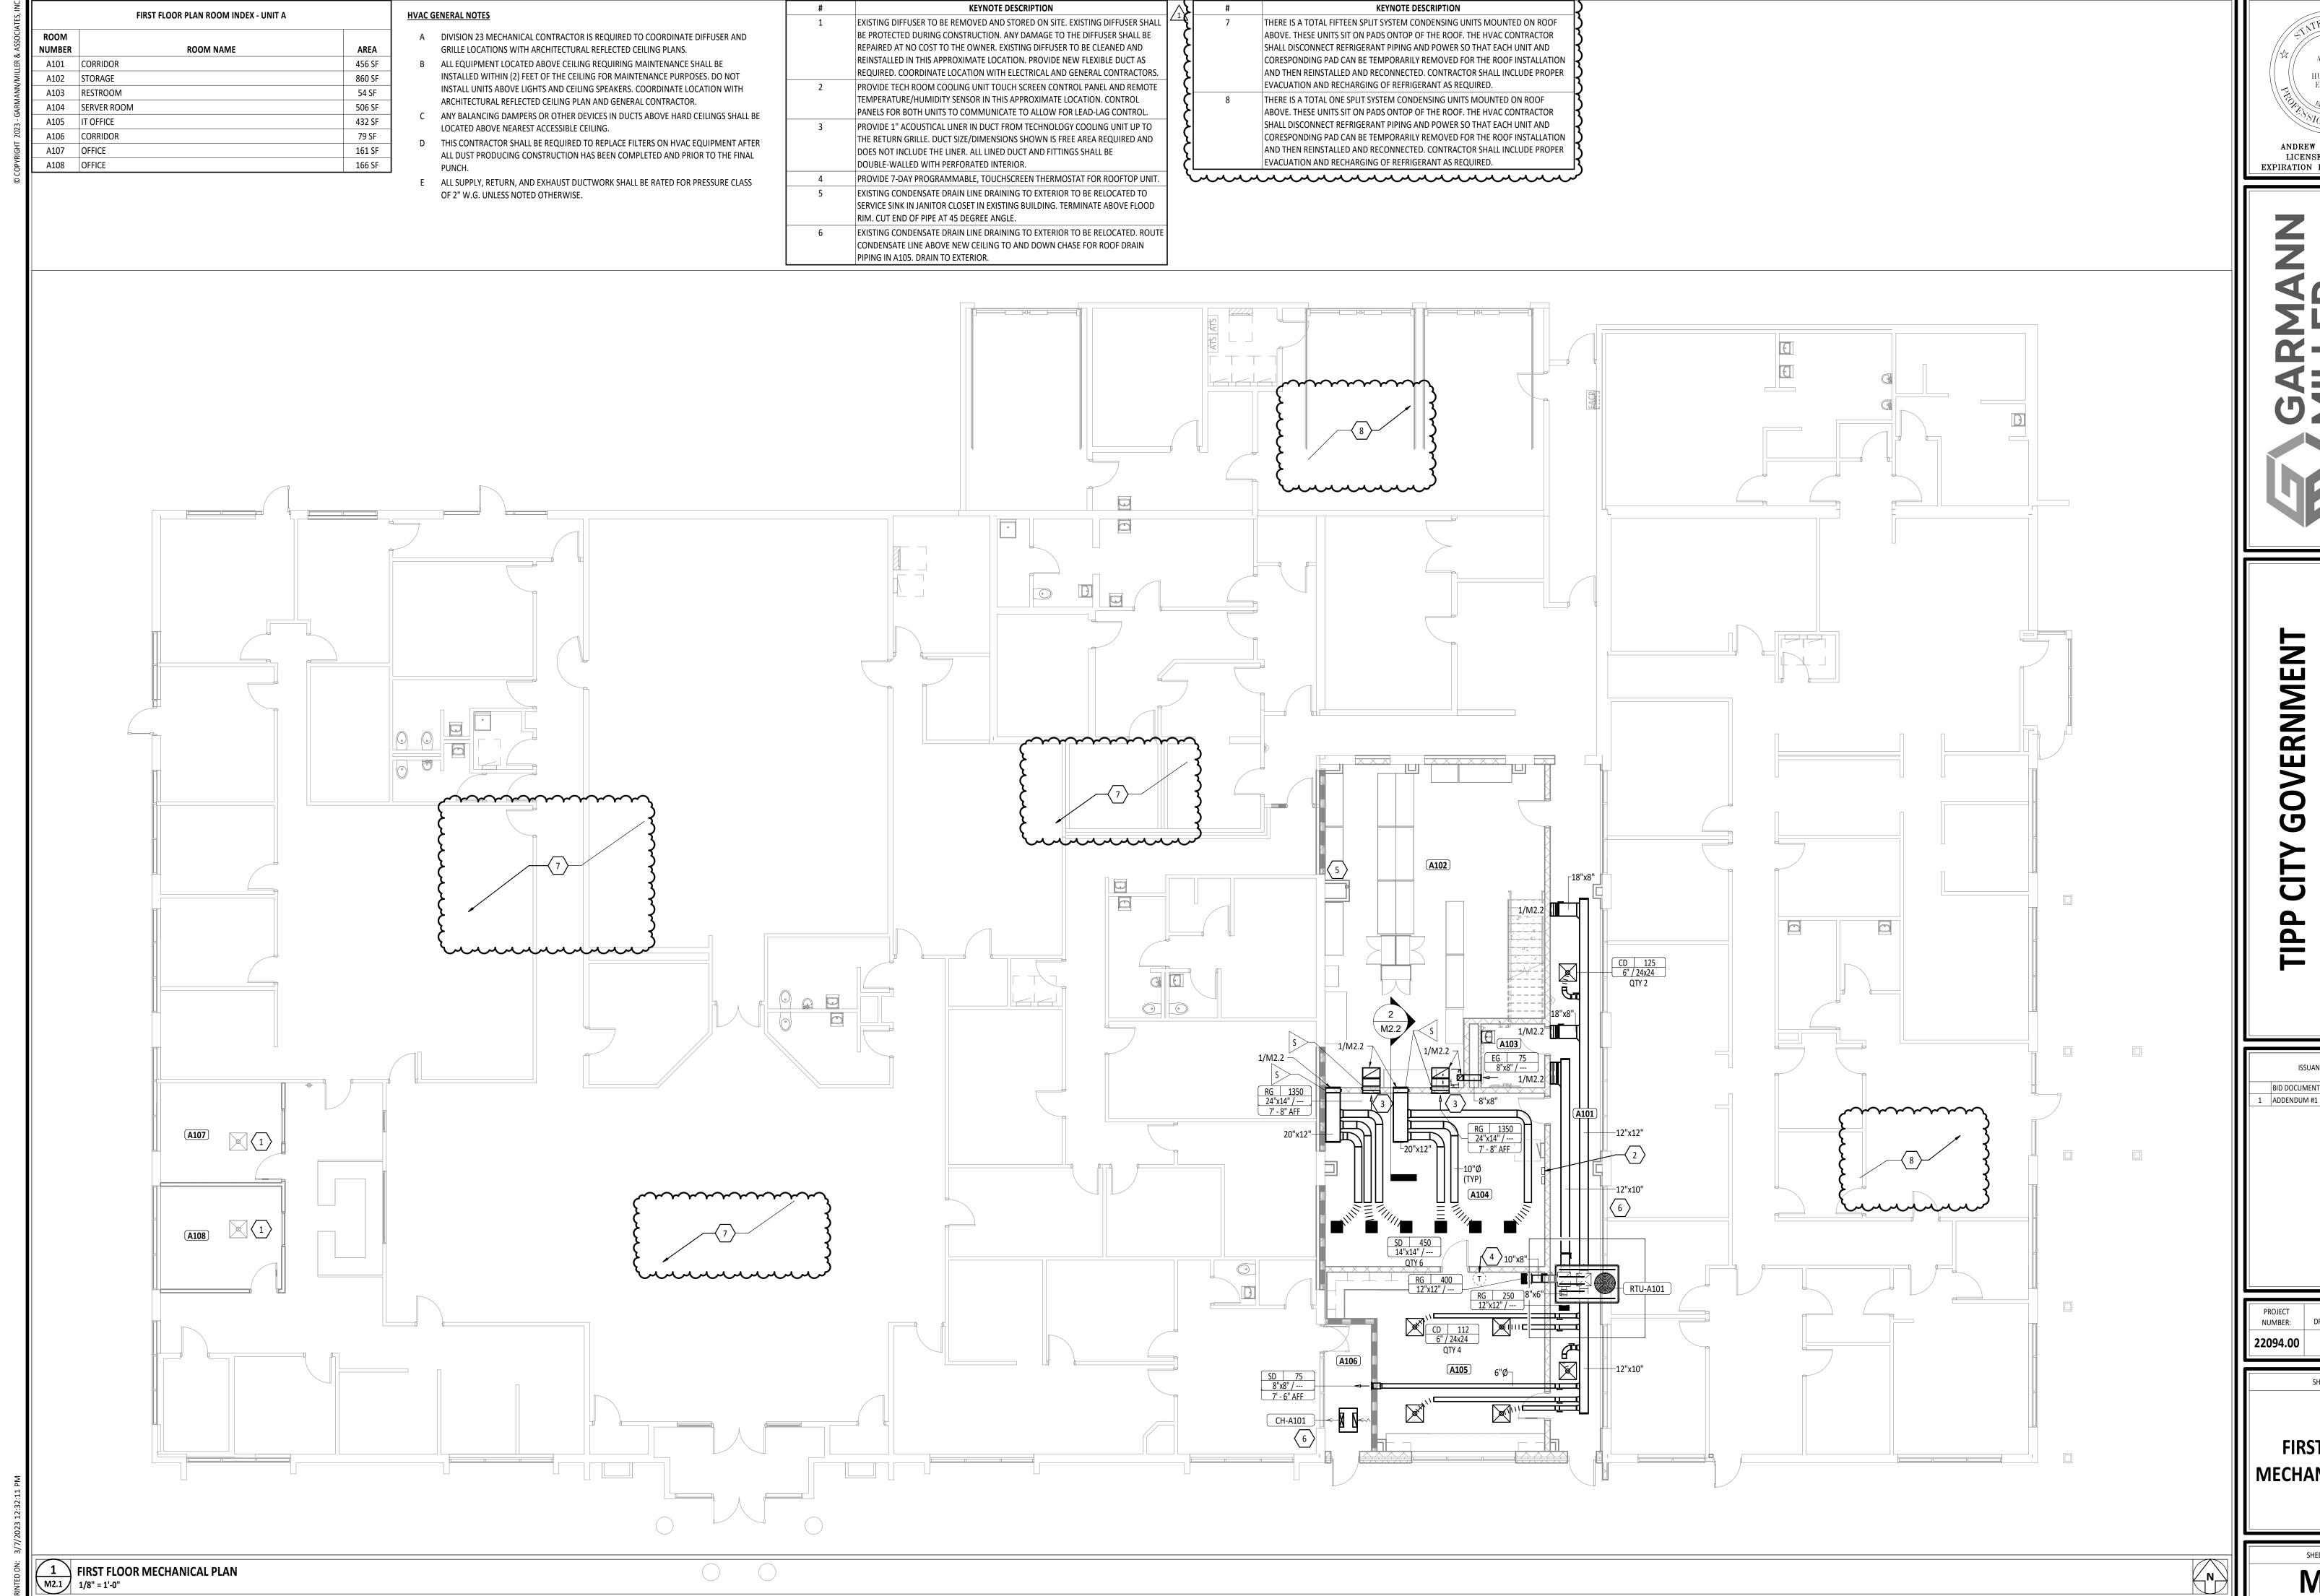

<u>^^^^^^^</u>

ANDREW HUELSMAN E-78372 ANDREW P. HUELSMAN

LICENSE #E-78372 EXPIRATION DATE: 12/31/2023

INFIL

SHEET TITLE:

FIRST FLOOR **MECHANICAL PLAN**

M2.1