FORT LORAMIE LOCAL SCHOOLS LOCKER ROOM BUILDING


600 EAST PARK STREET, FORT LORAMIE, OHIO

CONSTRUCTION DOCUMENT

12/11/2025

CODE PLANS DEMO PLAN / FLOOR PLAN / DETAILS / DOOR SCHEDULE ROOF PLAN FIRST FLOOR EQUIPMENT & FINISHES PLAN MECHANICAL AND PLUMBING PLAN ELECTRICAL DEMOLITION PLAN ELECTRICAL DETAILS, PANEL AND LUMINAIRE SCHEDULES ELECTRICAL PLAN ENLARGED TECHNOLOGY ROOMS TECHNOLOGY CABLING PLAN

SHEET INDEX

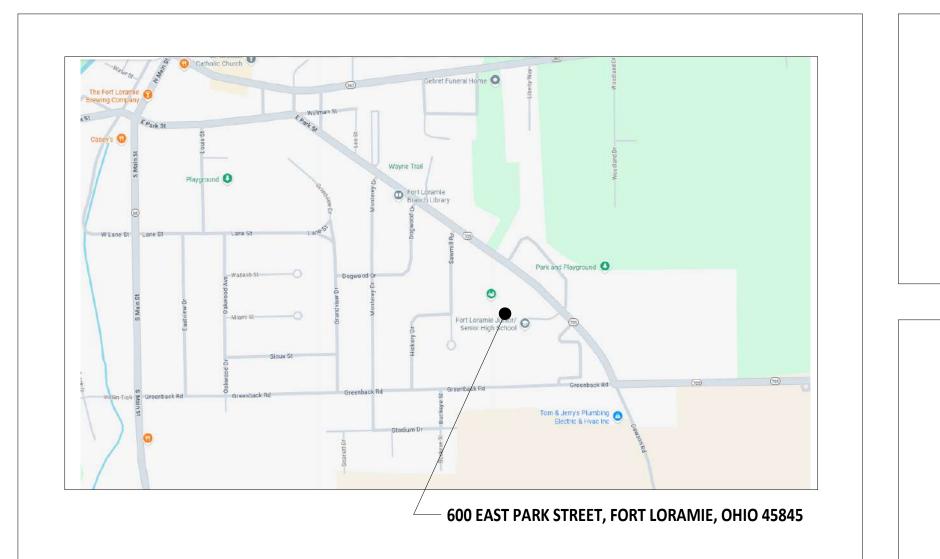





BOARD OF EDUCATION

...MIKE SIEGEL **BOARD PRESIDENT..** ...LISA RUHENKAMP BOARD VICE PRESIDENT. **BOARD MEMBER..** ...VERN SIEGEL ...LYNN DELOYE **BOARD MEMBER.. BOARD MEMBER..** ..BRAD RETHMAN

ADMINISTRATION

SUPERINTENDENT. ..DANIEL HOLLAND HIGH SCHOOL PRINCIPAL ..KREG HOLLENBACHER ATHLETIC DIRECTOR.. ..MITCH WESTERHEIDE

ARCHITECTS

MECHANICAL, ELECTRICAL & PLUMBING ENGINEERS

LANDSCAPE ARCHITECTS

TECHNOLOGY DESIGNERS

INTERIOR DESIGNERS

MASTER PLANNING



38 SOUTH LINCOLN DRIVE MINSTER, OHIO 45865 419.628.4240


PO BOX 71

1156 DUBLIN ROAD SUITE 102 COLUMBUS, OHIO 43215 614.502.4240

275 VETERANS WAY SUITE 200 CARMEL, INDIANA 46032 317.343.9343

1690 BROADWAY SUITE 19-455 FORT WAYNE, INDIANA 260.299.4240

LICENSE #1416052 EXPIRATION DATE: 12/31/2025

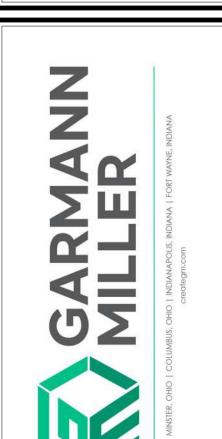



SCHO

CONSTRUCTION DOCUMENTS | 12/11/202

NUMBER: DRAWN BY: CHECKED BY:

COVER SHEET

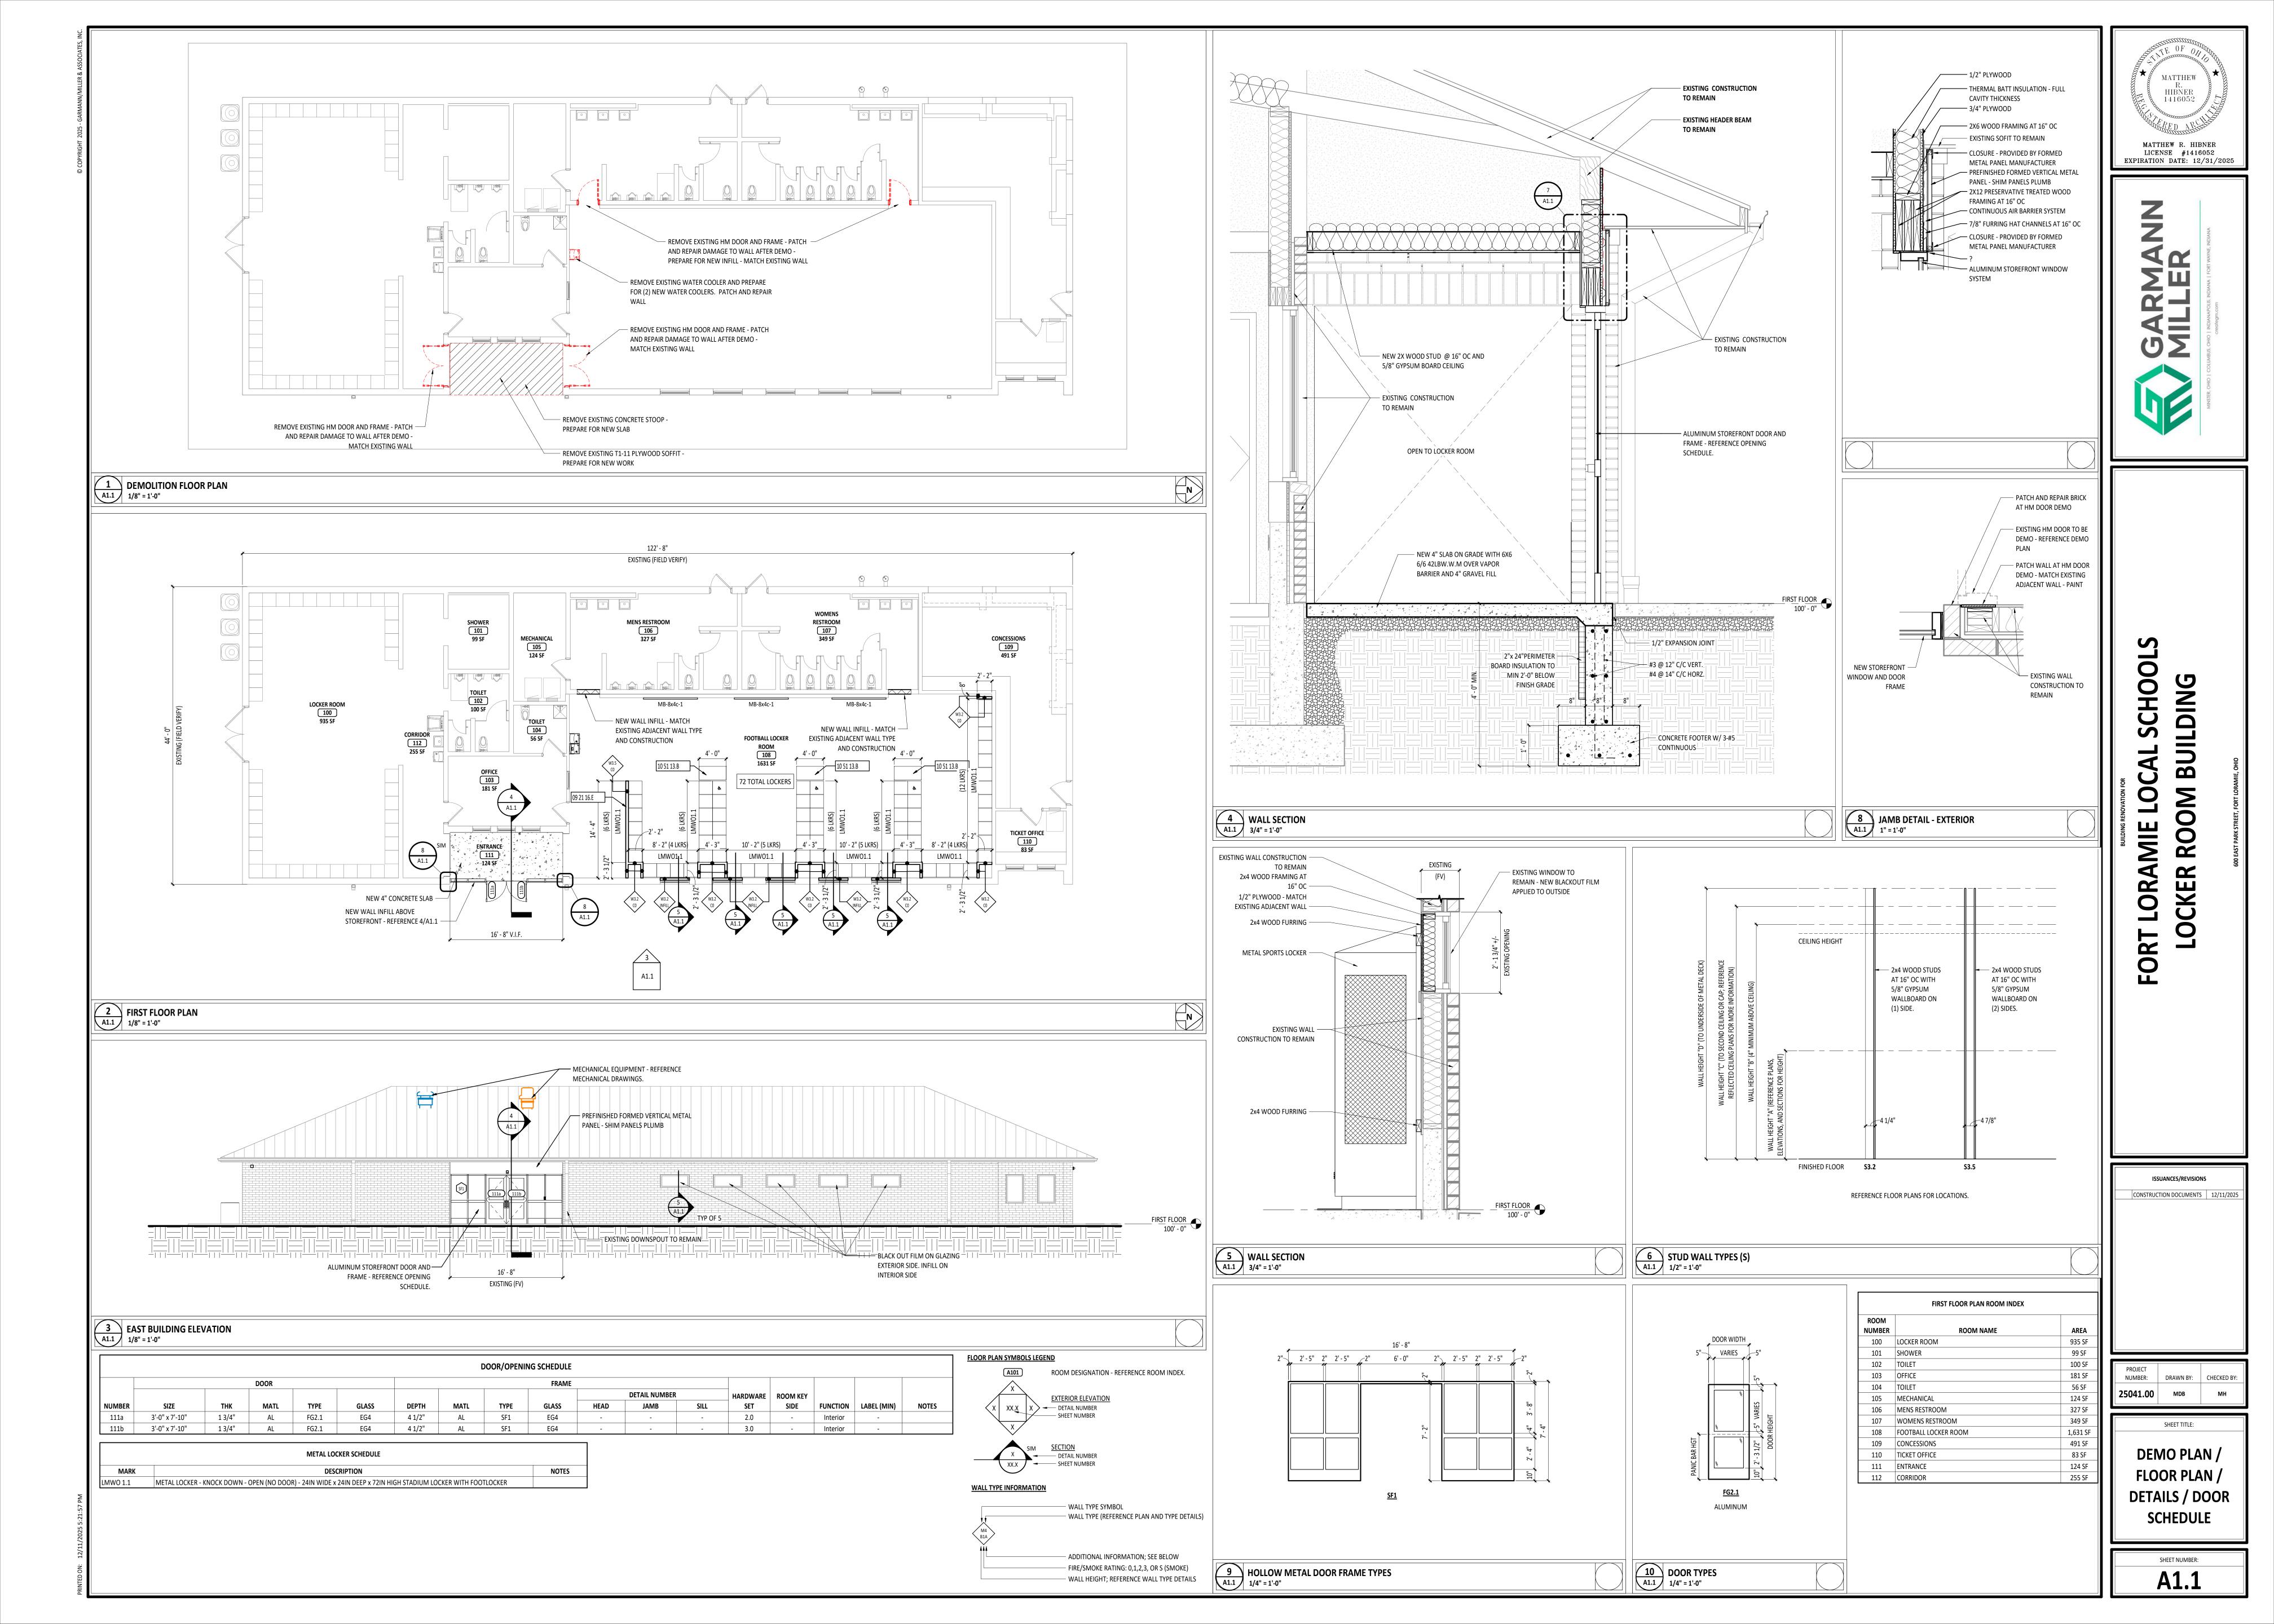

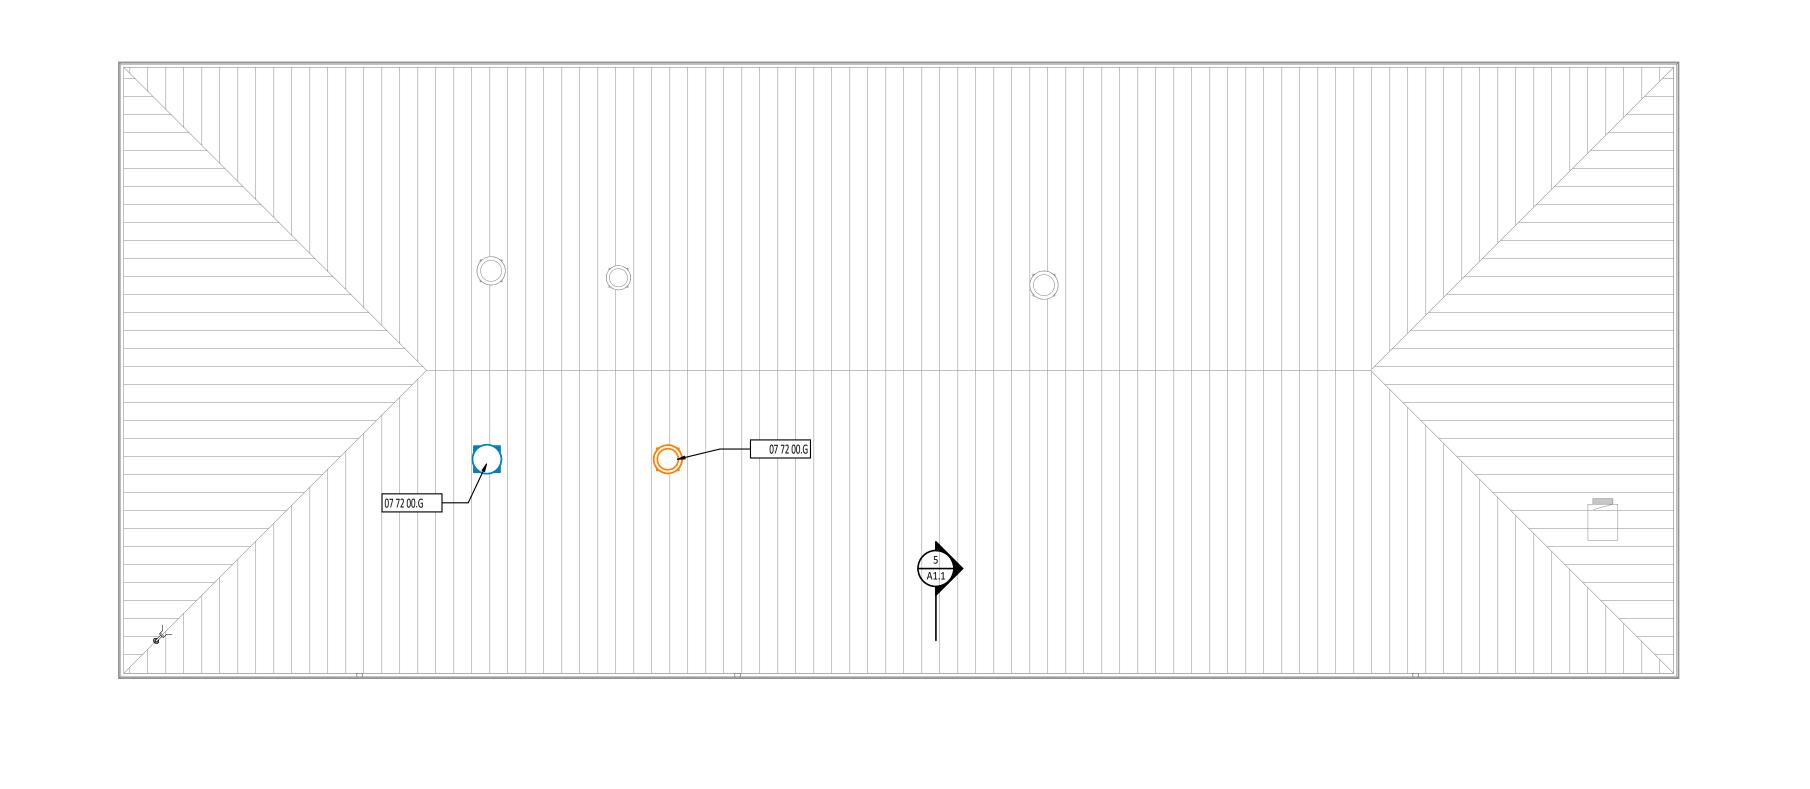

22 10 05.A PLUMBING VENT - REFERENCE
PLUMBING DRAWINGS.

07 92 00.B SEALANT

PIPE FLASHING BY 07 6100.

SYSTEM WITH CODE COMPLIANT

INSULATION - STAGGER JOINTS.

DRAWINGS.

ANCHORAGES, TRIM AND FLASHING AS



A PROVIDE FLASHING IN ACCORDANCE WITH THE SMACNA ARCHITECTURAL SHEET

<u>DIVISIONAL KEYNOTE DESIGNATION</u> - REFERENCE KEYNOTE

- METAL MANUAL LATEST EDITION. B REFER TO MANUFACTURER FOR ROOF INSTALLATION DETAILS.
- C ALL WOOD BLOCKING AT ROOF PENETRATIONS SHALL BE PRESERVATIVE TREATED. D PROVIDE WELDED CURB FLASHING FOR PENETRATIONS IN METAL ROOF - REFERENCE
- ROOF DETAILS. E PROVIDE CRICKETS WITH TAPERED FLASHING AT MECHANICAL OPENINGS.

ROOF PLAN SYMBOLS LEGEND

FLUE DESIGNATION VENT DESIGNATION

SCHEDULE AND SPECIFICATIONS FOR ADDITIONAL INFORMATION. --- KEYNOTE DESIGNATION — SPECIFICATION SECTION

DETAIL NUMBER

ROOF PLAN MATERIAL PATTERNS LEGEND

KEYNOTE DESCRIPTION 05 12 00.E | SUPPORT STEEL ANGLE - PAINT IF EXPOSED TO VIEW - REFERENCE STRUCTURAL

05 31 00.A STEEL DECK - REFERENCE STRUCTURAL DRAWINGS.

05 50 00.A 20 GAUGE SHEET METAL CLOSURE - FOLLOW PROFILE OF METAL DECK (TYPICAL AT LOCATIONS WHERE SPRAY APPLIED FOAM INSULATION IS EXPOSED TO VIEW) - PAINT.

06 10 00.D | WOOD BLOCKING/NAILER 07 21 29.A SPRAY APPLIED FOAM INSULATION

07 22 16.A (2) LAYERS OF 2 1/2" ROOF BOARD INSULATION - STAGGER JOINTS. 07 61 00.A STANDING SEAM METAL ROOFING SYSTEM WITH CODE COMPLIANT ANCHORAGES,

TRIM AND FLASHING AS REQUIRED 07 61 00.C ROOF UNDERLAYMENT


07 61 00.J ROOF CRICKET

07 62 00.G RAKE FLASHING - PROVIDED BY ROOFING MANUFACTURER 07 72 00.A ROOF CURB - REFERENCE ROOF DETAILS.

07 72 00.G | NEW ROOF PENETRATION - OPENING LOCATION TO COORDINATED WITH OWNER. FLASHING TO BE INSTALLED AROUND PENETRATIONS PER MANUFACTURER RECOMMENDATIONS.

07 92 00.B | SEALANT 22 10 05.A PLUMBING VENT - REFERENCE PLUMBING DRAWINGS.


1 A5.1 ROOF PLAN 1/8" = 1'-0"

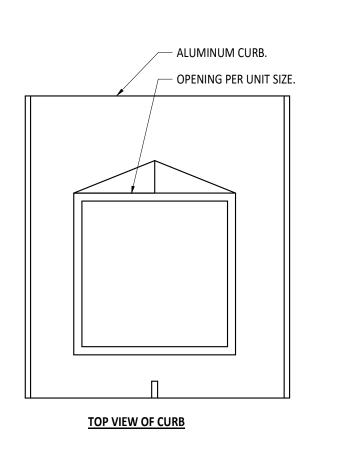



— STAINLESS STEEL CLAMPING RING. 07 61 00.J ROOF CRICKET 07 61 00.A STANDING SEAM METAL ROOFING 07 22 16.A (2) LAYERS OF 2 1/2" ROOF BOARD 05 31 00.A STEEL DECK - REFERENCE STRUCTURAL 07 21 29.A SPRAY APPLIED FOAM INSULATION NOTE:
METAL ROOF MANUFACTURER AND DIVISION 22 TO COORDINATE EXACT LOCATION OF ROOF OPENING AND SIZE.


VENT STACK - INSTALL IN

CENTER OF METAL ROOF PANEL.

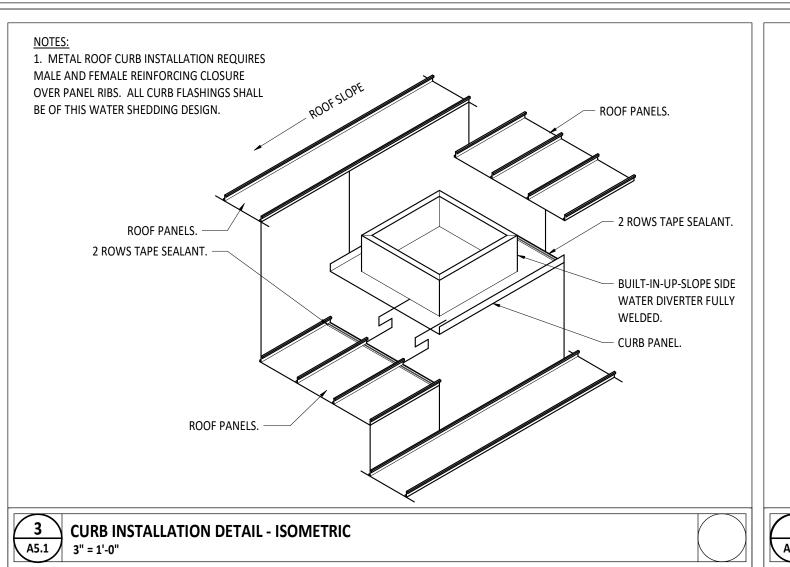

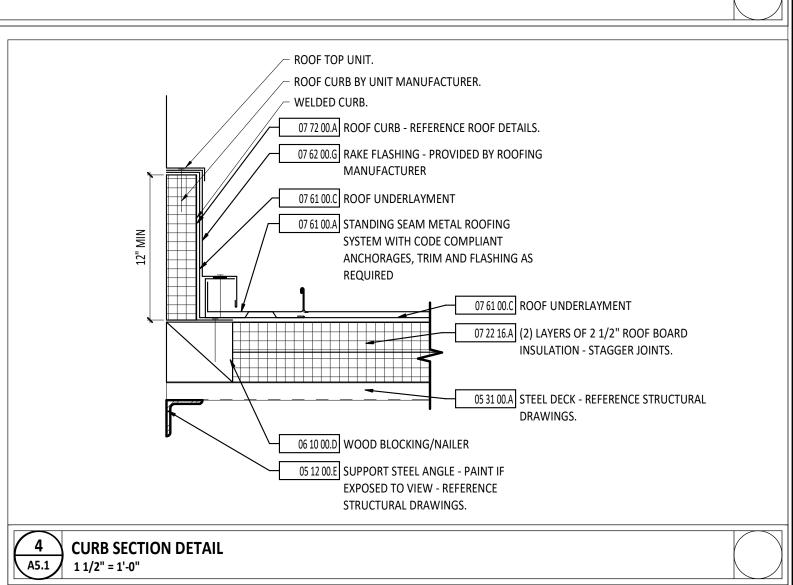


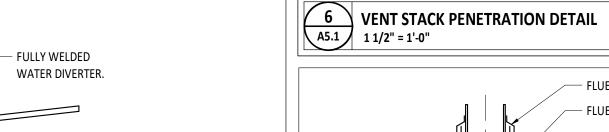

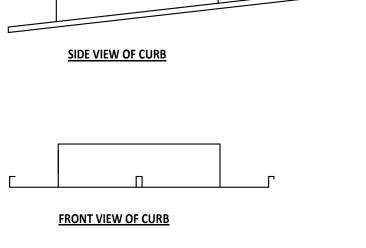

NOTES:
1. CURB TO BE WELDED WATERTIGHT.

2. CURB TO MATCH PROFILE OF EXISTING METAL PANELS.

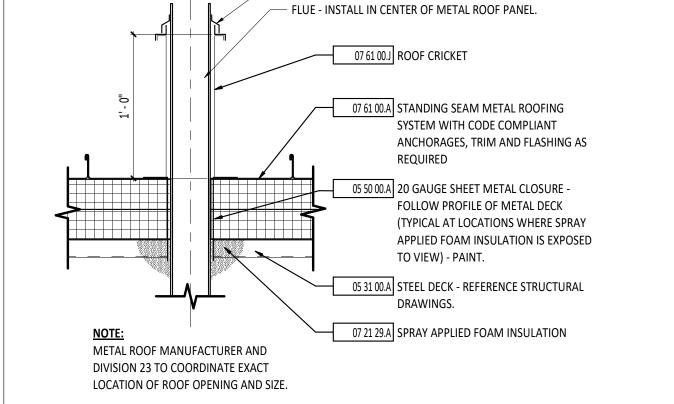

— FLUE ROOF ASSEMBLY BY DIVISION 23.

5 FLUE PENETRATION DETAIL 1 1/2" = 1'-0"

ISSUANCES/REVISIONS CONSTRUCTION DOCUMENTS 12/11/2025

SCHOOL

0

LORAMIE

FORT

MATTHEW

HIBNER


MATTHEW R. HIBNER LICENSE #1416052

EXPIRATION DATE: 12/31/2025


ROOF PLAN

SHEET NUMBER: **A5.1**

2 CURB DETAIL 3" = 1'-0"

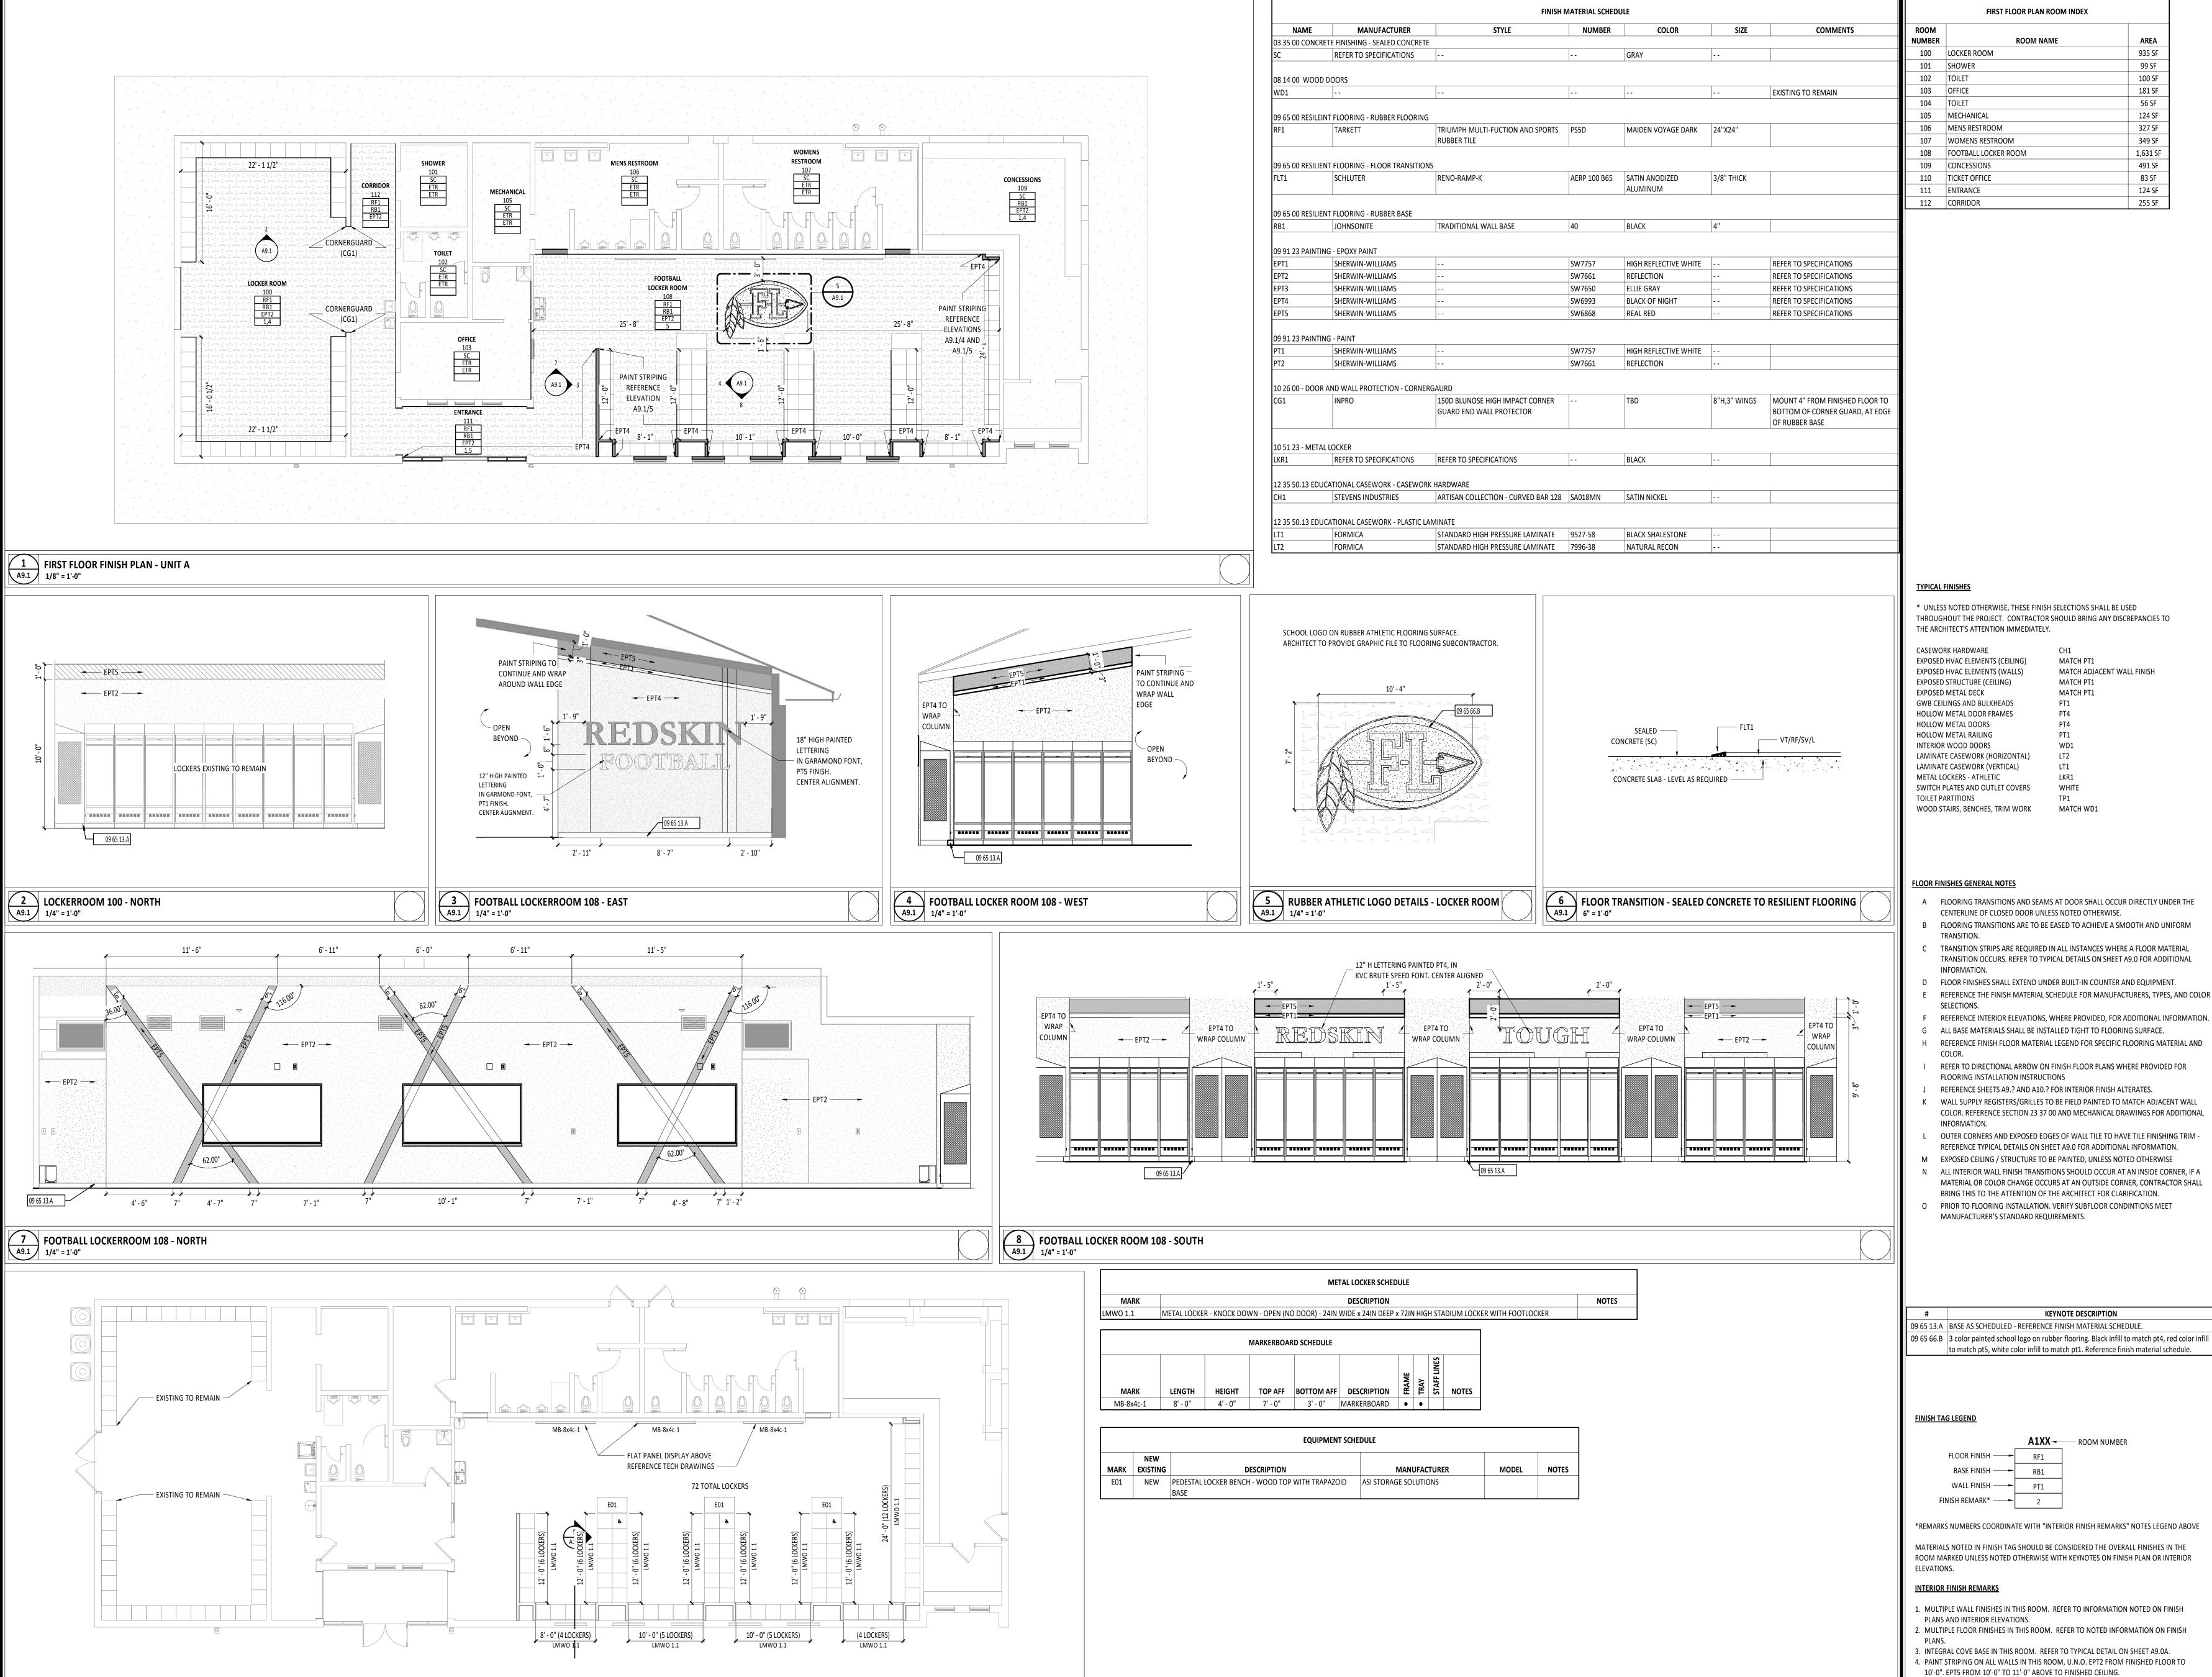

9 FIRST FLOOR EQUIPMENT PLAN - UNIT A 1/8" = 1'-0"

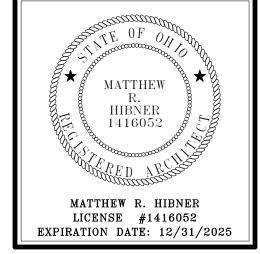

935 SF

99 SF

100 SF

181 SF

56 SF

124 SF

327 SF

349 SF

1,631 SF

491 SF

83 SF

124 SF

255 SF



OCKER.

SCHOO

O

0

ORT

FDING

MATCH ADJACENT WALL FINISH MATCH PT1 MATCH PT1

MATCH WD1

MATCH PT1

LAMINATE CASEWORK (HORIZONTAL) SWITCH PLATES AND OUTLET COVERS

FLOOR FINISHES GENERAL NOTES

- CENTERLINE OF CLOSED DOOR UNLESS NOTED OTHERWISE. FLOORING TRANSITIONS ARE TO BE EASED TO ACHIEVE A SMOOTH AND UNIFORM
- TRANSITION STRIPS ARE REQUIRED IN ALL INSTANCES WHERE A FLOOR MATERIAL TRANSITION OCCURS. REFER TO TYPICAL DETAILS ON SHEET A9.0 FOR ADDITIONAL
- FLOOR FINISHES SHALL EXTEND UNDER BUILT-IN COUNTER AND EQUIPMENT.
- REFERENCE THE FINISH MATERIAL SCHEDULE FOR MANUFACTURERS, TYPES, AND COLOR
- F REFERENCE INTERIOR ELEVATIONS, WHERE PROVIDED, FOR ADDITIONAL INFORMATION.
- G ALL BASE MATERIALS SHALL BE INSTALLED TIGHT TO FLOORING SURFACE. H REFERENCE FINISH FLOOR MATERIAL LEGEND FOR SPECIFIC FLOORING MATERIAL AND
- REFER TO DIRECTIONAL ARROW ON FINISH FLOOR PLANS WHERE PROVIDED FOR FLOORING INSTALLATION INSTRUCTIONS REFERENCE SHEETS A9.? AND A10.? FOR INTERIOR FINISH ALTERATES.
- WALL SUPPLY REGISTERS/GRILLES TO BE FIELD PAINTED TO MATCH ADJACENT WALL COLOR. REFERENCE SECTION 23 37 00 AND MECHANICAL DRAWINGS FOR ADDITIONAL
- OUTER CORNERS AND EXPOSED EDGES OF WALL TILE TO HAVE TILE FINISHING TRIM -REFERENCE TYPICAL DETAILS ON SHEET A9.0 FOR ADDITIONAL INFORMATION.
- EXPOSED CEILING / STRUCTURE TO BE PAINTED, UNLESS NOTED OTHERWISE

KEYNOTE DESCRIPTION

- MATERIAL OR COLOR CHANGE OCCURS AT AN OUTSIDE CORNER, CONTRACTOR SHALL BRING THIS TO THE ATTENTION OF THE ARCHITECT FOR CLARIFICATION.
- PRIOR TO FLOORING INSTALLATION. VERIFY SUBFLOOR CONDINTIONS MEET MANUFACTURER'S STANDARD REQUIREMENTS.

ISSUANCES/REVISIONS CONSTRUCTION DOCUMENTS 12/11/2025

NUMBER:

25041.00 MEK

A1XX ROOM NUMBER

WALL FINISH —

*REMARKS NUMBERS COORDINATE WITH "INTERIOR FINISH REMARKS" NOTES LEGEND ABOVE

MATERIALS NOTED IN FINISH TAG SHOULD BE CONSIDERED THE OVERALL FINISHES IN THE ROOM MARKED UNLESS NOTED OTHERWISE WITH KEYNOTES ON FINISH PLAN OR INTERIOR

INTERIOR FINISH REMARKS

FOR LOCATION.


- 1. MULTIPLE WALL FINISHES IN THIS ROOM. REFER TO INFORMATION NOTED ON FINISH
- PLANS AND INTERIOR ELEVATIONS.
- 3. INTEGRAL COVE BASE IN THIS ROOM. REFER TO TYPICAL DETAIL ON SHEET A9.0A. 4. PAINT STRIPING ON ALL WALLS IN THIS ROOM, U.N.O. EPT2 FROM FINISHED FLOOR TO 10'-0". EPT5 FROM 10'-0" TO 11'-0" ABOVE TO FINISHED CEILING.
- 5. PAINT STRIPING IN THIS ROOM, U.N.O. EPT2 FROM FINISHED FLOOR TO 9'-8". EPT1 FROM 9'-8" TO 9'-11". EPT5 FROM 9'-11" ABOVE TO FINISHED CEILING. REFERENCE A9.1 SHEET


FIRST FLOOR **EQUIPMENT & FINISHES PLAN**

DRAWN BY: CHECKED BY:

SHEET TITLE:

SHEET NUMBER: A9.1

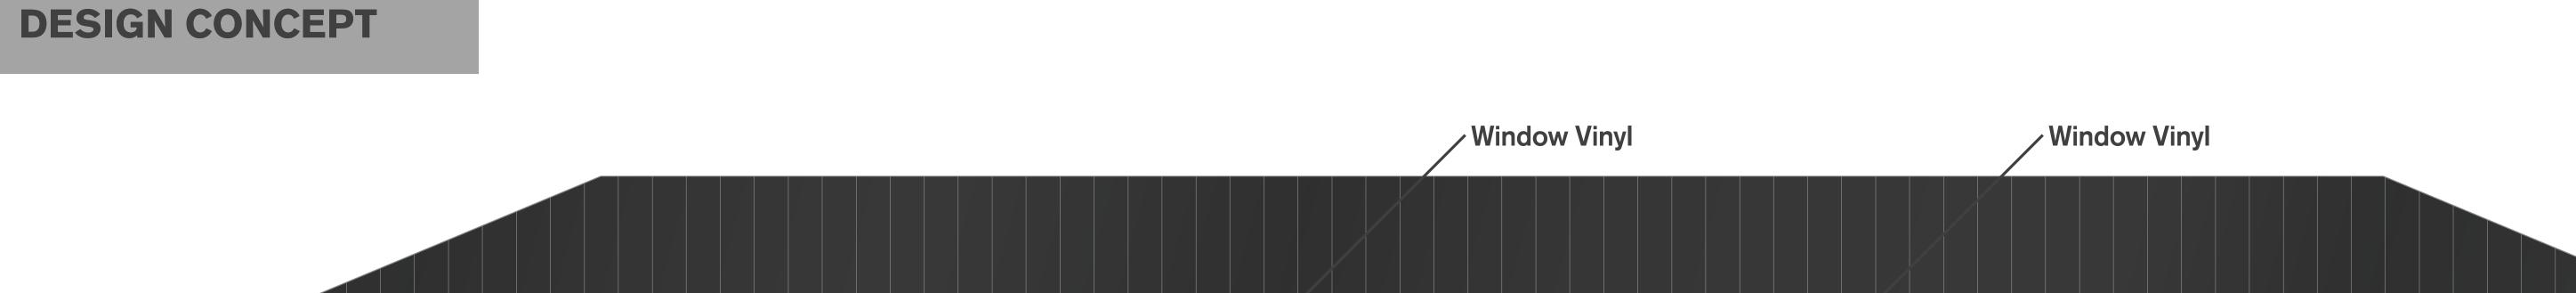

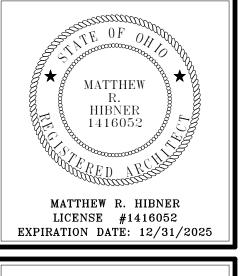



SCHOOLS

CONSTRUCTION DOCUMENTS 12/11/2025

SIGNAGE

DETAIL

SHEET NUMBER: A12.1


ELEVATION



WINDOW VINYL - DETAIL 80/20 WINDOW PERF, ADHESIVE BACKING



WINDOW VINYL - DETAIL 80/20 WINDOW PERF, ADHESIVE BACKING

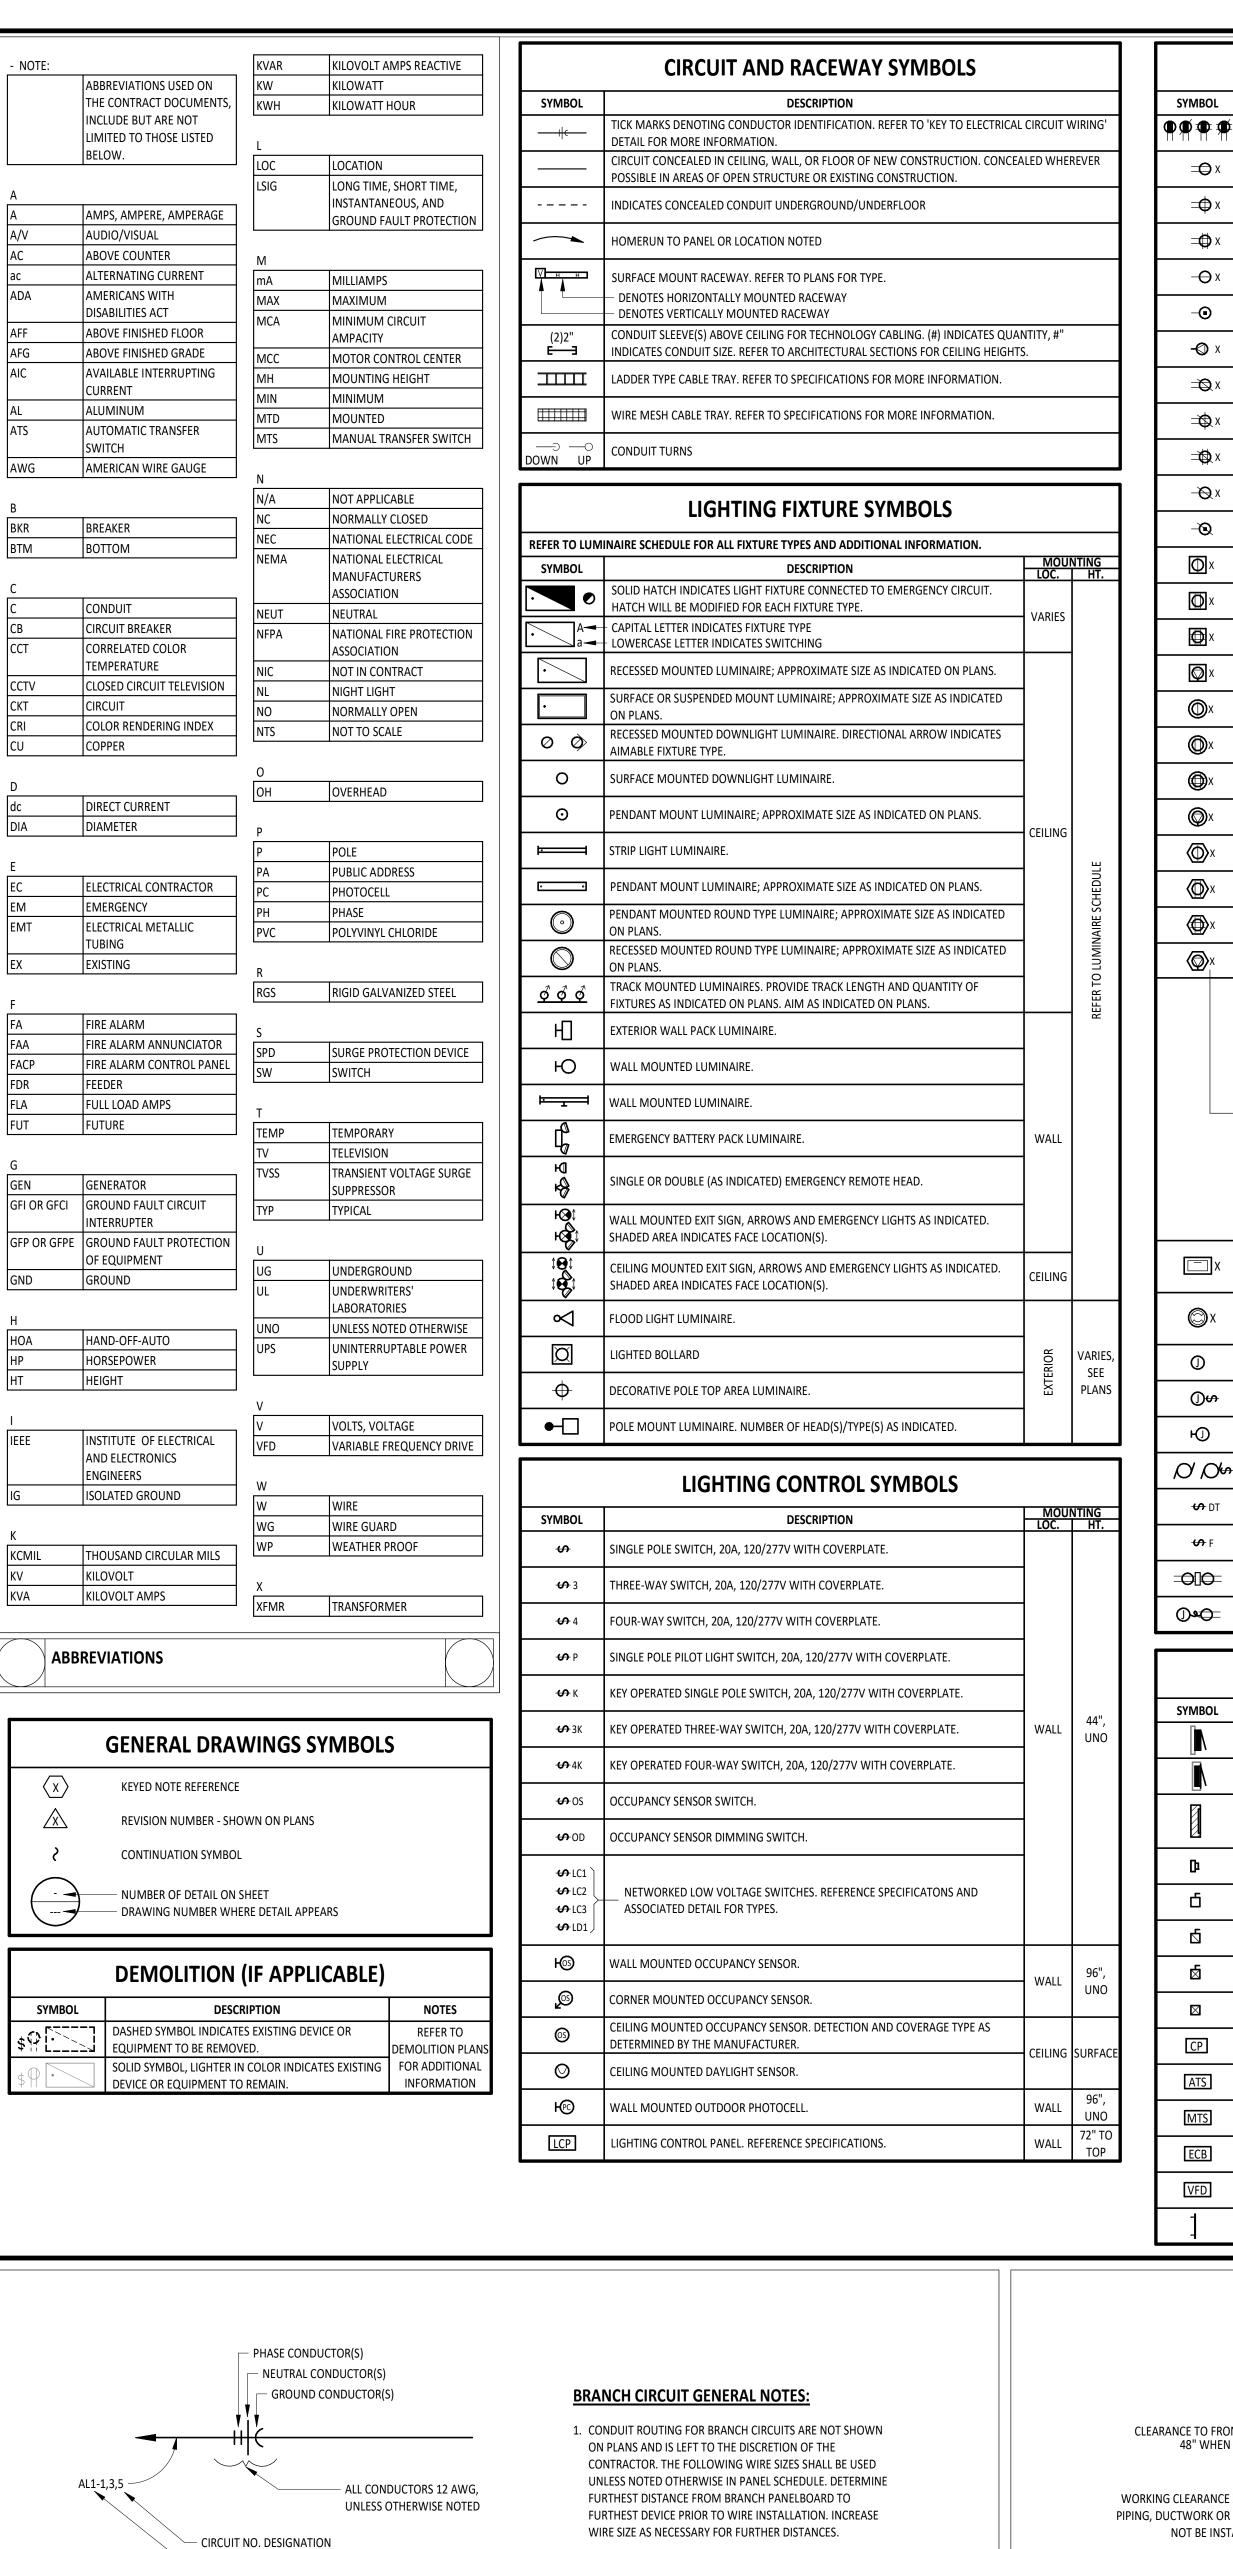

CONDUCTOR SIZE

8 AWG

10 AWG

20A, 120V

20A, 120V

20A, 277V

MAXIMUM LENGTH

100 FEET

175 FEET

200 FEET

PANEL DESIGNATION

1. 12 AWG IS MIN. CONDUCTOR SIZE, EXCEPT AS NOTED.

2. 1/2" CONDUIT IS MIN. SIZE, EXCEPT AS CAPACITY PERMITTING 24 VOLT

NOTES:

CONTROL CONDUCTOR.

1 KEY TO ELECTRICAL CIRCUIT WIRING

3. PROVIDE DEDICATED NEUTRALS.

	WIRING DEVICE SYMBOLS				FIRE ALARM SYMBOLS
DL	DESCRIPTION	MOUI	NTING HT.	SYMBOL	DESCRIPTION
*	SOLID HATCH INDICATES DEVICE CONNECTED TO EMERGENCY POWER. PROVIDE RED DEVICE WITH COVERPLATE TO MATCH REST OF ROOM.	WALL, UNO	VARIES	FACP	FIRE ALARM CONTROL PANEL. REFER TO SPECIFICATIONS.
) x	DUPLEX RECEPTACLE, 20A, 125V, NEMA 5-20R, WITH COVERPLATE MOUNTED VERTICALLY.			NAC	FIRE ALARM NAC POWER SUPPLY. REFER TO SPECIFICATIONS.
) X	DUPLEX RECEPTACLE, 20A, 125V, NEMA 5-20R, WITH COVERPLATE. EXTRA LINE INDICATES DEVICE TO BE MOUNTED HORIZONTALLY.			FAA	FIRE ALARM ANNUNCIATOR PANEL. REFER TO SPECIFICATIONS.
) X	DOUBLE DUPLEX RECEPTACLE, 20A, 125V, NEMA 5-20R, WITH COMMON COVERPLATE.	WALL, UNO	16"	F	FIRE ALARM PULL STATION. REFER TO SPECIFICATIONS.
) X	SINGLE RECEPTACLE, 20A, 125V, NEMA 5-20R, WITH COVERPLATE MOUNTED VERTICALLY.				FIRE ALARM HORN DEVICE. REFER TO SPECIFICATIONS.
)	DEAD-FRONT GFCI DEVICE, 20A, 125V, WITH COVERPLATE MOUNTED VERTICALLY.				FIRE ALARM HORN/STROBE DEVICE. REFER TO SPECIFICATIONS.
Х	SPECIAL PURPOSE RECEPTACLE WITH COVERPLATE. REFER TO PLANS FOR TYPE.				FIRE ALARM SPEAKER DEVICE. REFER TO SPECIFICATIONS.
χ	DUPLEX RECEPTACLE, 20A, 125V, NEMA 5-20R, WITH COVERPLATE MOUNTED VERTICALLY.				FIRE ALARM SPEAKER/STROBE DEVICE. REFER TO SPECIFICATIONS.
) x	DUPLEX RECEPTACLE, 20A, 125V, NEMA 5-20R, WITH COVERPLATE. EXTRA LINE INDICATES DEVICE TO BE MOUNTED HORIZONTALLY.	WALL,	44",	Ø	FIRE ALARM STROBE LIGHT ONLY DEVICE. REFER TO SPECIFICATIONS.
) x	DOUBLE DUPLEX RECEPTACLE, 20A, 125V, NEMA 5-20R, WITH COMMON COVERPLATE.	UNO	UNO	(S)	CEILING MOUNT FIRE ALARM SPEAKER DEVICE. REFER TO SPECIFICATIONS.
) x	SINGLE RECEPTACLE, 20A, 125V, NEMA 5-20R, WITH COVERPLATE MOUNTED VERTICALLY.			®	CEILING MOUNT FIRE ALARM SPEAKER/STROBE DEVICE. REFER TO SPECIFICATIONS.
)	DEAD-FRONT GFCI DEVICE, 20A, 125V, WITH COVERPLATE MOUNTED VERTICALLY.			⊘	FIRE ALARM SMOKE DETECTOR. REFER TO SPECIFICATIONS.
Х	IN FLOOR SINGLE RECEPTACLE. TYPE AS INDICATED ON PLANS.			\odot	FIRE ALARM HEAT DETECTOR. REFER TO SPECIFICATIONS.
Х	IN FLOOR DUPLEX RECEPTACLE. TYPE AS INDICATED ON PLANS. IN FLOOR DOUBLE DUPLEX RECEPTACLE. TYPE AS INDICATED ON PLANS.		VARIES	(<u>©</u>)	FIRE ALARM CO DETECTOR. REFER TO SPECIFICATIONS.
Х			VANILS	(<u>+</u>	FIRE ALARM DUCT SMOKE DETECTOR. REFER TO SPECIFICATIONS.
Х	IN FLOOR SPECIAL PURPOSE RECEPTACLE. TYPE AS INDICATED ON PLANS.			Ф	FIRE ALARM MAGNETIC DOOR HOLDER. REFER TO SPECIFICATIONS.
Х	CEILING MOUNTED SINGLE RECEPTACLE.			X	FIRE ALARM REMOTE TEST STATION FOR HIDDEN SMOKE/DUCT DETECTOR. REFER TO SPECIFICATIONS.
Х	CEILING MOUNTED DUPLEX RECEPTACLE.	CEILING	FLUSH	AM	FIRE ALARM ADDRESSABLE MODULE (MONITOR OR RELAY). REFER TO SPECIFICATIONS.
Х	CEILING MOUNTED DOUBLE DUPLEX RECEPTACLE.		1 1 1 1 1 1 1 1 1 1 1 1 1 1 1 1 1 1 1 1	Ð	FIRE ALARM SPRINKLER BELL. FURNISHED BY FIRE SUPPRESSION CONTRACTOR, INSTALLED BY DIVISION 26.
х	CEILING MOUNTED SPECIAL PURPOSE RECEPTACLE.			%	TAMPER VALVE/SWITCH FOR PLUMBING PIPING. PROVIDE FIRE ALARM CONNECTIONS AS REQUIRED.
Х	PEDESTAL MOUNTED SINGLE RECEPTACLE.			8	FLOW SWITCH FOR SPRINKLER PIPING. PROVIDE FIRE ALARM CONNECTIONS AS REQUIRED.
Х	PEDESTAL MOUNTED DUPLEX RECEPTACLE.	FLOOR	VARIES	*	POST INDICATOR VALVE (PIV). PROVIDE FIRE ALARM CONNECTIONS AS REQUIRED.
Х	PEDESTAL MOUNTED DOUBLE DUPLEX RECEPTACLE.	I LOOK	VAINES	SD	SMOKE DAMPER CONNECTION. REFER TO PLANS FOR TYPE.
X	PEDESTAL MOUNTED SPECIAL PURPOSE RECEPTACLE.				CECURITY A COECC CONTROL CVAAROLC
	'X' INDICATES RECEPTACLE TYPE OTHER THAN STANDARD				SECURITY/ACCESS CONTROL SYMBOLS
	NO DESIGNATOR INDICATES STANDARD POWER DEVICE GFI = GFCI RATED			SYMBOL	DESCRIPTION
	GFT = GFCI RATED AND TAMPER RESISTANT			ACP	ACCESS CONTROL PANEL. DIVISION 26 TO PROVIDE 120V TO PANEL AS REQUIRED.
	TR = TAMPER RESISTANT IG = ISOLATED GROUND				COORDINATE WITH DIVISION 28. SECURITY SYSTEM CONTROL PANEL. DIVISION 26 TO PROVIDE 120V TO PANEL AS
	U = USB CHARGING PORTS			SCP	REQUIRED. COORDINATE WITH DIVISION 28.
	SR = SOUND REINFORCEMENT IFP - INTERACTIVE FLAT PANEL VID = VIDEO OUTLET		- 96"	EL	ELECTRIC LOCK, PROVIDED BY DIVISION 08. PROVIDE 3/4" CONDUIT WITH PLASTIC BUSHING FROM DOOR FRAME TO ABOVE ACCESSIBLE CEILING. COORDINATE ROUGH-IN REQUIREMENTS WITH DIVISION 08 AND DIVISION 28.
	VP = VIDEO PROJECTOR —	†	- 80"		DOOR CONTACT, PROVIDED BY DIVISION 28, PROVIDE 3/4" CONDUIT WITH PLASTIC

	•	•	.	MS	DESK MOUNT MASTER INTERCOM STATION PROVIDED BY DIVISION 28. COORDIN PATHWAY REQUIREMENTS WITH DIVISION 28.
ELECTRICAL EQUIPMENT SYMBOLS				•	ELECTRONIC DOOR RELASE PUSHBUTTON PROVIDED BY DIVISION 28. COORDINA PATHWAY REQUIREMENTS WITH DIVISION 28.
DESCRIPTION	MOU LOC.	NTING I HT.	1 :		•
SURFACE MOUNTED PANELBOARD - CIRCUIT BREAKER TYPE. DASHED LINES ON PLAN INDICATE CLEARANCES. REFER TO PANEL SCHEDULES AND ONE-LINE DIAGRAM.	VARIES	78" TO			MISCELLANEOUS SYMBOLS
FLUSH MOUNTED PANELBOARD - CIRCUIT BREAKER TYPE. DASHED LINES ON PLAN INDICATE CLEARANCES. REFER TO PANEL SCHEDULES AND ONE-LINE DIAGRAM.	VAINES	TOP		SYMBOL	DESCRIPTION
DISTRIBUTION PANEL - CIRCUIT BREAKER TYPE. DASHED LINES ON PLAN INDICATE CLEARANCES. REFER TO PANEL SCHEDULES AND ONE-LINE DIAGRAM.	VARIES	VARIES		GCPx	GYM EQUIPMENT CONTROL PANEL FURNISHED BY GYM EQUIPMENT INSTALLER, INSTALLED BY DIVISION 26.
METER BASE	VARIES	78" TO TOP		GEC	GYM EQUIPMENT CONTROLLER FURNISHED BY GYM EQUIPMENT INSTALLER. DIVISION 26 TO PROVIDE BACK BOX AND ALL NECESSARY WIRING AS REQUIRED.
NON-FUSED DISCONNECT SWITCH.				GA	GENERATOR ANNUNCIATOR PANEL. REFER TO SPECIFICATIONS.
FUSED DISCONNECT SWITCH.	VARIES	VARIES		FUSE	SPARE FUSE CABINET. REFER TO SPECIFICATIONS.
COMBINATION MAGNETIC MOTOR STARTER AND DISCONNECT SWITCH.	VAINIES	VAILLS		HD	HAND DRYER. REFER TO SPECIFICATIONS.
MAGNETIC MOTOR STARTER.				н	AUTOMATIC DOOR OPERATOR FURNISHED BY DIVISION 08, INSTALLED BY DIVISION 26. COORDINATE WITH DOOR INSTALLER.
CONTROL PANEL. REFER TO PLANS FOR MORE INFORMATION.				D)	PUSH BUTTON. REFER TO DRAWINGS FOR MORE INFORMATION.
AUTOMATIC TRANSFER SWITCH.				••	MULTI-BUTTON PUSH STATION. REFER TO DRAWINGS FOR MORE INFORMATION.
MANUAL TRANSFER SWITCH.	VARIES	72" TO TOP	•		
ENCLOSED CIRCUIT BREAKER.					
VARIABLE FREQUENCY DRIVE.					
GROUND BAR REFER TO GROUNDING DETAIL	₩/ΔΙΙ	16"	1		

DOOR CONTACT, PROVIDED BY DIVISION 28. PROVIDE 3/4" CONDUIT WITH PLASTIC

REQUEST TO EXIT DEVICE, PROVIDED BY DIVISION 28. PROVIDE 3/4" CONDUIT WITH

CARD READER, PROVIDED BY DIVISION 28. PROVIDE SINGLE GANG BACK BOX WITH

(EYPAD, PROVIDED BY DIVISION 28. PROVIDE SINGLE GANG BACK BOX WITH 3/4"

CONDUIT WITH PLASTIC BUSHING TO ABOVE ACCESSIBLE CEILING. COORDINATE

CEILING MOUNT MOTION DETECTOR. PROVIDE ROUGH-IN IN HARD CEILING AS

REQUIRED FOR INSTALLATION. PROVIDE 3/4" CONDUIT WITH PLASTIC BUSHING TO

WALL MOUNT MOTION DETECTOR. PROVIDE SINGLE GANG BACK BOX WITH 3/4"

CONDUIT WITH PLASTIC BUSHING TO ABOVE ACCESSIBLE CEILING. COORDINATE

OICE ONLY INTERCOM STATION BY DIVISION 28. BACK BOX FURNISHED BY

DIVISION 28, INSTALLED BY DIVISION 26. PROVIDE 1" CONDUIT WITH PLASTIC

OICE & VIDEO INTERCOM STATION BY DIVISION 28. BACK BOX FURNISHED BY

DIVISION 28, INSTALLED BY DIVISION 26. PROVIDE 1" CONDUIT WITH PLASTIC

ABOVE ACCESSIBLE CEILING. COORDINATE BACK BOX AND WORK WITH DIVISION 28.

SECURITY SYSTEM ALARM BELL PROVIDED BY DIVISION 28. PROVIDE BACK BOX AND

BUSHING FROM DOOR FRAME TO ABOVE ACCESSIBLE CEILING. COORDINATE

PLASTIC BUSHING FROM DOOR FRAME TO ABOVE ACCESSIBLE CEILING.

3/4" CONDUIT WITH PLASTIC BUSHING TO ABOVE ACCESSIBLE CEILING.

COORDINATE ROUGH-IN REQUIREMENTS WITH DIVISION 08 AND DIVISION 28.

ROUGH-IN REQUIREMENTS WITH DIVISION 08 AND DIVISION 28.

COORDINATE WITH DIVISION 28 PRIOR TO ROUGH-IN.

PATHWAY AS REQUIRED. COORDINATE WITH DIVISION 28.

WITH DIVISION 28 PRIOR TO ROUGH-IN.

BUSHING TO ABOVE ACCESSIBLE CEILING.

BUSHING TO ABOVE ACCESSIBLE CEILING.

WORK WITH DIVISION 28.

SYMBOL	DESCRIPTION	LOC.	NTING HT.					
◁	DATA OUTLET. 4-11/16" BOX WITH 2" DEEP 2-GANG EXTENSION RING. PROVIDE ONE (1) 1-1/4" CONDUIT.		16"					
4	VOICE & DATA OUTLET. 4-11/16" BOX WITH 2" DEEP 2-GANG EXTENSION RING. PROVIDE ONE (1) 1-1/4" CONDUIT.	WALL	UN					
4	VOICE OUTLET. 4-11/16" BOX WITH 2" DEEP 1-GANG EXTENSION RING. PROVIDE ONE (1) 1" CONDUIT.	WALL	44'					
4 II	LOCAL INPUT OUTLET. 4-11/16" BOX WITH 2" DEEP 2-GANG EXTENSION RING. PROVIDE ONE (1) 1-1/4" CONDUIT.	WALL	16" UN(
⊲ IFP	INTERACTIVE FLAT PANEL OUTLET. 4-11/16" BOX WITH 2" DEEP 2-GANG EXTENSION RING. PROVIDE ONE (1) 1-1/4" CONDUIT.	WALL	44'					
LARGE VENUE PROJECTOR OUTLET. 4-11/16" BOX WITH 2" DEEP 2-GANG EXTENSION RING. PROVIDE TWO (2) 1-1/4" CONDUIT.								
⊲ SA	GYMNASIUM AUDIO SYSTEM OUTLET. 4-11/16" BOX WITH 2" DEEP 2-GANG EXTENSION RING. PROVIDE TWO (2) 1-1/4" CONDUIT.							
⊲ SP	STAGE PRESENTER OUTLET. 4-11/16" BOX WITH 2" DEEP 2-GANG EXTENSION RING. PROVIDE TWO (2) 1-1/4" CONDUIT.	WALL	16'					
◀ TPC	TEACHED DEDCONAL COMPLITED OUTLET 4.11/16" DOV WITH 2" DEED 2 CANC							
⊲ SR	SOUND REINFORCEMENT OUTLET. 4-11/16", 3.5" DEEP BOX WITH 2-GANG EXTENSION RING. PROVIDE TWO (2) 1-1/4" CONDUIT.	WALL	44"					
⊲ VID	VIDEO MONITOR OUTLET. 4-11/16" BOX WITH 2" DEEP 2-GANG EXTENSION RING. PROVIDE ONE (1) 1-1/4" CONDUIT.	WALL	96". UNC					
△ AQS	AIR QUALITY SENSOR OUTLET. 4-11/16" OCTOGON BOX WITH 2" DEEP 1-GANG EXTENSION RING. PROVIDE ONE (1) 1" CONDUIT.	ON PLANS	CEILIN					
⊲ CAM	CAMERA OUTLET. 4-11/16" BOX WITH 2" DEEP 1-GANG EXTENSION RING. PROVIDE ONE (1) 1" CONDUIT. PROVIDE WEATHERPROOF COVERPLATE FOR EXTERIOR APPLICATIONS.	10/01/	144'					
⊲ WAP	WIRELESS ACCESS POINT OUTLET. 4-11/16" BOX WITH 2" DEEP 1-GANG EXTENSION RING. PROVIDE ONE (1) 1" CONDUIT. PROVIDE WEATHERPROOF COVERPLATE FOR EXTERIOR APPLICATIONS.	WALL	UNC					

WALL

DUCT

MTD PLAN

WALL VARIES

DUCT PLANS

WALL

WALL

WALL

WALL

	AUDIO DEVICE SYMBOLS						
SYMBOL	DESCRIPTION	MOUI LOC.	NTING				
РА	PUBLIC ADDRESS SOUND SYSTEM RACK.						
SD	STUDENT DINING SOUND SYSTEM RACK.						
GS	GYMNASIUM SOUND SYSTEM RACK.	FLOOR	N/				
PR	PORTABLE SOUND SYSTEM RACK.						
MS	MUSIC/VOCAL ROOM SOUND SYSTEM RACK.						
M	HANGING MICROPHONE PROVIDED BY DIVISION 28. DIVISION 26 TO PROVIDE CEILING MOUNTED JUNCTION BOX AND RACEWAY AS REQUIRED. COORDINATE WITH DIVISION 28.						
HΣ	MICROPHONE OUTLET. 1-GANG BOX WITH 2" DEEP 1-GANG EXTENSION RING. PROVIDE 1" CONDUIT TO ABOVE ACCESSIBLE CEILING WITH PULL WIRE. PROVIDE PLASTIC BUSHING ON END OF CONDUIT.						
A/M	AUXILIARY/MICROPHONE OUTLET. 4-11/16" BOX WITH 2" DEEP 1-GANG EXTENSION RING. PROVIDE 1" CONDUIT TO ABOVE ACCESSIBLE CEILING WITH PULL WIRE. PROVIDE PLASTIC BUSHING ON END OF CONDUIT.						
(3)	SPEAKER FOR PA SYSTEM, UNO. PROVIDE ROUGH-IN AND RACEWAY AS REQUIRED IN HARD CEILINGS. COORDINATE WITH DIVISION 27.	HARD	N,				
R	SPEAKER FOR LOCAL SOUND REINFORCEMENT. PROVIDE ROUGH-IN AND RACEWAY AS REQUIRED IN HARD CEILINGS. COORDINATE WITH DIVISION 27.						
65	SPEAKER FOR STUDENT DINING SOUND SYSTEM PROVIDED BY DIVISION 27. DIVISION 26 TO PROVIDE JUNCTION BOX AT SPEAKER LOCATION AND PATHWAYS AS REQUIRED. COORDINATE WITH DIVISION 27.	VARIES	SE				
<u>©</u>	SPEAKER FOR GYMNASIUM SOUND SYSTEM PROVIDED BY DIVISION 27. DIVISION 26 TO PROVIDE JUNCTION BOX AT SPEAKER LOCATION AND PATHWAYS AS REQUIRED. COORDINATE WITH DIVISION 27.						
S	SPEAKER FOR PA SOUND SYSTEM. PROVIDE 3/4" CONDUIT FROM CUSTOM BACK BOX, PROVIDED BY DIVISION 27, TO ABOVE ACCESSIBLE CEILING, PROVIDE PULL STRING AND PLASTIC BUSHING ON END OF CONDUIT.	NA/A11	144				
⊡ \$	HORN TYPE SPEAKER PROVIDED BY DIVISION 28. PROVIDE 1-GANG, 3.5" DEEP BOX WITH 1-GANG EXTENSION RING. PROVIDE 3/4" CONDUIT WITH PULL STRING TO ABOVE ACCESSIBLE CEILING. PROVIDE PLASTIC BUSHING ON END OF CONDUIT.	WALL	UN				
	SOUND SYSTEM SPEAKER. PROVIDE ROUGH-IN AS REQUIRED FOR INSTALLATION. COORDINATE WORK WITH DIVISION 28.	VARIES	SE PLA				
⊢●	CALL-IN SWITCH FOR PA SYSTEM. PROVIDE 1-GANG, 3.5" DEEP BOX WITH 1-GANG EXTENSION RING. PROVIDE 3/4" CONDUIT WITH PULL STRING TO ABOVE ACCESSIBLE CEILING. PROVIDE PLASTIC BUSHING ON END OF CONDUIT.	\A/A11					
(S)	VOLUME CONTROL FOR PA SYSTEM. PROVIDE 1-GANG, 3.5" DEEP BOX WITH 1-GANG EXTENSION RING. PROVIDE 3/4" CONDUIT WITH PULL STRING TO ABOVE ACCESSIBLE CEILING. PROVIDE PLASTIC BUSHING ON END OF CONDUIT.	WALL	44				
⋖	ADMINISTRATIVE CONSOLE FOR PA SYSTEM. PROVIDE BACK BOX AND PATHWAY AS REQUIRED FOR INSTALLATION. COORDINATE WITH DIVISION 28.	VARIES	SE PLA				

SYMBOL	DESCRIPTION	MOUNTING			
4	DATA OUTLET. 4-11/16" BOX WITH 2" DEEP 2-GANG EXTENSION RING. PROVIDE ONE (1) 1-1/4" CONDUIT.	LOC.	HT. 16",		
4	VOICE & DATA OUTLET. 4-11/16" BOX WITH 2" DEEP 2-GANG EXTENSION RING. PROVIDE ONE (1) 1-1/4" CONDUIT.	WALL	UNO		
•	VOICE OUTLET. 4-11/16" BOX WITH 2" DEEP 1-GANG EXTENSION RING. PROVIDE ONE (1) 1" CONDUIT.	WALL	44"		
4 II	LOCAL INPUT OUTLET. 4-11/16" BOX WITH 2" DEEP 2-GANG EXTENSION RING. PROVIDE ONE (1) 1-1/4" CONDUIT.	WALL	16", UNO		
⊲ IFP	INTERACTIVE FLAT PANEL OUTLET. 4-11/16" BOX WITH 2" DEEP 2-GANG EXTENSION RING. PROVIDE ONE (1) 1-1/4" CONDUIT.	WALL	44"		
⊲ LVP	LARGE VENUE PROJECTOR OUTLET. 4-11/16" BOX WITH 2" DEEP 2-GANG EXTENSION RING. PROVIDE TWO (2) 1-1/4" CONDUIT.	WALL	AS NOTED		
⊲ SA	GYMNASIUM AUDIO SYSTEM OUTLET. 4-11/16" BOX WITH 2" DEEP 2-GANG EXTENSION RING. PROVIDE TWO (2) 1-1/4" CONDUIT.				
⊲ SP	STAGE PRESENTER OUTLET. 4-11/16" BOX WITH 2" DEEP 2-GANG EXTENSION RING. PROVIDE TWO (2) 1-1/4" CONDUIT.	WALL	16"		
◁ TPC	TEACHER PERSONAL COMPUTER OUTLET. 4-11/16" BOX WITH 2" DEEP 2-GANG EXTENSION RING. PROVIDE TWO (2) 1-1/4" CONDUIT.				
⊲ SR	SOUND REINFORCEMENT OUTLET. 4-11/16", 3.5" DEEP BOX WITH 2-GANG EXTENSION RING. PROVIDE TWO (2) 1-1/4" CONDUIT.	WALL	44"		
⊘ VID	VIDEO MONITOR OUTLET. 4-11/16" BOX WITH 2" DEEP 2-GANG EXTENSION RING. PROVIDE ONE (1) 1-1/4" CONDUIT.	WALL	96", UNO		
⊲ AQS	AIR QUALITY SENSOR OUTLET. 4-11/16" OCTOGON BOX WITH 2" DEEP 1-GANG EXTENSION RING. PROVIDE ONE (1) 1" CONDUIT.	ON PLANS	CEILING		
⊲ CAM	CAMERA OUTLET. 4-11/16" BOX WITH 2" DEEP 1-GANG EXTENSION RING. PROVIDE ONE (1) 1" CONDUIT. PROVIDE WEATHERPROOF COVERPLATE FOR EXTERIOR APPLICATIONS.	WALL	144",		
	WIDELESS ACCESS DOINT OUTLET A 11/16" DOV WITH 3" DEED 1 CANC EXTENSION		UNO		

SYMBOL	DESCRIPTION	MOUI LOC.	NTING HT.		
PA	PUBLIC ADDRESS SOUND SYSTEM RACK.				
SD	STUDENT DINING SOUND SYSTEM RACK.				
GS	GYMNASIUM SOUND SYSTEM RACK.	FLOOR	N/A		
PR	PORTABLE SOUND SYSTEM RACK.				
MS	MUSIC/VOCAL ROOM SOUND SYSTEM RACK.				
(4)	HANGING MICROPHONE PROVIDED BY DIVISION 28. DIVISION 26 TO PROVIDE CEILING MOUNTED JUNCTION BOX AND RACEWAY AS REQUIRED. COORDINATE WITH DIVISION 28.				
HΣ	MICROPHONE OUTLET. 1-GANG BOX WITH 2" DEEP 1-GANG EXTENSION RING. PROVIDE 1" CONDUIT TO ABOVE ACCESSIBLE CEILING WITH PULL WIRE. PROVIDE PLASTIC BUSHING ON END OF CONDUIT.	WALL	16", UNO		
H ∖A	AUXILIARY/MICROPHONE OUTLET. 4-11/16" BOX WITH 2" DEEP 1-GANG EXTENSION RING. PROVIDE 1" CONDUIT TO ABOVE ACCESSIBLE CEILING WITH PULL WIRE. PROVIDE PLASTIC BUSHING ON END OF CONDUIT.				
③	SPEAKER FOR PA SYSTEM, UNO. PROVIDE ROUGH-IN AND RACEWAY AS REQUIRED IN HARD CEILINGS. COORDINATE WITH DIVISION 27.	HARD	N/A		
R	SPEAKER FOR LOCAL SOUND REINFORCEMENT. PROVIDE ROUGH-IN AND RACEWAY AS REQUIRED IN HARD CEILINGS. COORDINATE WITH DIVISION 27.	CEILING	MA		
6 5	SPEAKER FOR STUDENT DINING SOUND SYSTEM PROVIDED BY DIVISION 27. DIVISION 26 TO PROVIDE JUNCTION BOX AT SPEAKER LOCATION AND PATHWAYS AS REQUIRED. COORDINATE WITH DIVISION 27.	VARIES	SEE		
65	SPEAKER FOR GYMNASIUM SOUND SYSTEM PROVIDED BY DIVISION 27. DIVISION 26 TO PROVIDE JUNCTION BOX AT SPEAKER LOCATION AND PATHWAYS AS REQUIRED. COORDINATE WITH DIVISION 27.	VARIES	PLANS		
S	SPEAKER FOR PA SOUND SYSTEM. PROVIDE 3/4" CONDUIT FROM CUSTOM BACK BOX, PROVIDED BY DIVISION 27, TO ABOVE ACCESSIBLE CEILING, PROVIDE PULL STRING AND PLASTIC BUSHING ON END OF CONDUIT.	WALL	144",		
⊡ (1	HORN TYPE SPEAKER PROVIDED BY DIVISION 28. PROVIDE 1-GANG, 3.5" DEEP BOX WITH 1-GANG EXTENSION RING. PROVIDE 3/4" CONDUIT WITH PULL STRING TO ABOVE ACCESSIBLE CEILING. PROVIDE PLASTIC BUSHING ON END OF CONDUIT.	WALL	UNO		
	SOUND SYSTEM SPEAKER. PROVIDE ROUGH-IN AS REQUIRED FOR INSTALLATION. COORDINATE WORK WITH DIVISION 28.	VARIES	SEE PLANS		
⊢●	CALL-IN SWITCH FOR PA SYSTEM. PROVIDE 1-GANG, 3.5" DEEP BOX WITH 1-GANG EXTENSION RING. PROVIDE 3/4" CONDUIT WITH PULL STRING TO ABOVE ACCESSIBLE CEILING. PROVIDE PLASTIC BUSHING ON END OF CONDUIT.	\\\\\\\\	44"		
8	VOLUME CONTROL FOR PA SYSTEM. PROVIDE 1-GANG, 3.5" DEEP BOX WITH 1-GANG EXTENSION RING. PROVIDE 3/4" CONDUIT WITH PULL STRING TO ABOVE ACCESSIBLE CEILING. PROVIDE PLASTIC BUSHING ON END OF CONDUIT.				
⋖	ADMINISTRATIVE CONSOLE FOR PA SYSTEM. PROVIDE BACK BOX AND PATHWAY AS REQUIRED FOR INSTALLATION. COORDINATE WITH DIVISION 28.	VARIES	SEE PLANS		

NOTE: ALL SYMBOLS OR ABBREVIATIONS MAY NOT BE

JSED FOR THIS PROJECT AND ARE SUBJECT TO CHANGE ON OTHER DRAWINGS.

ELECTRICAL SHEET INDEX MATTHEW E1.1 GENERAL NOTES, ABBREVIATIONS, LEGENDS AND SHEET INDEX ED1.1 ELECTRICAL DEMOLITION PLAN HIBNER 1416052E1.2 ELECTRICAL DETAILS, PANEL AND LUMINAIRE SCHEDULES E4.1 ELECTRICAL PLAN **ELECTRICAL GENERAL NOTES** MATTHEW R. HIBNER LICENSE #1416052 A ALL GENERAL WALL MOUNT WIRING DEVICES TO BE WHITE IN COLOR. COVERPLATES TO BE WHITE, NYLON, UNBREAKABLE TYPE. CEILING MOUNT RECEPTACLES TO BE WHITE IN COLOR WITH WHITE, NYLON, UNBREAKABLE COVERS. B ALL MOUNTING HEIGHTS REFER TO THE BOTTOM OF BOX OR DEVICE UNO.

EXPIRATION DATE: 12/31/2025



ELECTRICAL LIGHTING CONTROL GENERAL NOTES

AND LARGER, MAY BE COPPER OR ALUMINUM.

C ALL CONDUIT TO BE CONCEALED.

EXECUTION OF HIS WORK.

SHALL BE 12 AWG, UNO.

GREEN GROUND WIRE UNO.

WHICH APPLY.

WHICH APPLY.

ALL SENSOR LOCATIONS ARE APPROXIMATE. REFER TO MANUFACTURER'S INSTALLATION INSTRUCTIONS PRIOR TO INSTALLATION. IF PENDANT FIXTURES ARE PRESENT, LOCATION AND COVERAGE OF SENSORS SHOULD BE REVIEWED.

D TICK MARKS ON LIGHTING PLAN CIRCUITING INDICATE A CHANGE IN SWITCHING.

F ALL MATERIAL AND EQUIPMENT SHALL CONFORM TO U.L. AND NEMA STANDARDS

G THIS CONTRACTOR SHALL PAY ALL FEES AND OBTAIN ALL PERMITS REQUIRED TO THE

H THIS CONTRACTOR SHALL GUARANTEE HIS ENTIRE ELECTRICAL INSTALLATION AGAINST

WIRE SIZES BASED ON AWG (AMERICAN WIRE GAUGE) OR KCMIL, MINIMUM WIRE SIZE

CONDUCTORS SHALL BE TYPE 'THHN/THWN' STRANDED COPPER. CONDUCTORS 6 AWG,

EXPOSED EXTERIOR CONDUIT SHALL BE RIGID GALVANIZED STEEL OR INTERMEDIATE

GRADE METAL CONDUIT. INTERIOR CONDUIT MAY BE ELECTRICAL METALIC TUBING.

CONDUIT BURIED BELOW GRADE SHALL BE SCHEDULE 40 PVC WITH APPROPRIATE SIZE

DEFECTS IN WORKMANSHIP AND MATERIALS FOR A PERIOD OF ONE (1) YEAR.

E ALL WORK SHALL CONFORM TO THE 2023 N.E.C., NATIONAL, STATE, AND LOCAL CODES

B ULTRASONIC CEILING MOUNT SENSORS REQUIRE THAT THEY BE LOCATED NO CLOSER THAN 6' TO AIR SUPPLY/RETURN REGISTERS.

C CONTRACTOR IS RESPONSIBLE FOR PROPER SENSITIVITY AND TIME DELAY SETTINGS, VERIFICATION OF MANUFACTURER'S RECOMMENDED PLACEMENT, AND FIELD VERIFICATION OF CIRCUITS WITH RESPECT TO POWER PACK PLACEMENT. CONTRACTOR SHALL PROVIDE A LIGHTING CONTROL REPRESENTATIVE/TECHNICIAN FOR INITIAL SET-UP OF LIGHTING CONTROL SYSTEMS. EIGHT (8) HOURS MINIMUM

DEMONSTRATION AND TRAINING SHALL BE PROVIDED FOR EACH TYPE OF LIGHTING

CONTROL SYSTEM. THE LIGHTING CONTROL REPRESENTATIVE/TECHNICIAN SHALL BE

REQUIRED TO MAKE A SECOND SITE VISIT FOR POST COMMISSIONING REPAIRS AND

ADJUSTMENTS. CONTRACTOR SHALL PROVIDE ALL REQUIRED SOFTWARE FOR EACH LIGHTING CONTROL SYSTEM. SOFTWARE SHALL BE INSTALLED ON COMPUTER OF OWNER'S CHOICE. COORDINATE WITH OWNER.

F LIGHTING LEVEL SET POINTS FOR CLASSROOM LIGHTING MANAGEMENT SYSTEMS ARE FOR INITIAL PROGRAMMING ONLY. FINAL SETPOINTS SHALL BE VERIFIED BY THE PROGRAMMER THROUGH THE ARCHITECT/ENGINEER.

G CONTRACTOR IS RESPONSIBLE FOR FIELD VERIFICATION OF REQUIRED NUMBER OF POWER PACKS. ONE POWER PACK IS REQUIRED FOR EACH CONTROL/TOGGLE SWITCH. MAXIMUM NUMBER OF SENSORS THAT CAN BE WIRED IN PARALLEL TO A SINGLE POWERPACK IS DEPENDENT ON SENSOR MODEL (SEE INDIVIDUAL DATA SHEETS FOR mA CONSUMPTION). H LIGHTING CONTROLS SHALL BE COMMISSIONED BY A THIRD PARTY NOT INVOLVED

WITH THE CONSTRUCTION TO VERIFY FUNCTIONALITY WITH ASHRAE 90.1-2019 SECTION 9.4.3 AS REQUIRED IN OHIO BUILDING CODE. EQUALS BY LEVITON, SENSORSWITCH, SENSORWORX, WATTSTOPPER, CRESTRON, NOVITALS, LUTRON, STARFIELD, AND COOPER.

ISSUANCES/REVISIONS CONSTRUCTION DOCUMENTS | 12/11/202

DRAWN BY: CHECKED BY: NUMBER: 25041.00

SHEET TITLE:

GENERAL NOTES, ABBREVIATIONS, **LEGENDS AND SHEET INDEX**

> SHEET NUMBER: E1.1

1. HEIGHTS REFER TO BOTTOM OF BOX, UNO. 2. NOT ALL SYMBOLS ARE SHOWN, REFER TO SYMBOLS LEGENT FOR ADDITIONAL MOUNTING HEIGHTS AND INFORMATION. PANELBOARD — **GROUP ADJACENT** DEVICES AS CLOSE — TOGETHER AS POSSIBLE 16" AFF FINISHED FLOOR SYMBOL:

DEDICATED ELECTRICAL SPACE TO STRUCTURAL CEILING OR HARD CEILING. ONLY ELECTRICAL CONDUIT AND CONDUCTORS SHALL BE CLEARANCE TO FRONT OF PANELBOARD. ——, MM. PERMITTED TO PENETRATE THIS AREA. 48" WHEN PANEL FED AT 480V. → 36 WORKING CLEARANCE ZONE. LUMINAIRES, SURFACE MOUNTED OR PIPING, DUCTWORK OR OTHER ITEMS SHALL -RECESSED PANELBOARD NOT BE INSTALLED IN THIS ZONE. DEDICATED ELECTRICAL SPACE TO FLOOR. ONLY - ELECTRICAL CONDUIT AND CONDUCTORS SHALL BE PERMITTED TO PENETRATE THIS AREA. 3-1/2" CONCRETE FLOOR CURB FOR UNDERGROUND CONDUIT PENETRATIONS. (SURFACE MOUNTED PANELBOARDS ONLY) 30" DOES NOT REQUIRE TO BE CENTERED ON PANEL. BUT MUST INCLUDE ENTIRE PANEL.

WC = WATER COOLER

WF = WASH FOUNTAIN

COORDINATE WITH FLOOR INSTALLER.

TYPE. COORDINATE WITH FLOOR INSTALLER

JUNCTION BOX OR EQUIPMENT CONNECTION.

WALL MOUNTED JUNCTION BOX

PANELBOARD CLEARANCES
NTS

GROUND BAR. REFER TO GROUNDING DETAIL.

WP = WEATHER-PROOF AND GFCI RATED (METAL IN-USE COVERPLATE)

LOOR BOX WITH (2) NEMA 5-20R RECEPTACLES, UNO. 'X' INDICATES TYPE, REFER TO

MW = MICROWAVE - COORDINATE WITH CASEWORK INSTALLER. —

SPECIFICATIONS. PROVIDE PROPER COVER FOR THE ASSOCIATED FLOOR TYPE.

POKE-THRU WITH TWO (2) NEMA 5-20R RECEPTACLES, UNO. 'X' INDICATES TYPE,

REFER TO SPECIFICATIONS. PROVIDE PROPER COVER FOR THE ASSOCIATED FLOOR

JUNCTION BOX OR EQUIPMENT CONNECTION WITH SWITCH FOR MAINTENANCE

MOTOR CONNECTION. PROVIDE SWITCH FOR MAINTENANCE DISCONNECT WHEN

SHOWN. PROVIDE SWITCH RATED FOR VOLTAGE AND LOAD SHOWN ON PLANS.

CORD REEL DOUBLE DUPLEX RECEPTACLE. REFER TO SPECIFICATIONS FOR TYPE.

DROP CORD DUPLEX RECEPTACLE. REFER TO ASSOCIATED DROP CORD DETAIL FOR

0-6 HOUR DIGITAL TIMER RATED FOR LOAD BEING CONTROLLED.


20A, FUSED MOTOR SWITCH, PROVIDE OVERLOADS RATED TO MOTOR.


DISCONNECT. PROVIDE SWITCH RATED FOR VOLTAGE AND LOAD SHOWN ON PLANS.

GENERAL NOTES: A. REFER TO NEC SECTION 110.26 FOR MORE INFORMATION.

B. COORDINATE ALL WORK WITH OTHER TRADES TO MAINTAIN ALL OTHER NEC CLEARANCES AND REQUIREMENTS.

3 ELECTRICAL MOUNTING HEIGHT DETAIL NTS

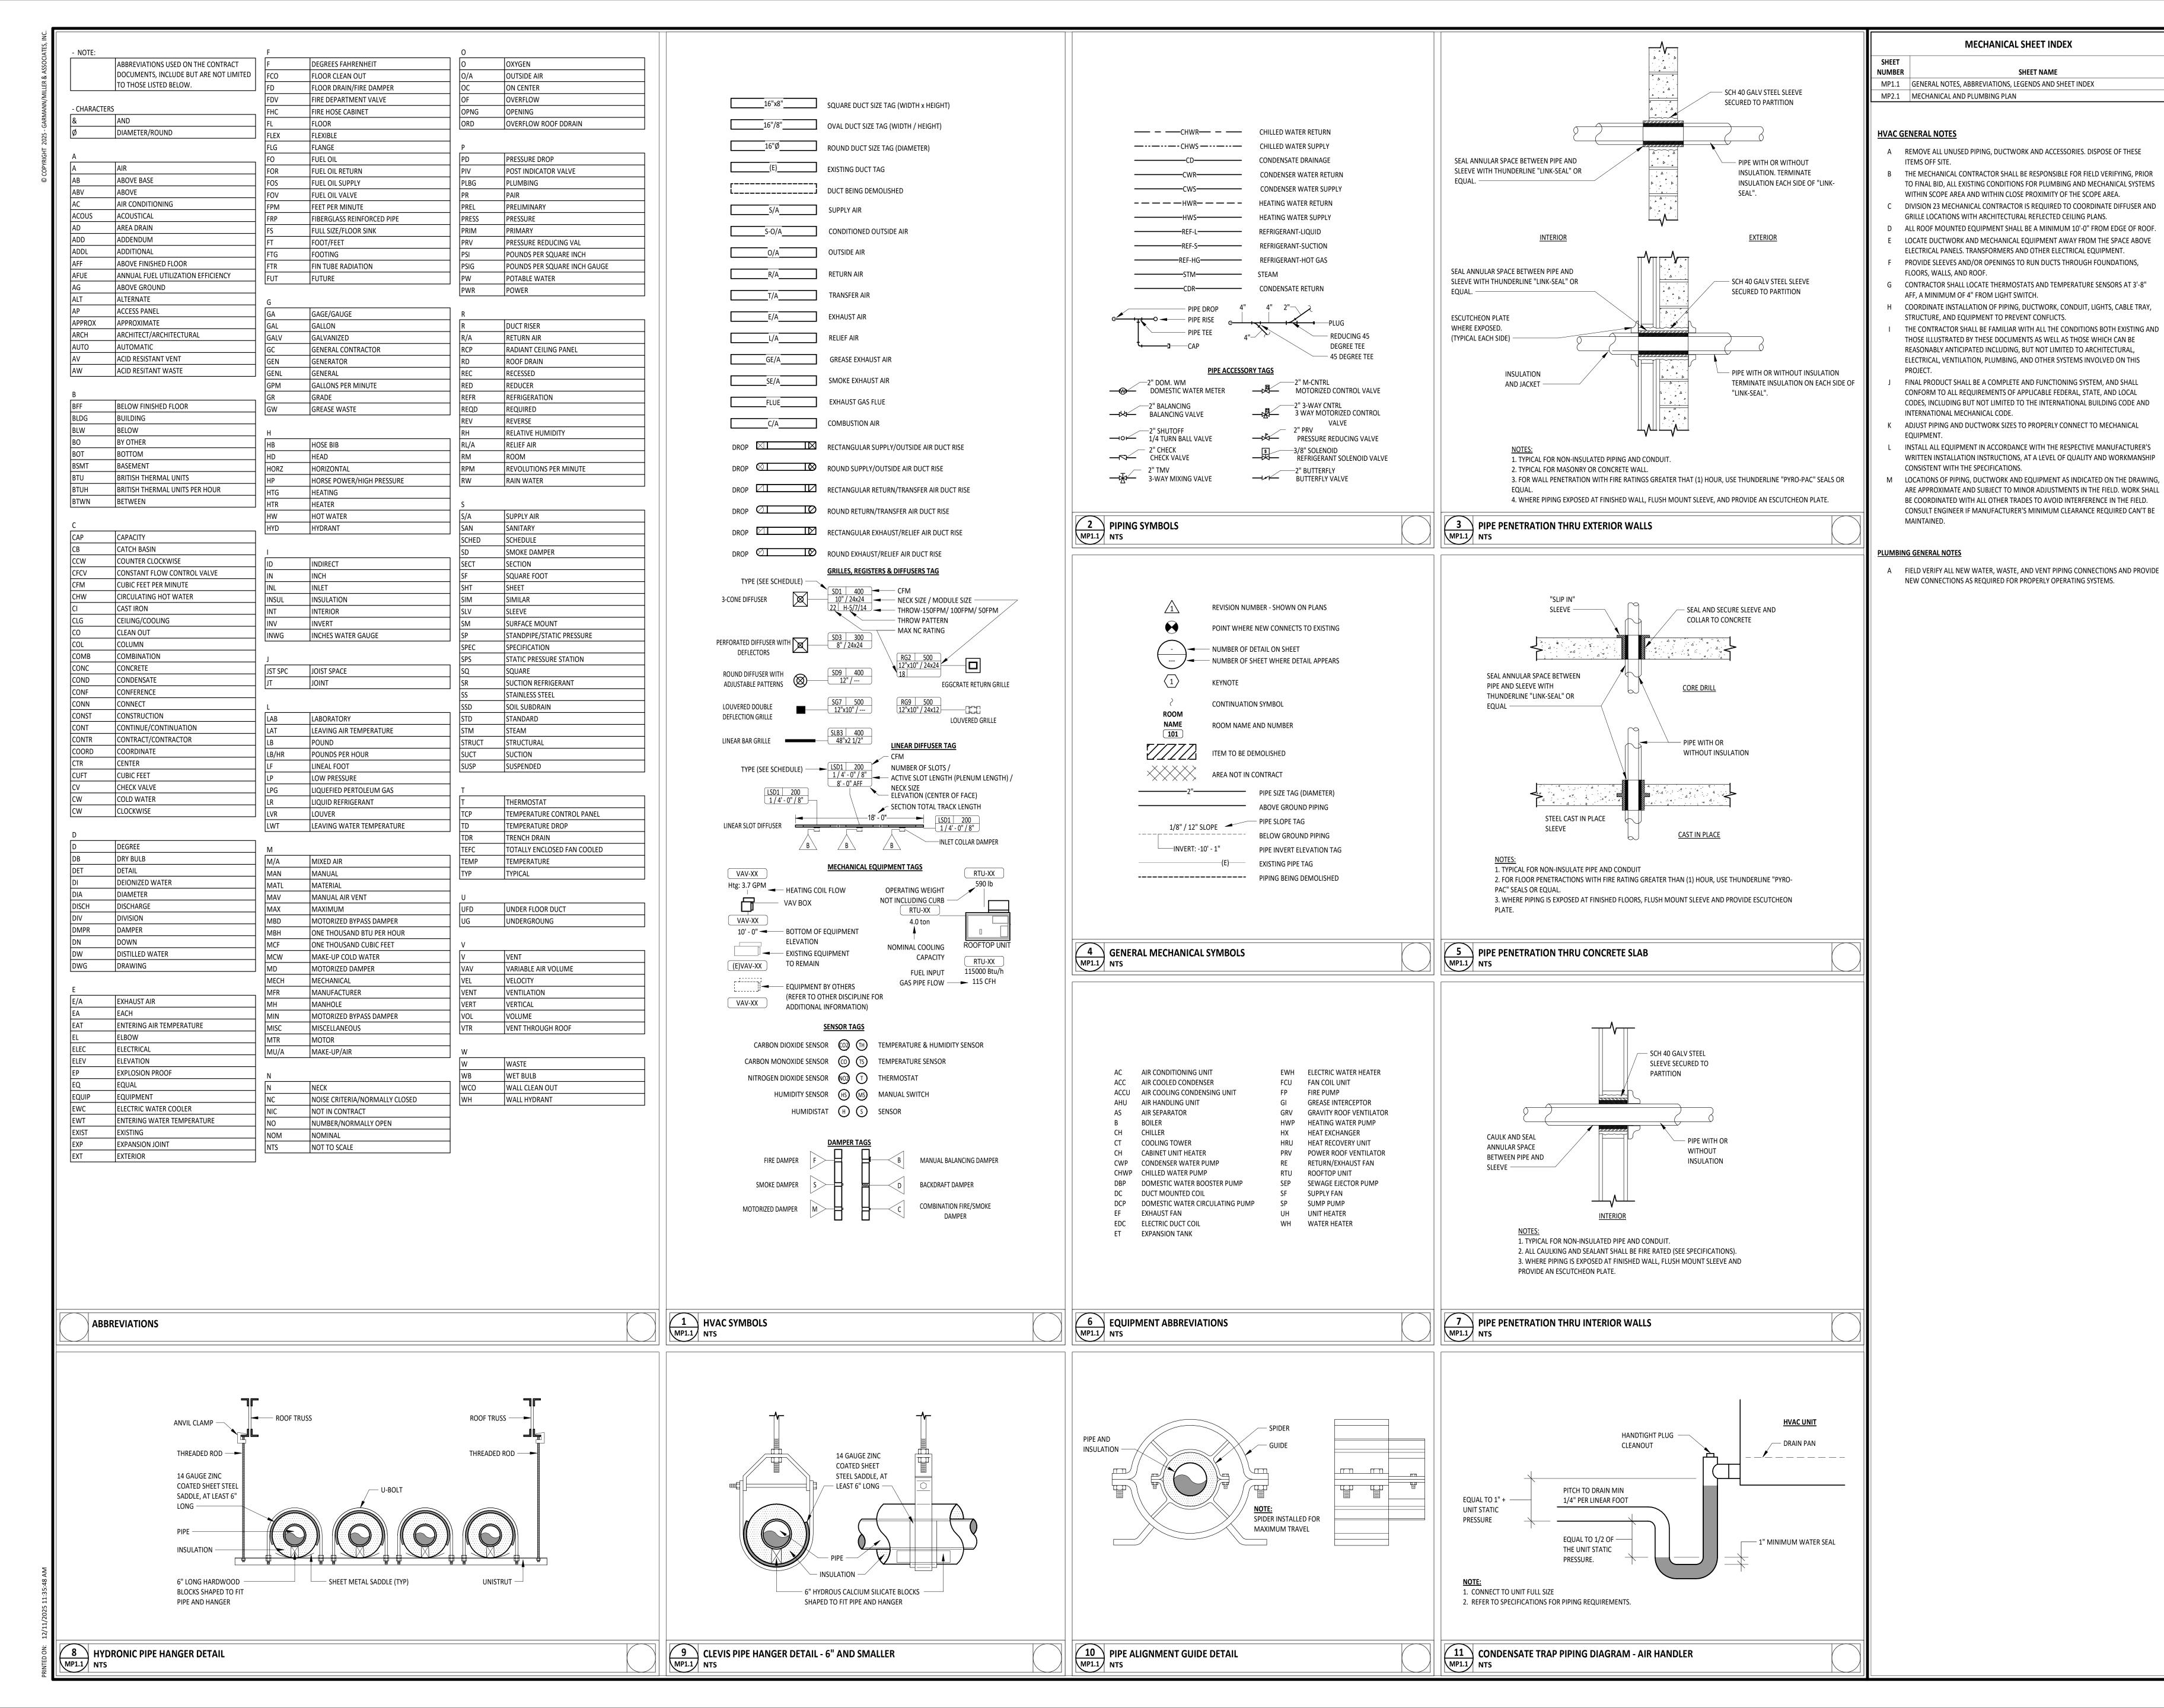

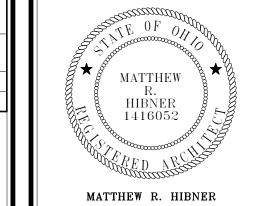

LICENSE #1416052 EXPIRATION DATE: 12/31/2025



SCHOO DING 0 LOR **FORT**


ISSUANCES/REVISIONS CONSTRUCTION DOCUMENTS 12/11/2025


DRAWN BY: CHECKED BY: NUMBER: 25041.00

SHEET TITLE:

GENERAL NOTES ABBREVIATIONS, **LEGENDS AND SHEET INDEX**

> SHEET NUMBER: MP1.1

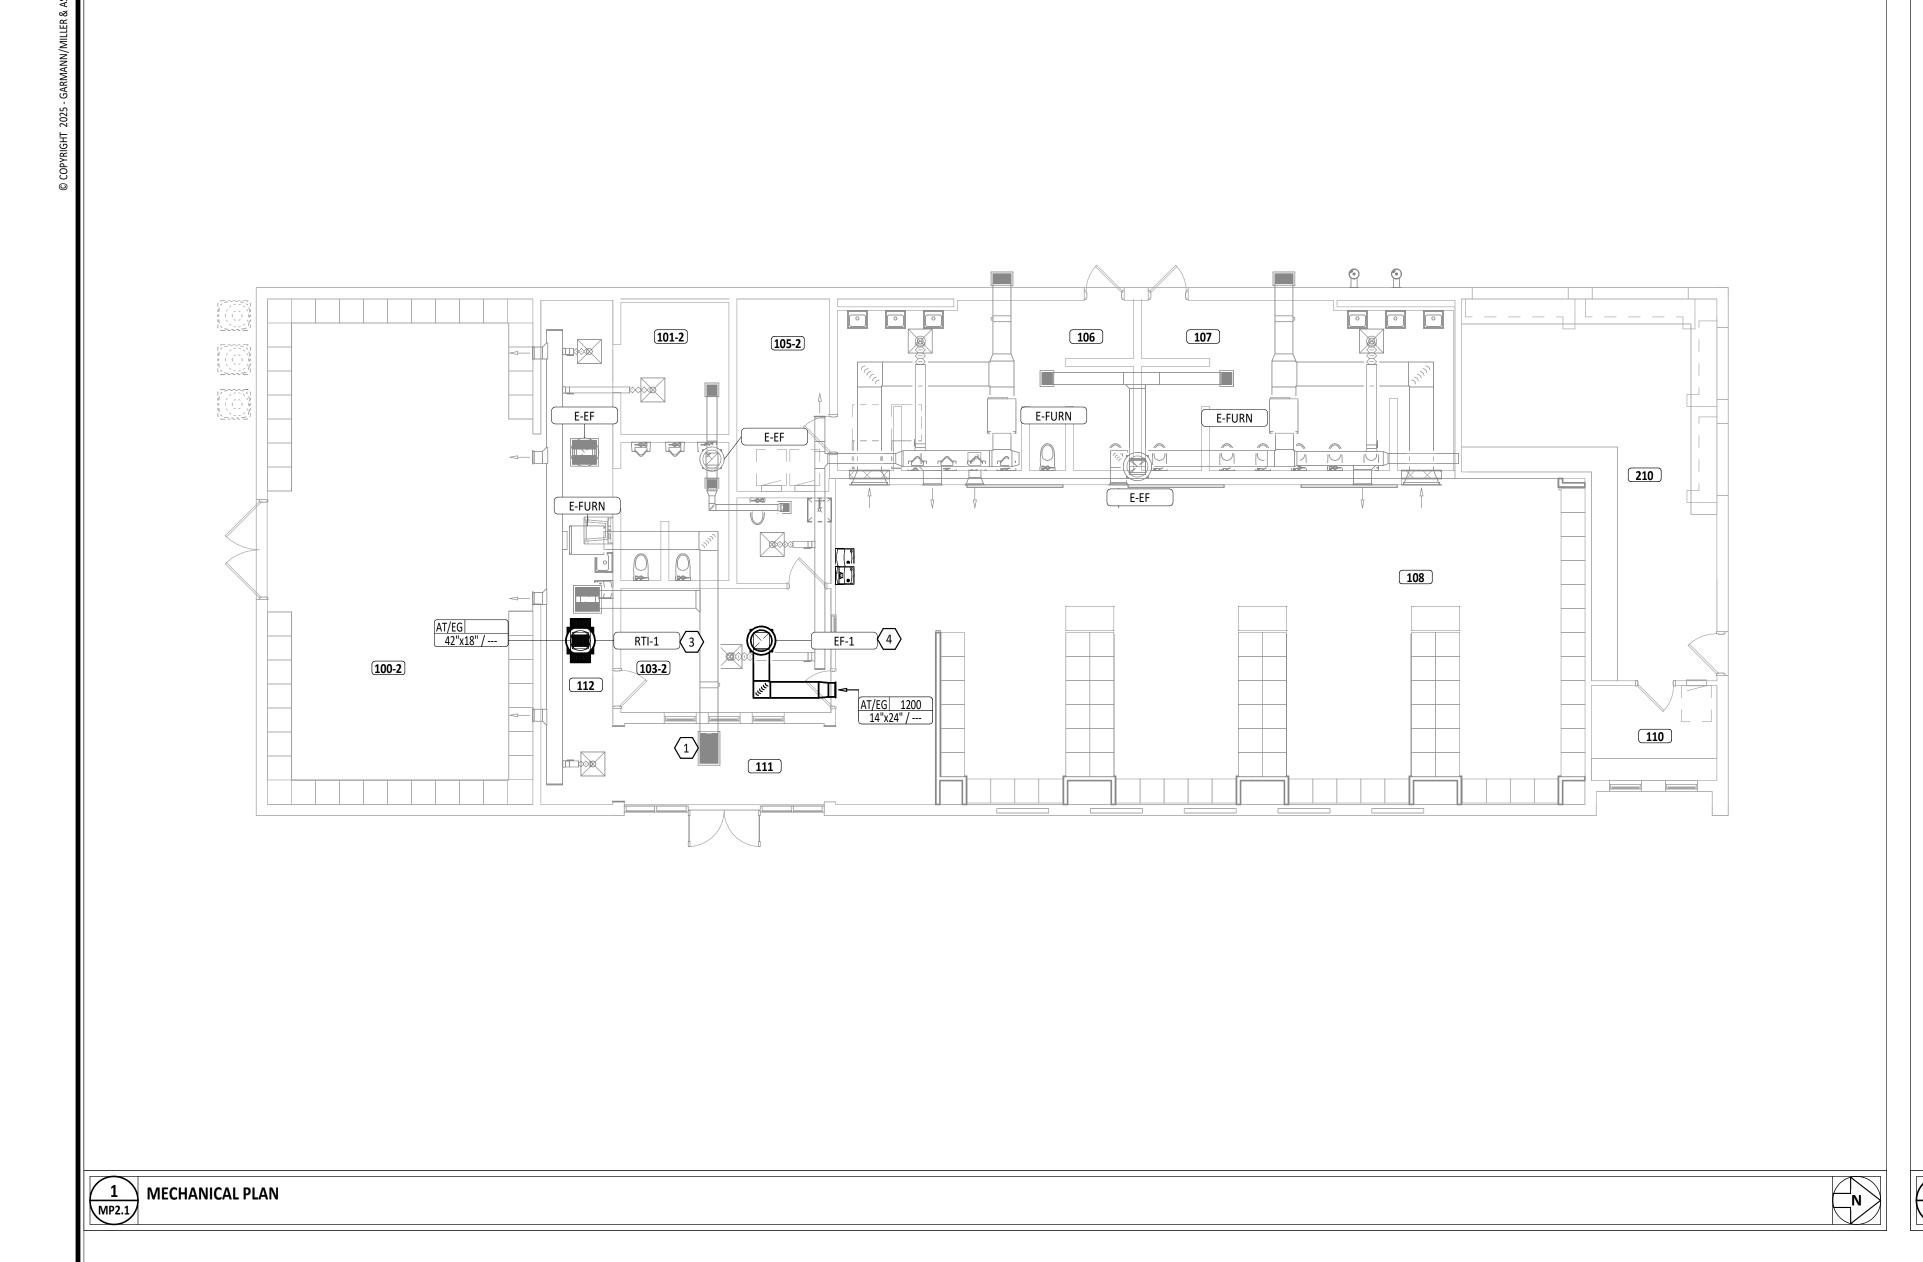

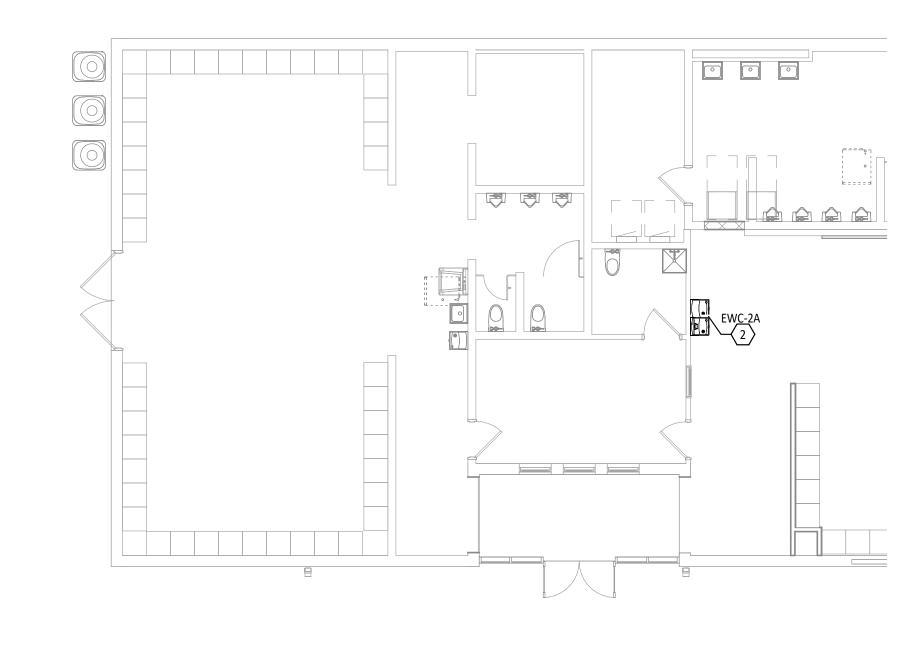

						GRAVITY V	ENTILATOR S	CHEDULE				
							D	IMENSION:	S			
				DESIGN		BIRD	THROAT	НС	OOD	UNIT		
ID	MANUFACTURER	MODEL NO.	TYPE	AIRFLOW	PD	SCREEN	WIDTH	WIDTH	LENGTH	WEIGHT	SERVES	REMARKS
RTI-1	GREENHECK	GRSI-20	SPUN ALUMINUM	2400 CFM	0.19 in-wg	Yes	1' - 8"	2' - 6"	2' - 6"	55 lb	EXHAUST MAKEUP	PROVIDE WITH ROOF CURB.

											EX	(HAUST F	AN SCHE	DULE						
							FAN										CONTROL	DISCONNECT		
					AIRFLOW	PRESS			МОТ	ΓOR							SPEED			
								DRIVE				ROOF	UNIT				CONTROLLE			
ID	MANUFACTURER	MODEL NO.	TYPE	ARRANGEMENT	DESIGN	ESP	RPM	TYPE	POWER	ECM	SONES	CURB	WEIGHT	FLA	VOLT	PH	R	TYPE	ACCESSORIES	REMARKS
EF-1	GREENHECK	G-140-VG	ROOF	DOWNBLAST	1200 CFM	0.32 in-wg	869	DIRECT	0.25 hp	Yes	7	Yes	75 lb	3.8 A	115 V	1	BY MFG	BY MFG	ROOF CURB	CONTROL BY DIVISION 26 TIMER SWITCH.

	FIRST FLOOR PLAN ROOM INDEX									
ROOM NUMBER	ROOM NAME	AREA								
100	LOCKER ROOM	935 SF								
101	SHOWER	99 SF								
102	TOILET	100 SF								
103	OFFICE	181 SF								
104	TOILET	56 SF								
105	MECHANICAL	124 SF								
106	MENS RESTROOM	327 SF								
107	WOMENS RESTROOM	349 SF								
108	FOOTBALL LOCKER ROOM	1,631 SF								
109	CONCESSIONS	491 SF								
110	TICKET OFFICE	83 SF								
111	ENTRANCE	124 SF								
112	CORRIDOR	255 SF								

HVAC GENERAL NOTES

- A REMOVE ALL UNUSED PIPING, DUCTWORK AND ACCESSORIES. DISPOSE OF THESE
- ITEMS OFF SITE.

 B THE MECHANICAL CONTRACTOR SHALL BE RESPONSIBLE FOR FIELD VERIFYING, PRIOR TO FINAL BID, ALL EXISTING CONDITIONS FOR PLUMBING AND MECHANICAL SYSTEMS WITHIN SCOPE AREA AND WITHIN CLOSE PROXIMITY OF THE SCOPE AREA.
- GRILLE LOCATIONS WITH ARCHITECTURAL REFLECTED CEILING PLANS.
 D ALL ROOF MOUNTED EQUIPMENT SHALL BE A MINIMUM 10'-0" FROM EDGE OF ROOF.
 E LOCATE DUCTWORK AND MECHANICAL EQUIPMENT AWAY FROM THE SPACE ABOVE ELECTRICAL PANELS. TRANSFORMERS AND OTHER ELECTRICAL EQUIPMENT.
 F PROVIDE SLEEVES AND/OR OPENINGS TO RUN DUCTS THROUGH FOUNDATIONS,

C DIVISION 23 MECHANICAL CONTRACTOR IS REQUIRED TO COORDINATE DIFFUSER AND

- FLOORS, WALLS, AND ROOF.

 G CONTRACTOR SHALL LOCATE THERMOSTATS AND TEMPERATURE SENSORS AT 3'-8"

 AFF, A MINIMUM OF 4" FROM LIGHT SWITCH.
- H COORDINATE INSTALLATION OF PIPING, DUCTWORK, CONDUIT, LIGHTS, CABLE TRAY, STRUCTURE, AND EQUIPMENT TO PREVENT CONFLICTS.
- THE CONTRACTOR SHALL BE FAMILIAR WITH ALL THE CONDITIONS BOTH EXISTING AND THOSE ILLUSTRATED BY THESE DOCUMENTS AS WELL AS THOSE WHICH CAN BE REASONABLY ANTICIPATED INCLUDING, BUT NOT LIMITED TO ARCHITECTURAL, ELECTRICAL, VENTILATION, PLUMBING, AND OTHER SYSTEMS INVOLVED ON THIS
- J FINAL PRODUCT SHALL BE A COMPLETE AND FUNCTIONING SYSTEM, AND SHALL CONFORM TO ALL REQUIREMENTS OF APPLICABLE FEDERAL, STATE, AND LOCAL CODES, INCLUDING BUT NOT LIMITED TO THE INTERNATIONAL BUILDING CODE AND INTERNATIONAL MECHANICAL CODE.
- INTERNATIONAL MECHANICAL CODE.

 K ADJUST PIPING AND DUCTWORK SIZES TO PROPERLY CONNECT TO MECHANICAL
- L INSTALL ALL EQUIPMENT IN ACCORDANCE WITH THE RESPECTIVE MANUFACTURER'S WRITTEN INSTALLATION INSTRUCTIONS, AT A LEVEL OF QUALITY AND WORKMANSHIP CONSISTENT WITH THE SPECIFICATIONS.
- M LOCATIONS OF PIPING, DUCTWORK AND EQUIPMENT AS INDICATED ON THE DRAWING, ARE APPROXIMATE AND SUBJECT TO MINOR ADJUSTMENTS IN THE FIELD. WORK SHALL BE COORDINATED WITH ALL OTHER TRADES TO AVOID INTERFERENCE IN THE FIELD. CONSULT ENGINEER IF MANUFACTURER'S MINIMUM CLEARANCE REQUIRED CAN'T BE MAINTAINED.

		KEYNOTE LEGEND
	#	KEYNOTE DESCRIPTION
	1	RELOCATE EXISITING FRESH AIR INTAKE TO EXTERIOR OF BUILDING. COORDINATE EXACT PLACEMENT ON SITE.
	2	REMOVE EXISTING ELECTRIC WATER COOLER. REPLACE WITH NEW DUAL HEIGHT / STATION WATER COOLER AS SCHEDULE. CONNECT TO EXISTING WATER, SANITARY, AND POWER. VERIFY EXACT LOCATION IN FIELD.
N	3	PROVIDE AND INSTALL NEW ROOFTOP INTAKE FOR EXHAUST SYSTEM(S) MAKEUP. PROVIDE DUCTWORK FROM HOOD TO GRILLE IN EXISTING CEILING. COORDINATE EXACT LOCATION WITH EXISTING STRUCTURE AND ATTIC DUCTWORK. INTAKE SHAL BE MINIMUM OF TEN FEET FROM NEAREST EXHAUST FAN. COORDINATE ROOF OPENING AND FLASHING WITH GENERAL CONTRACTOR.
	4	PROVIDE AND INSTALL NEW EXHAUST FAN. PROVIDE DUCTWORK FROM FAN TO

ROOF OPENING AND FLASHING WITH GENERAL CONTRACTOR.

GRILLE. GRILLE SHALL BE LOCATED BETWEEN EXISTING WALL FRAMING. COORDINATE EXACT LOCATION WITH EXISTING STRUCTURE AND ATTIC DUCTWORK. COORDINATE

MATTHEW R. HIBNER
LICENSE #1416052

EXPIRATION DATE: 12/31/2025



FORT LORAMIE LOCAL SCHOOLS LOCKER
ROOM BUILDING

ISSUANCES/REVISIONS

CONSTRUCTION DOCUMENTS 12/11/2025

PROJECT
NUMBER: DRAWN BY: CHECKED BY

CUEST TITLE

MECHANICAL AND PLUMBING PLAN

SHEET NUMBER:

DOMESTIC FIXTURE SCHEDULE FLOW FIXTURE FLUSH FIXTURE DESCRIPTION DESCRIPTION HEIGHT MANUFACTURER MODEL CONTROL WATER FLOW TEMP. TEMP. TEMP. SPECIFICATION REMARKS EWC-2A WATER COOLER W/ BOTTLE EZSTL8WSSK STAINLESS STEEL | STAINLESS STEEL | 33" & 38" TO 0.13 GPM 40 °F TWO LEVEL WALL HUNG WATER COOLER WITH BOTTLE FILLING STATION. THE UNIT SHALL BE COMPLETE WITH CABINET, MOUNTING FRAME, FRONT PUSH BUTTOM CABINET SPOUT CONTROL, VANDAL-RESISTANT BUBBLER, REFRIGERATING SYSTEM, AIR COOLED, 120 VOLT, 60 CYCLE, SINGLE PHASE POWER CONNECTION, FULLY AUTOMATIC, FILLER - ADA COMPLETE AND READY TO OPERATE.

KEYNOTE DESCRIPTION

1 REMOVE LIGHT FIXTURE AND SALVAGE FOR REINSTALLATION AS PART OF NEW WORK.


4 EXISTING PADDLE FAN TO BE REMOVED. EXISTING CIRCUIT TO REMAIN. REFER TO

5 REMOVE EXISTING CARD READER AND ACCESS CONTROL FOR REINSTALLATION AS

2 REMOVE LIGHT FIXTURE AND ASSOCIATED CIRCUITRY. 3 REMOVE RECEPTACLE AND ASSOCIATED CIRCUITRY.

PART OF NEW WORK

NEW WORK POWER PLAN FOR MORE INFORMATION.

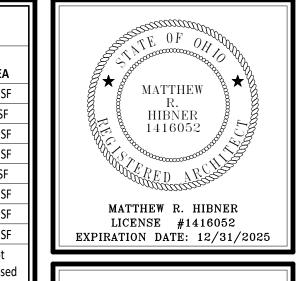

7	
Z	SIANA
A A	NSTER, OHIO COLUMBUS, OHIO INDIANAPOLIS, INDIANA FORT WAYNE, INDIANA credtegm.com
$\Sigma \overline{\square}$	IANA FOR
2	APOLIS, IND
ΔĦ	O INDIANAPOLIS credtegm.com
IJΣ	MBUS, OHIC
	IO I COLU
	STER, OH

GARMAN GARNAL GARNAN MINSTER, OHIO 1 COLUMBUS, OHIO 1 INDIANA Credition.com	

LOCKER FORT LORAMIE LOCAL

CONSTRUCTION DOCUMENTS 12/11/2025


PROJECT
NUMBER: DRAWN BY: CHECKED BY: **25041.00** SJH

ELECTRICAL DEMOLITION PLAN

> SHEET NUMBER: ED1.1


ELECTRICAL DEMOLITION PLAN
1/8" = 1'-0"

E

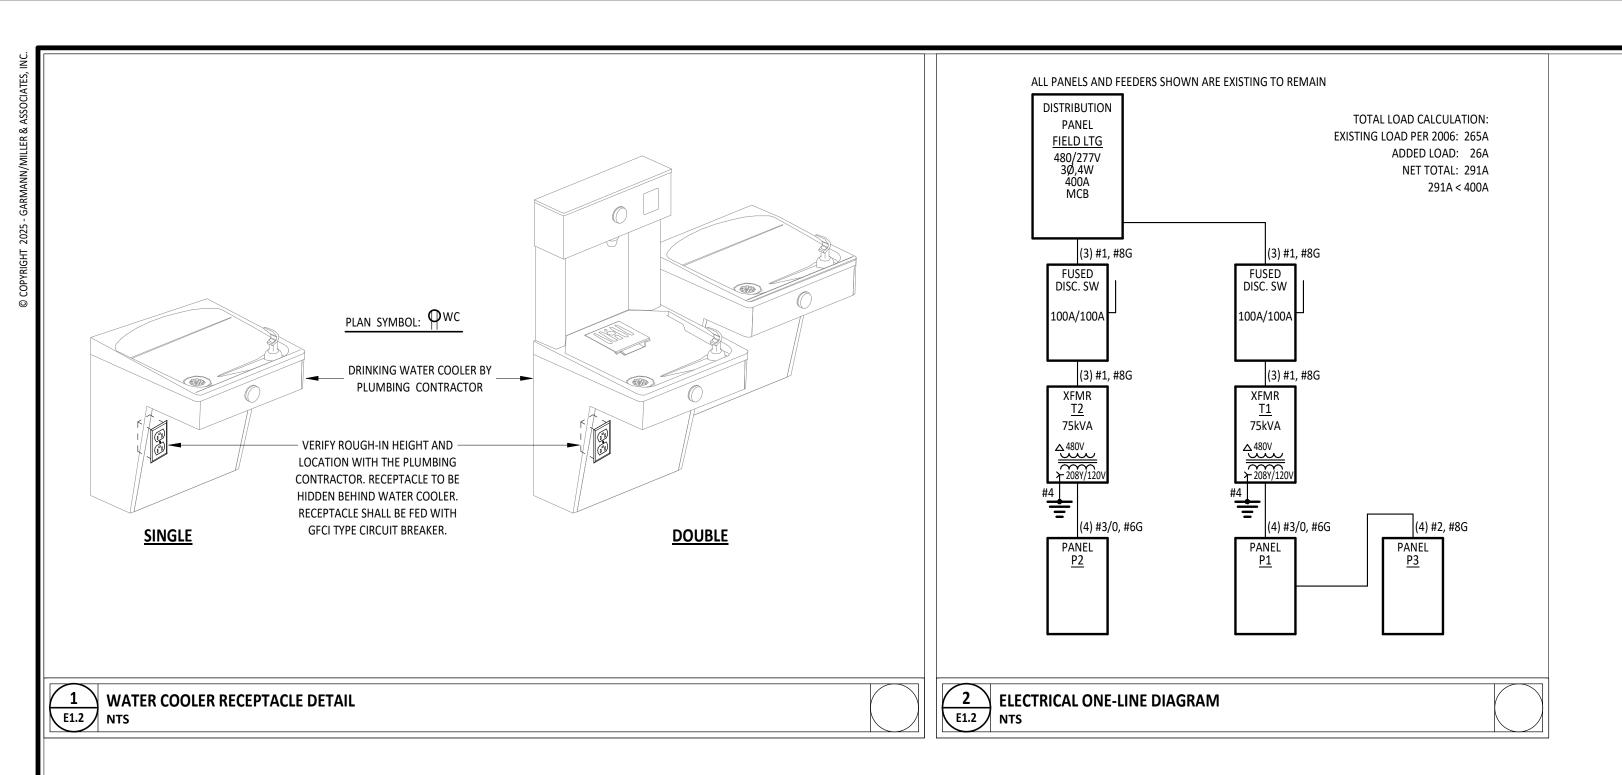

	LUMINAIRE SCHEDULE										
		LAMPS				FIXTURE	INPUT				
MARK	MOUNTING	TYPE	MIN. LUMENS	CCT	CRI	BALLAST/DRIVER	VOLTAGE	WATTS	FIXTURE DESCRIPTION	COMMENTS	BASIS OF DESIGN & APPROVED MANUFACTURERS
C1	SURFACE	LED	4000 lm	4000K	80 CRI	0-10V DIMMING DOWN TO 10%	UNV	54 W	LED SURFACE WRAP	SET LUMENS TO LOW AND CCT TO MATCH EXISTING LIGHTING.	LITHONIA FML4W 48 ALO6 8SWW2 TD
E						2011110 2011		0 W	EXISTING LUMINAIRE TO REMAIN.		
ED								0 W	EXISTING LUMINAIRE TO BE REMOVED.		
ER								0 W	EXISTING LUMINAIRE REMOVED AND RE-INSTALLED.		
R2	WALL	LED	N/A	N/A	N/A	ELECTRONIC DRIVER	7.2V	1 W	LED WEATHER-PROOF REMOTE HEAD		LITHONIA ELMRW LP220L SGL
X5	WALL	LED	N/A	RED	N/A	ELECTRONIC DRIVER	UNV	4 W	LED EXIT-EMERGENCY COMBINATION		LITHONIA LHQM S W RG MVOLT M6
Х6	WALL	LED	N/A	RED	N/A	ELECTRONIC DRIVER	UNV	4 W	LED EXIT-EMERGENCY COMBINATION WITH REMOTE CAPACITY		LITHONIA LHQM S W RG MVOLT HO M6

	MOUNTING: SURFACE FED FROM: T2 XFMR ENCLOSURE: NEMA 1 LOCATION: MECHANICAL-1 NEL NOTES: STING CUTLER-HAMMER LOAD C					PA	ANEL P2		ı	V MAINS	OL R NS	ATING: EXISTING .TAGE: 208Y/120V 3PH 4W ATING: 225 A STYPE: 200 A MCB DTHER:	
N O T E	CIRCUIT DESCRIPTION	P O L E S	AMP	C K T	A		В	С	C K T	AMP	P O L E S		
	EXIST. CKT.	1	20	1	0/0				2	20	1	EXIST. CKT.	
2	WC RECEPTACLE FOOTBALL LOCKER ROOM 108	1	20	3			1200 / 0		4	20	1	EXIST. CKT.	
	EXIST. CKT.	1	20	5				0/0	6	20	1	EXIST. CKT.	
	EXIST. CKT.	1	20	7	0/0				8	20	1	EXIST. CKT.	
	EXIST. CKT.	1	20	9			0/0		10	20	1	EXIST. CKT.	
	EXIST. CKT.	1	20	11				0/0	12	20	1	EXIST. CKT.	
	EXIST. CKT.	1	20	13	0 / 0				14	20	1	EXIST. CKT.	
	EXIST. CKT.	1	20	15			0 / 0		16	20	1	EXIST. CKT.	
	EXIST. CKT.	1	20	17				0/0	18	20	1	EXIST. CKT.	
1	VID RECEPTACLE FOOTBALL LOCKER ROOM 108	1	20	19	540 / 430				20	20	1	RECPT. AND DOOR SECURITY ENTRANCE 111	•
1	EF-1	1	15	21		4	456 / 119		22	20	1	LIGHTING ENTRANCE 111	
1	SOUND RACK 103-2	1	20	23				360 / 0	24	20	1	EXIST. CKT.	
				25	0 / 0				26		1	SPACE ONLY	
	WATER HEATER	3	100	27			0 / 0		28				
				29				0/0	30	100	2	EXIST. CKT.	
	SPACE ONLY	1		31	0 / 0				32		1	SPACE ONLY	
	SPACE ONLY	1		33			0/0		34		1	SPACE ONLY	
	SPACE ONLY	1		35				0/0	36		1	SPACE ONLY	
	SPACE ONLY	1		37	0 / 0				38		1	SPACE ONLY	
	SPACE ONLY	1		39			0/0		40		1	SPACE ONLY	
	SPACE ONLY	1		41				0 / 0	42		1	SPACE ONLY	
			JBTOTA JBTOTA		970 VA 9 A	1	1770 VA 16 A	360 VA 3 A				1	
LOA	AD TYPE: CONNECTED VA	D	EMAND FACTOR) [DEMAND DEM	AND MPS	SUBTOTAL	PHASE	~	חסיייד	N/~	ATEC.	
МОТ	HTING 119 VA FORS 456 VA EEPTACLE 2280 VA	•	125.0% 125.0% 125.0%))	149 VA 570 VA 2280 VA	0 A 2 A 6 A	970 VA 1770 VA 360 VA	A B C	1-F 2-F)E I	<u>NES:</u> NEW BREAKER IN EXISTING SPAC EXISTING BREAKER WITH NEW G	
	C EQUIPMENT 250 VA		100.0%		250 VA	1 A	PANEL 3100 VA 3242 VA	TOTALS CONNECTED DEMAND					
							9 A 9 A	DEMAND	2				

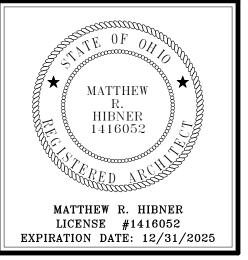



ORT LORAMIE LOCAL SCHOOLS LOCKER ROOM BUILDING

ISSUANCES/REVISIONS


CONSTRUCTION DOCUMENTS | 12/11/2025


PROJECT DRAWN BY: CHECKED BY:

25041.00 SJH HJP

SHEET TITLE:

ELECTRICAL
DETAILS, PANEL
AND LUMINAIRE
SCHEDULES

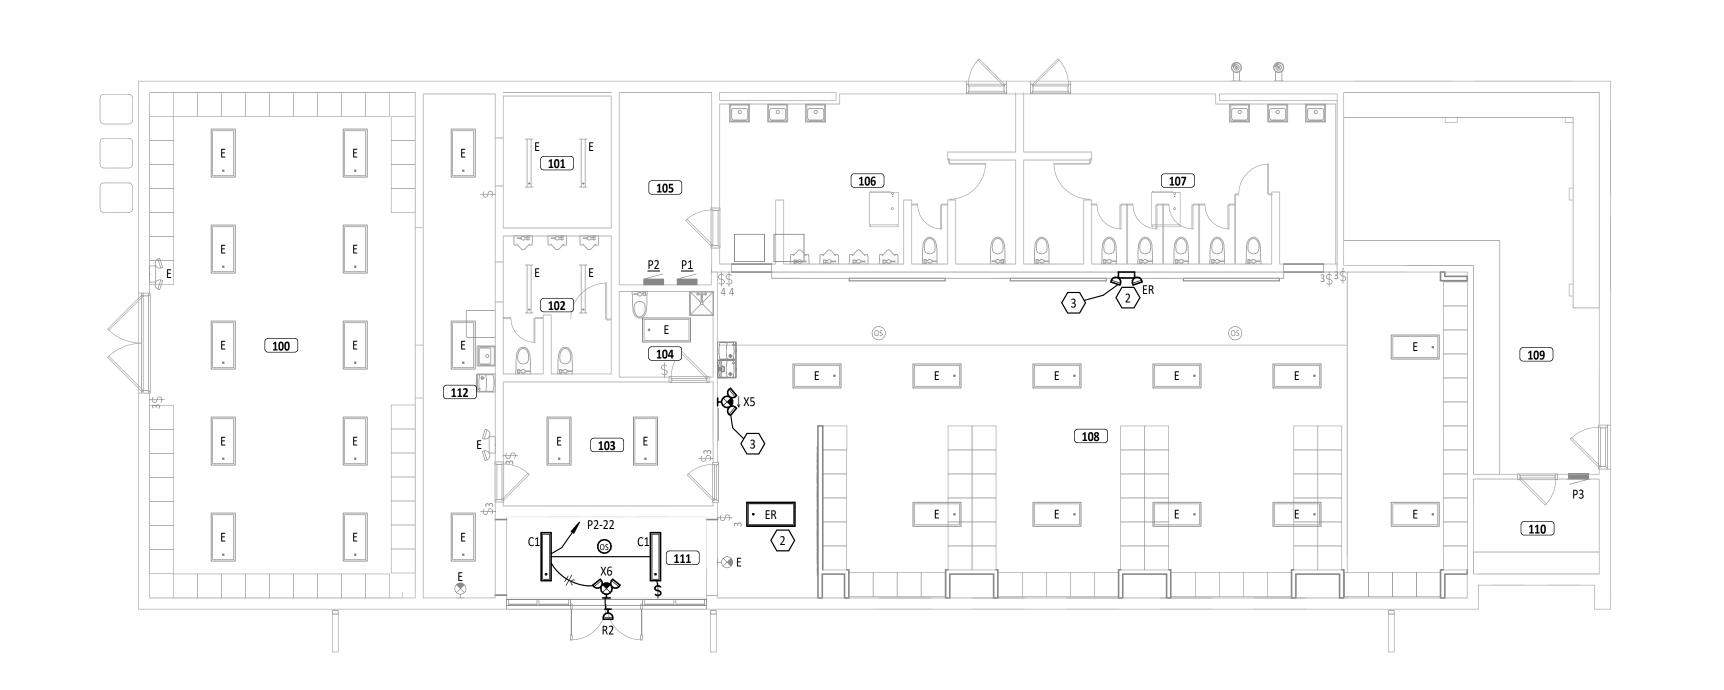

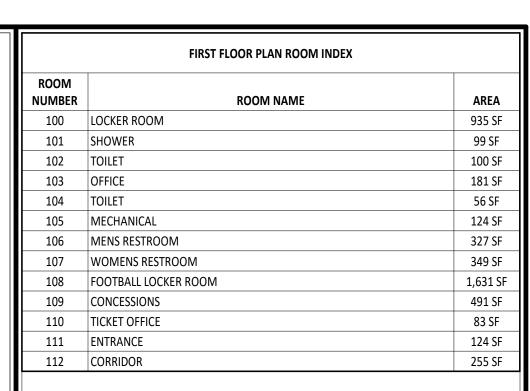

LIGHTING GENERAL NOTES

- A REFER TO ARCHITECTURAL REFLECTED CEILING PLANS ON THE A7 SERIES DRAWINGS FOR ADDITIONAL INFORMATION AND EXACT LOCATION OF LUMINAIRES.
- B VERIFY EXACT LOCATION OF ALL LIGHT SWITCHES AND CONTROLS DEVICES WITH ARCHITECTURAL DRAWINGS PRIOR TO ROUGH-IN.
- C WHERE MULTIPLE SWITCHES ARE GROUPED TOGETHER AT A SINGLE LOCATION, ALL SWITCHES SHALL BE INSTALLED UNDER A COMMON FACEPLATE.
- D CIRCUIT ALL EMERGENCY LIGHTS, NIGHT LIGHTS (IF APPLICABLE) AND EXIT LIGHTS TO AN UNSWITCHED HOT CONDUCTOR, UPSTREAM OF ALL CONTROLS.
- E REFER TO SHEET E1.2 FOR LUMINAIRE SCHEDULE AND ADDITIONAL INFORMATION.
- F ALL LIGHTING CONTROL DEVICES, RELAYS, ETC. ABOVE LAY-IN CEILINGS SHALL BE MARKED WITH A BLACK 3/4" DIAMETER, PRESSURE-SENSITIVE ADHESIVE PAPER CIRCLE. G ALL MOUNTING HEIGHTS REFER TO BOTTOM OF LIGHT FIXTURE, UNO.

#	KEYNOTE DESCRIPTION
1	PROVIDE POWER CONNECTION ABOVE CEILING FOR ELECTRIC STRIKE POWER
	PACK(S), TRANSFORMER(S) AND ACCESS CONTROL PANEL(S). REFER TO
	TECHNOLOGY SHEETS FOR EXACT QUANTITIES.
2	RE-INSTALL LIGHT FIXTURE SALVAGED FROM DEMOLITION. MODIFY AND
	EXTEND EXISTING CIRCUITRY AS NECESSARY.
3	CONNECT TO EXISTING LIGHTING CIRCUIT SERVING THIS AREA AHEAD OF SWITCHING.
4	CONNECT TO EXISTING WC RECEPTACLE CIRCUIT. MODIFY AND EXTEND EXISTING CIRCUIT AS NECESSARY.
5	EXHAUST FAN PROVIDED WITH INTEGRAL DISCONNECT. EXHAUST FAN AND ASSOCIATED LOUVER TO BE

ASSOCIATED LOUVER TO BE CONTROLLED BY DIGITAL TIMER SWITCH PROVIDED BY E.C. PROVIDE ALL NECESSARY ELECTRICAL CONNECTIONS. RE-INSTALL PADDLE FAN SALVAGED FROM DEMOLITION. MODIFY EXISTING CIRCUIT AS NECESSARY.

PROVIDE SURFACE RACEWAY (WIREMOLD 700 SERIES OR EQUAL) IF NEW CONDUIT AND BACK BOX CAN NOT BE CONCEALED IN EXISTING WALL. COORDINATE INSTALLATION OF DOOR SECURITY EQUIPMENT WITH

STOREFRONT INSTALLER PRIOR TO ROUGH-IN.

HIBNER

MATTHEW R. HIBNER

LICENSE #1416052

EXPIRATION DATE: 12/31/2025

LOCKER SCHOOLS

FORT

ISSUANCES/REVISIONS


CONSTRUCTION DOCUMENTS 12/11/2025


ELECTRICAL PLAN


SHEET NUMBER:


2 POWER & SYSTEMS PLAN 1/8" = 1'-0"


1 LIGHTING PLAN 1/8" = 1'-0"

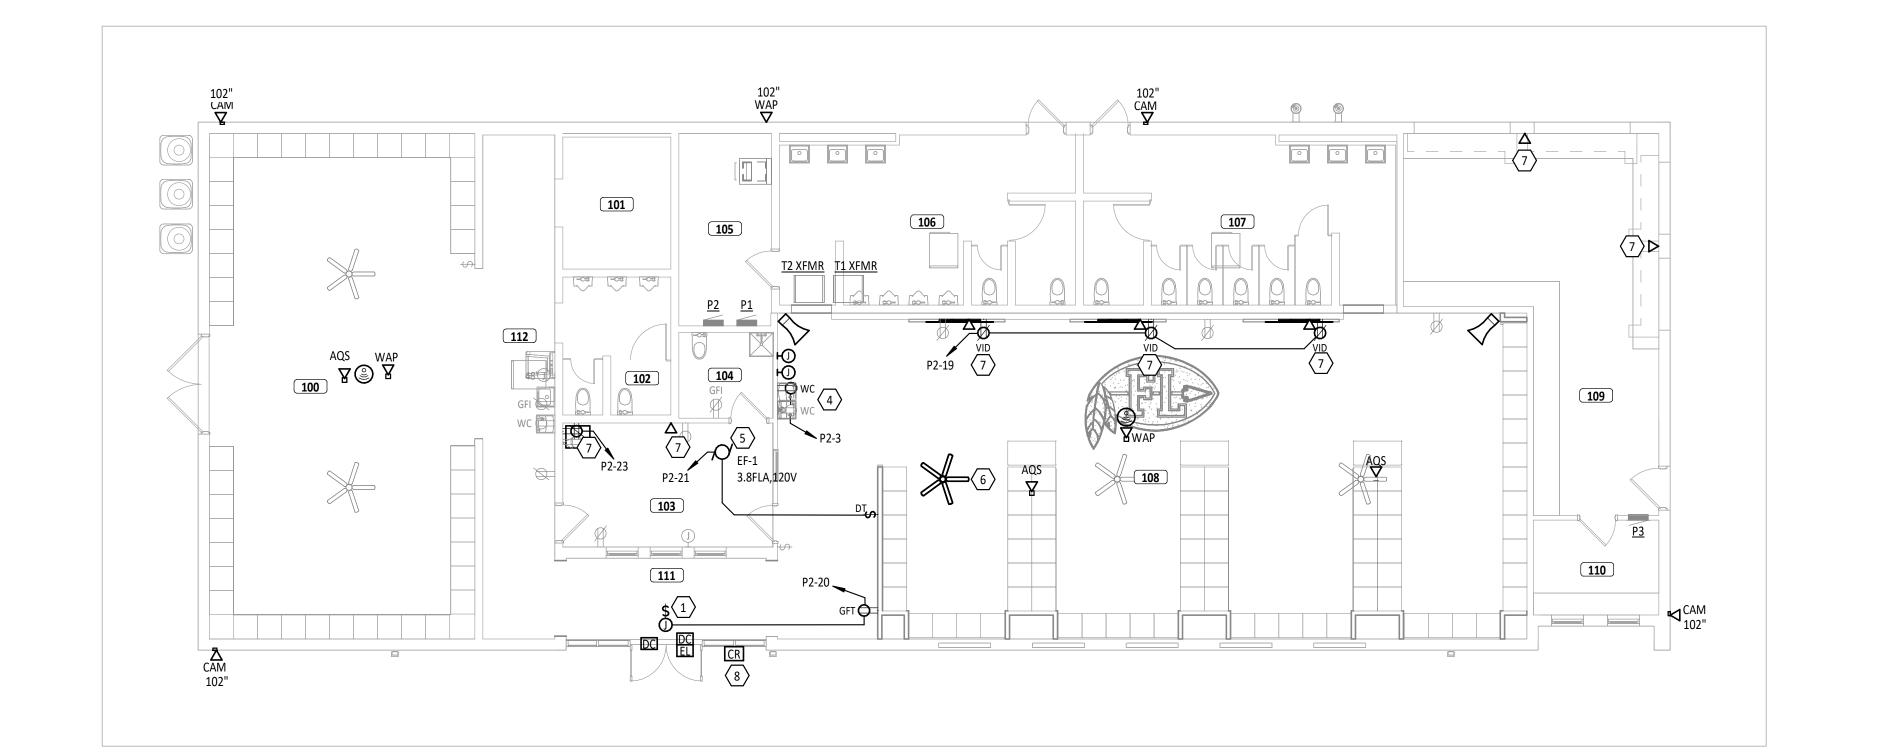

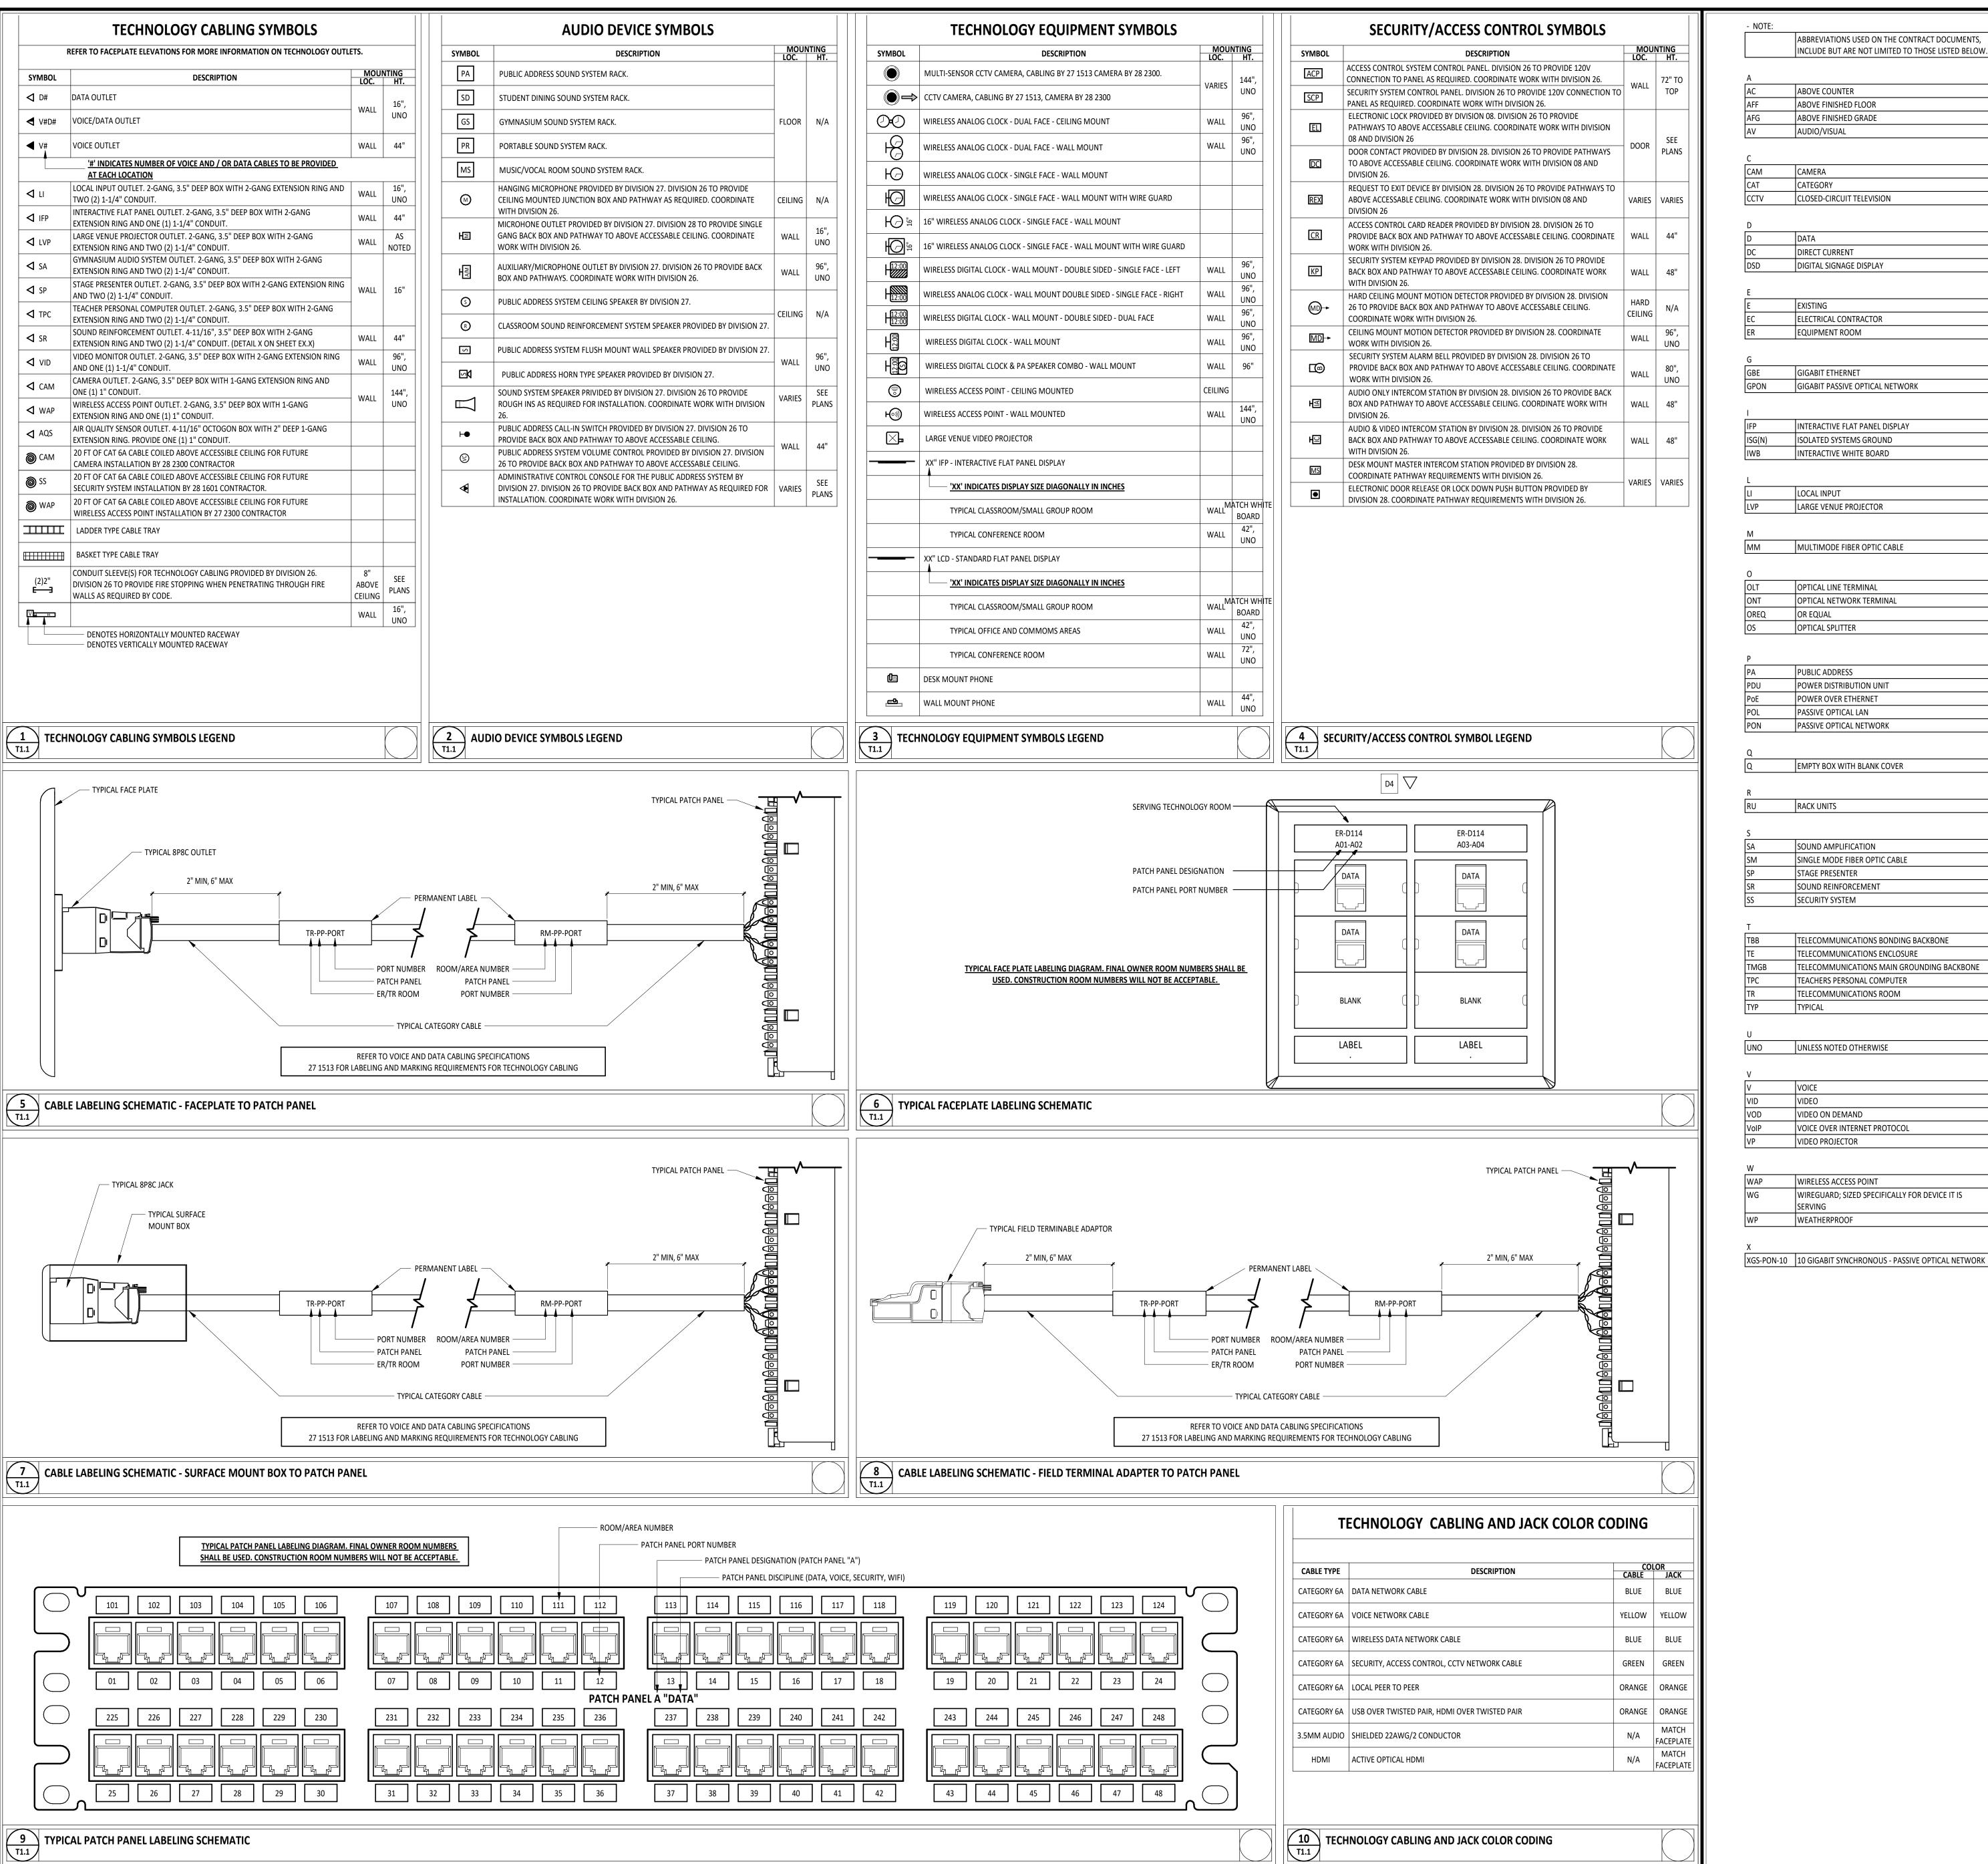

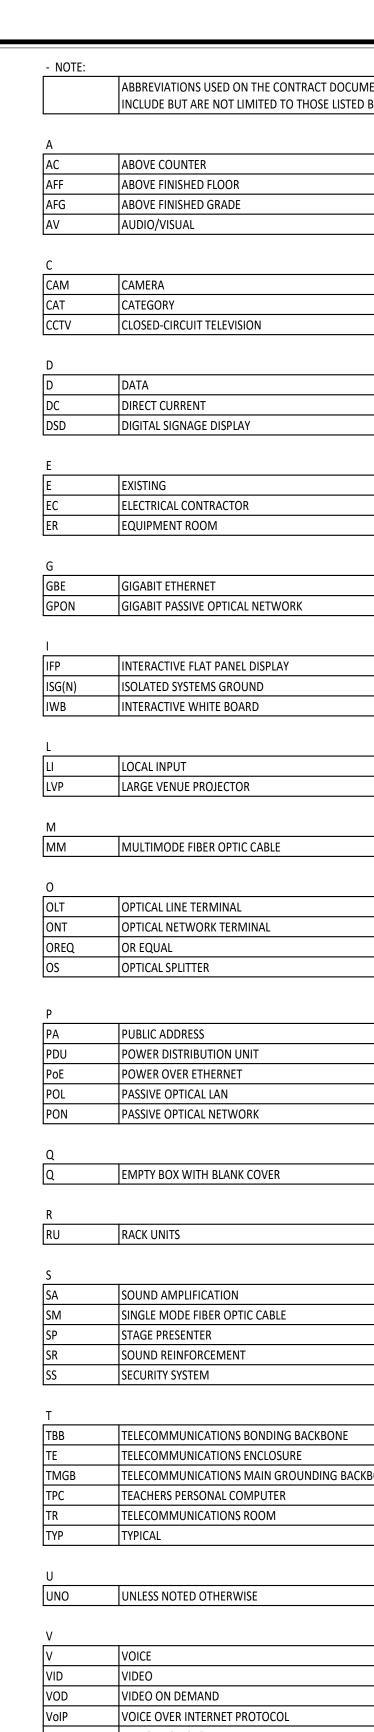

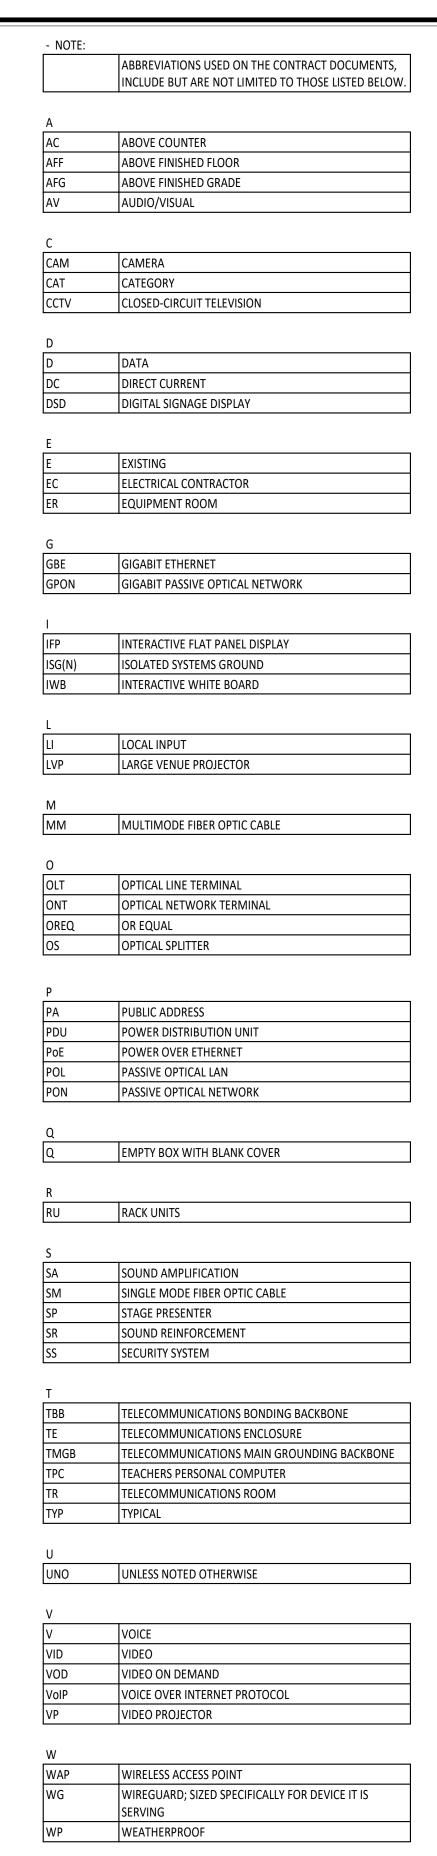

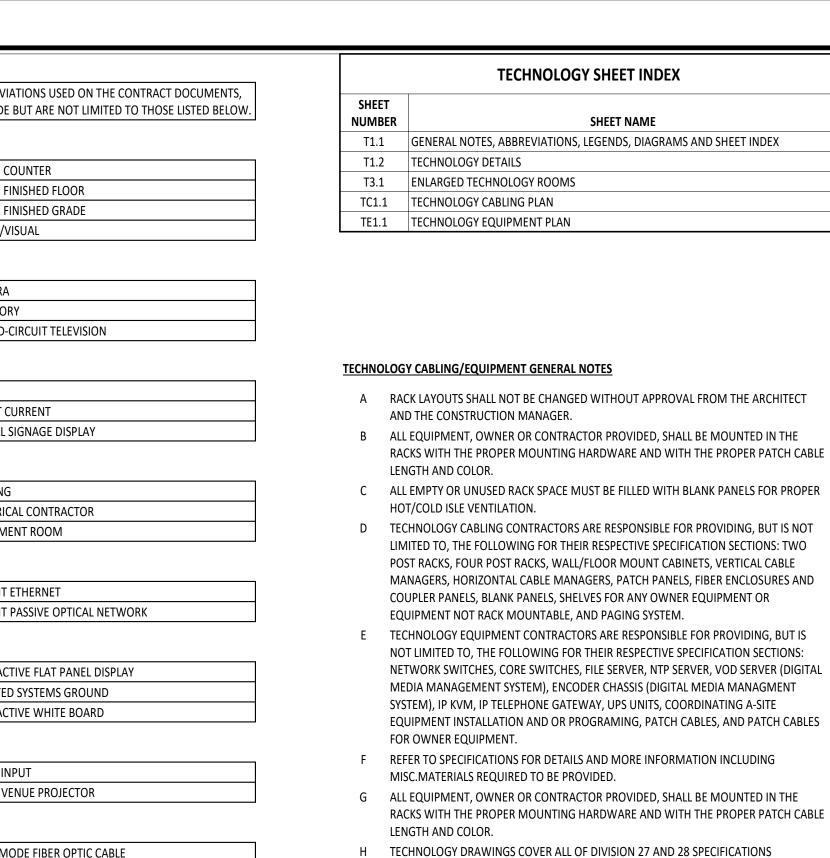

SUBMITTING BIDS..

MATCH SURROUNDING AREA.

VENDOR SPECIFIC REQUIREMENTS.

ANSI/TIA/EIA-606 STANDARDS.

EDGES WITH FLUSH CUTTERS.

PLENUM RATED.

CABLING FOR EACH TECHNOLOGY ROUGH-IN INDICATED.

P PROVIDE COVER PLATES ON ALL EMPTY TECHNOLOGY ROUGH-INS.

EACH WAP LOCATION REQUIRES TWO (2) SHIELDED CAT 6a CABLES.

CATV, AND ITC DEMARCS/SERVICE ENTRANCES.

STOPPING PER THE LASTEST CODES AND STANDARDS.

EXCLUDING FIRE ALARM. IT IS HIGHLY RECOMMENDED THAT THE CONTRACTOR REVIEWS DIVISION 27 AND 28 SPECIFICATIONS AND ATTENDS THE PRE BID MEETING PRIOR TO

ALL CABLING IN EXPOSED AREAS MUST BE ENCLOSED IN A CONDUIT. PAINT CONDUIT TO

THE ELECTRICAL CONTRACTOR SHALL BE RESPONSIBLE FOR ALL TECHNOLOGY SYSTEMS

ROUGH-IN REQUIREMENTS, COORDINATE WITH THE SYSTEMS SUPPLIER FOR ANY

CONTRACTORS SHALL PROVIDE APPROPRIATE FACEPLATES, JACKS, CONNECTORS, AND

CONTRACTORS SHALL PROVIDE ALL TERMINATIONS FOR CABLING INDICATED.

M CONTRACTORS SHALL LABEL ALL CABLING AS REQUIRED BY PER THE LASTEST NEC AND

N CABLE TIES ARE FOR OUTDOOR USE ONLY AND SHALL BE TRIMMED TO AVOID SHARP

O PROVIDE BLACK NON-PRINTED VELCRO STRAPS FOR INDOOR USE. USE PLENUM WHERE

CONTRACTORS SHALL COORDINATE INSTALLATION AND GROUNDING OF TELEPHONE,


TYPICAL TECHNOLOGY ROUGH-INS, IN NEW WALLS, ARE 2-GANG OUTLET BOXES, 3-1/2"


TECHNOLOGY ROUGH-INS ON EXISTING WALLS WILL BE SURFACE MOUNTED DUAL

ANY PENETRATION THROUGH FIRE WALLS MUST USE 2" CONDUIT AND PROPER FIRE

U CEILING SPACE IS USED AS A PLENUM, ALL CABLE AND INSULATION MATERIALS SHALL BE

DEEP WITH A MIN OF 1-1/4" CONDUIT STUBBED ABOVE ACCESSIBLE CEILING.

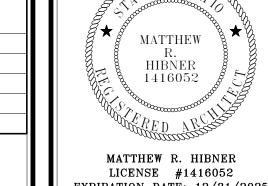

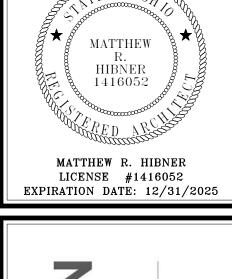



ш 0 0


ISSUANCES/REVISIONS CONSTRUCTION DOCUMENTS | 12/11/2025


NUMBER: DRAWN BY: CHECKED BY: **25041.00** CDT


SHEET TITLE:

GENERAL NOTES, ABBREVIATIONS, LEGENDS, **DIAGRAMS AND SHEET INDEX**

> SHEET NUMBER: T1.1

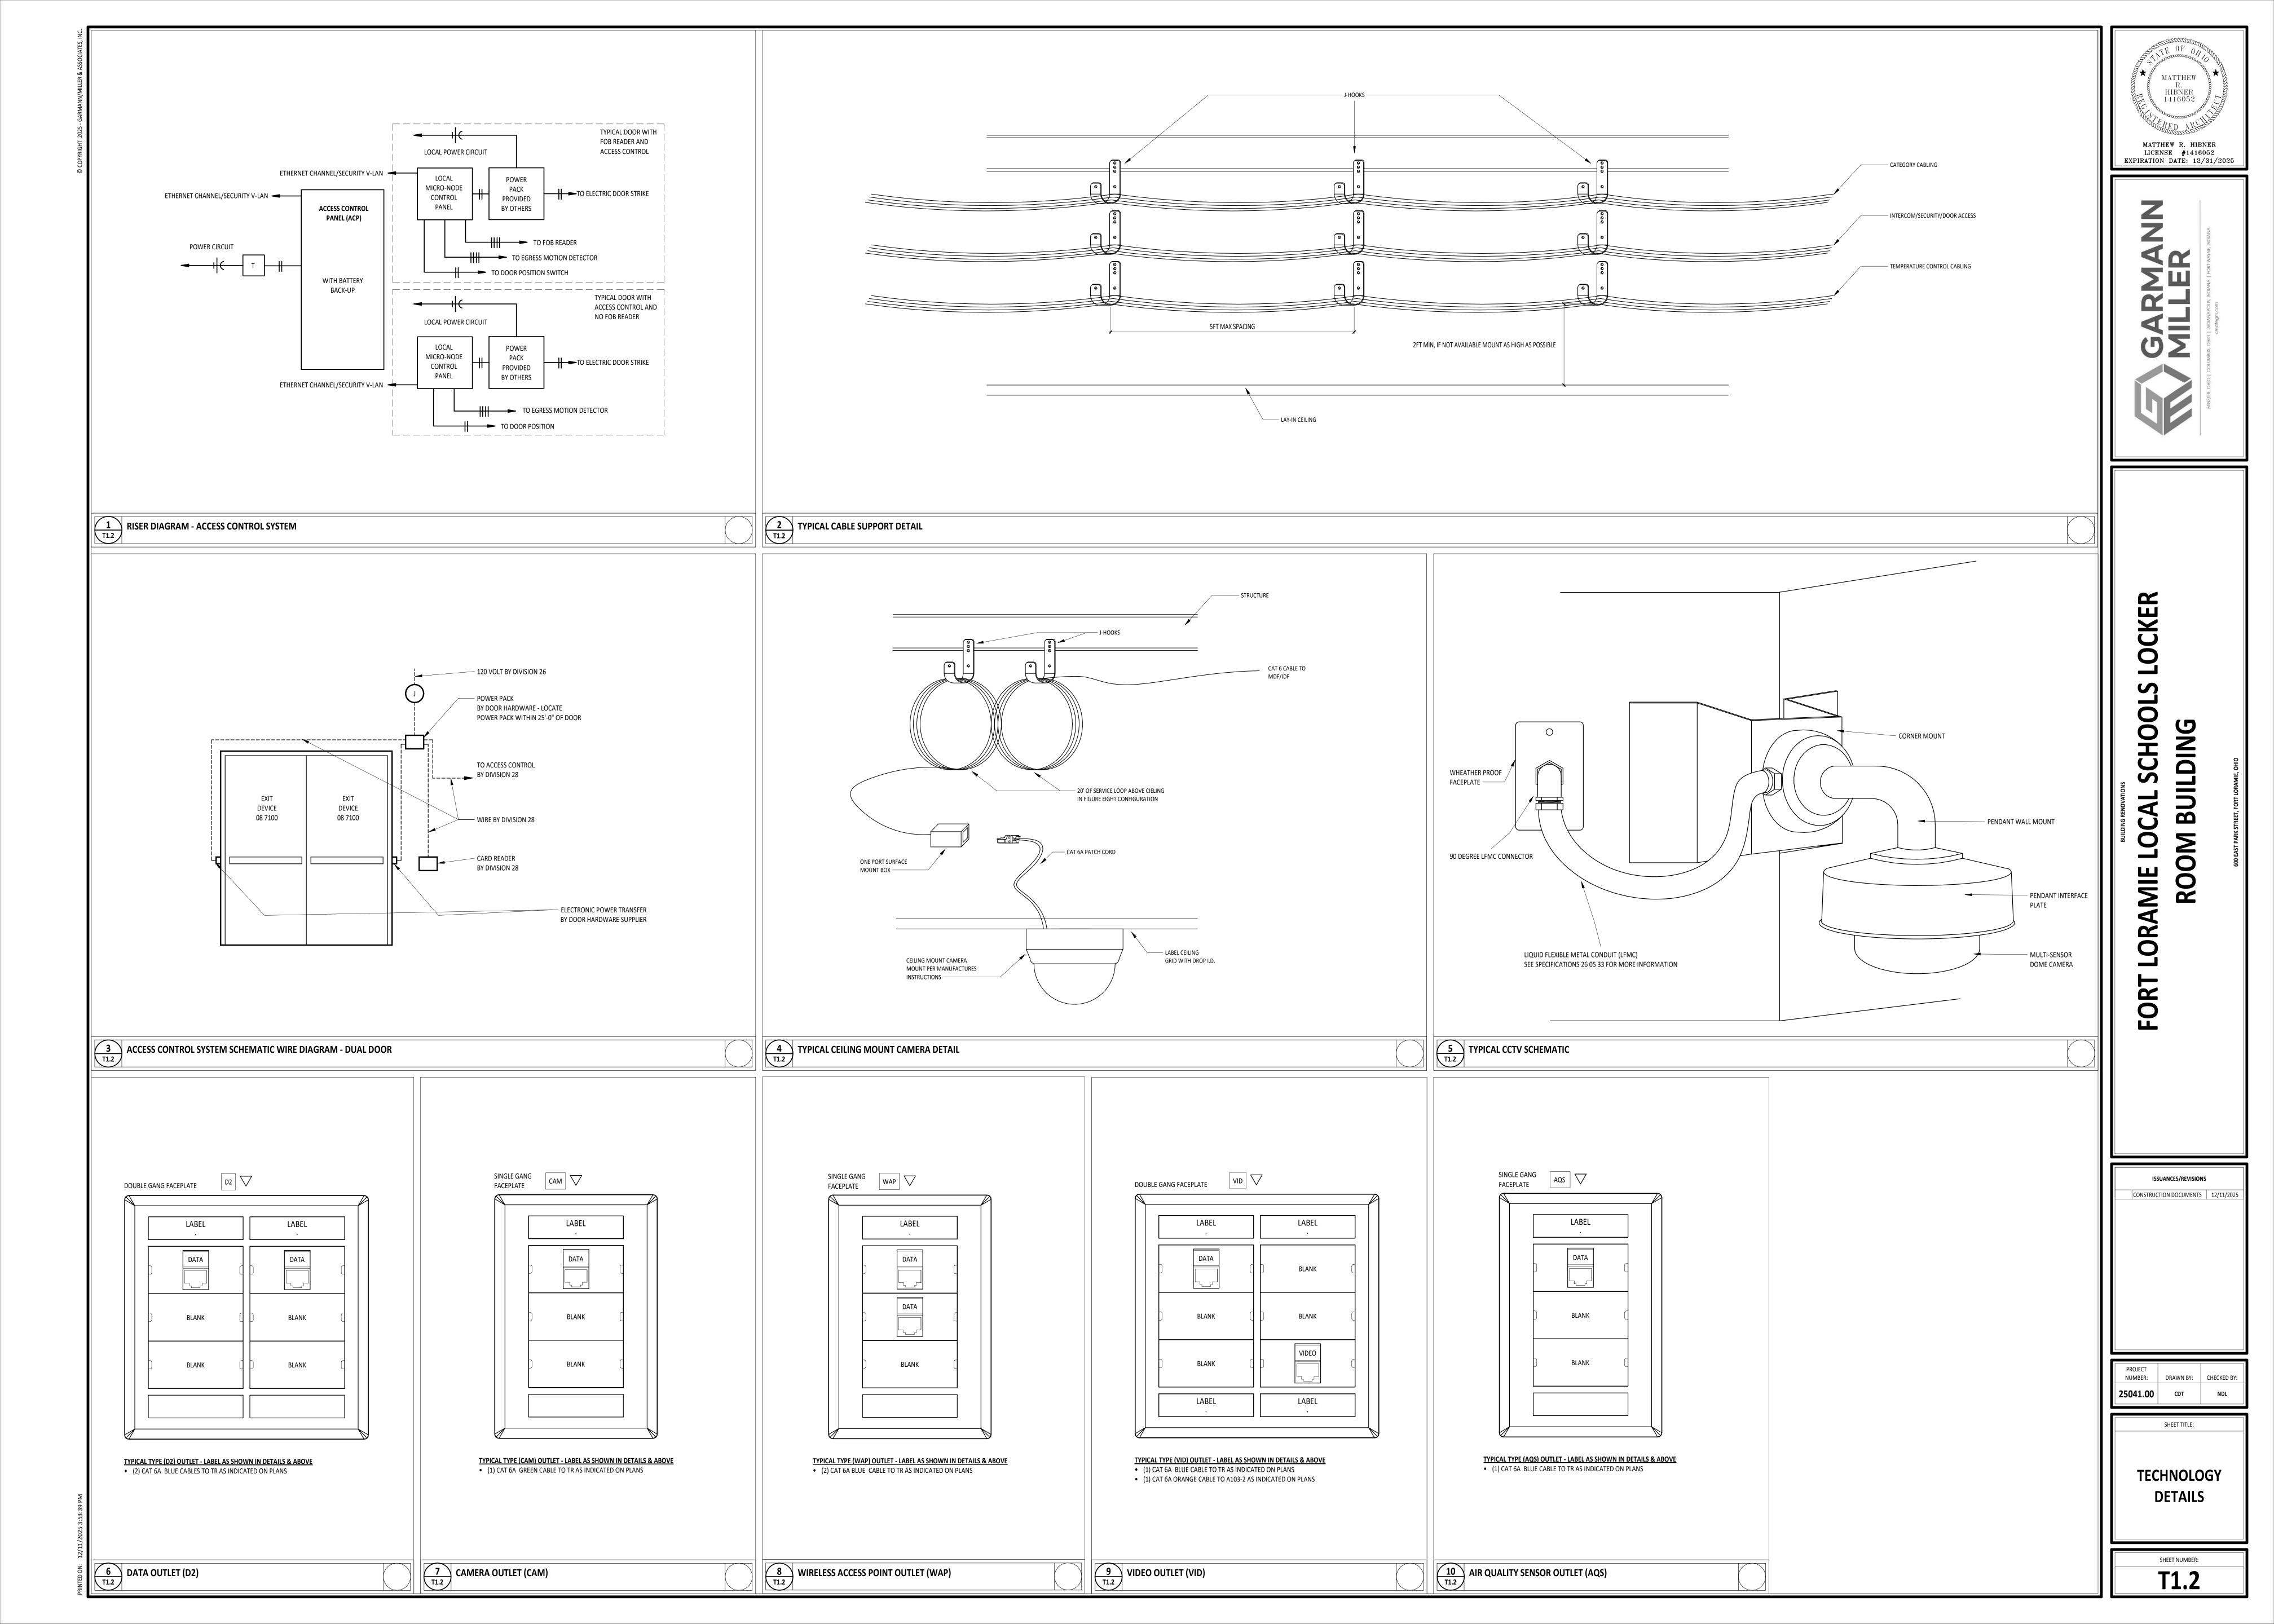

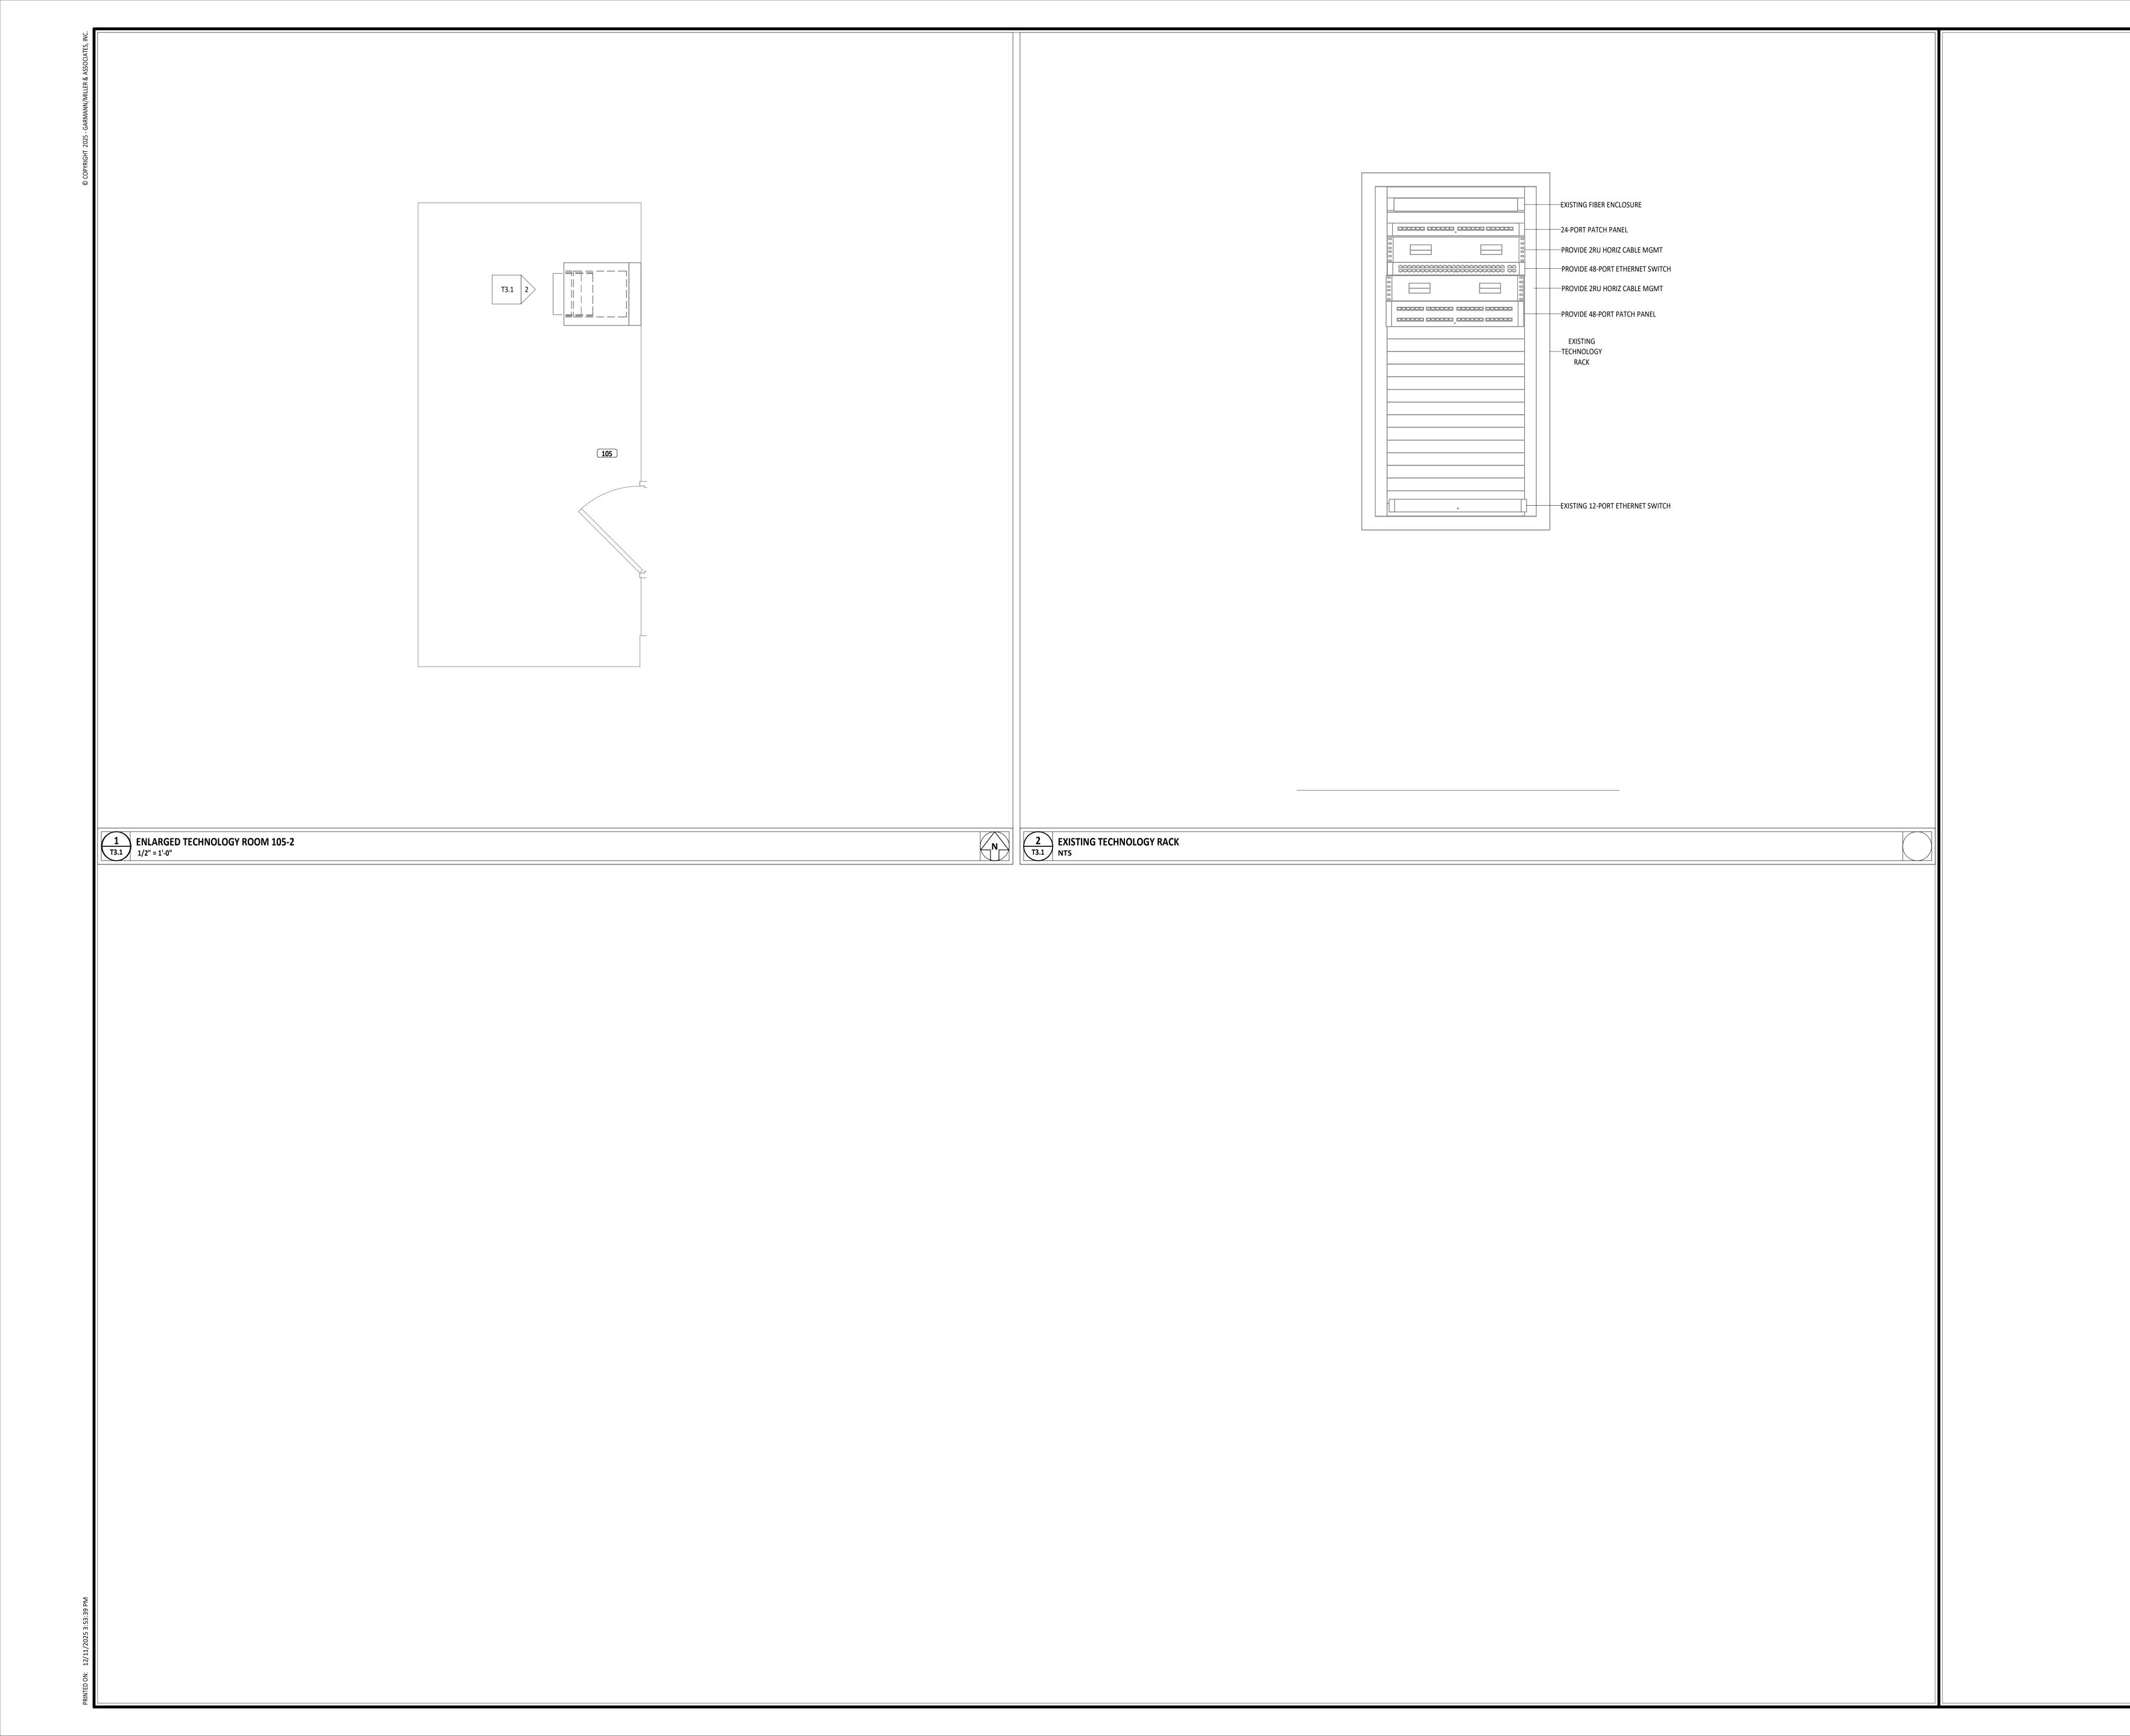

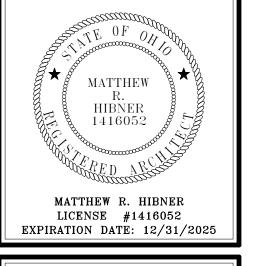



FORT LORAMIE LOCAL SCHOOLS LOCKE
ROOM BUILDING

ISSUANCES/REVISIONS


CONSTRUCTION DOCUMENTS 12/11/2025


PROJECT NUMBER: DRAWN BY: CHECKED BY:

25041.00 CDT NDL

SHEET TITLE:

ENLARGED TECHNOLOGY ROOMS

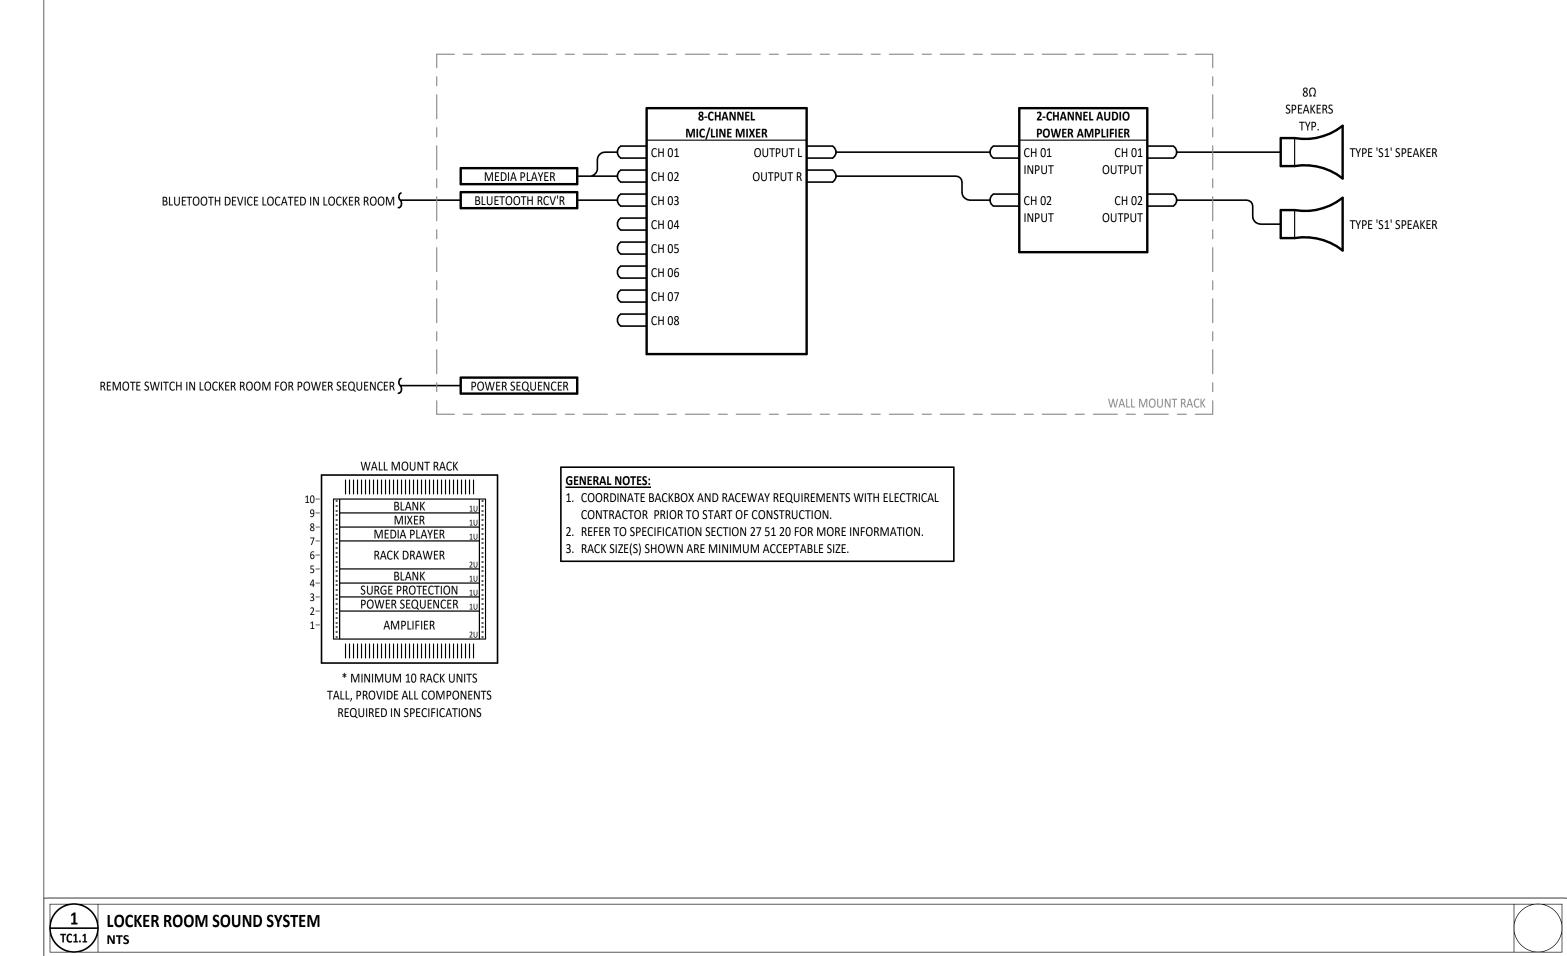

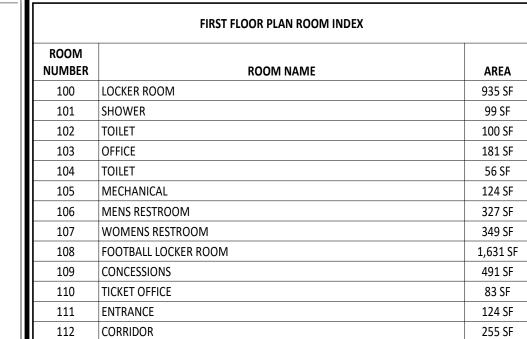

	303
	124
	327
1	349
DOM	1,631
	491
	83 S
	124
	255

KEYNOTE	LEGE

KEYNOTE DESCRIPTION
DOOR PROVIDED WITH ELECTRIC STRIKE BY DOOR HARDWARE SUPPLIER. DOOF
HARDWARE SUPPLIER TO PROVIDE POWER PACK WITH DRY CONTACT FOR
ELECTRIC STRIKE. PROVIDE WIRING FROM ELECTRIC STRIKE POWER PACK TO
ACCESS CONTROL SYSTEM. COORDINATE WORK WITH HARDWARE SUPPLIER
PRIOR TO ROUGH-IN. CONNECT DOOR TO ACCESS CONTROL SYSTEM TO
PROVIDE INDIVIDUAL TIMED CONTROL OF THE ELECTRIC STRIKE. DIVISION 26 TO
PROVIDE ALL PATHWAYS AND POWER REQUIRED FOR PROPER OPERATION.
REINSTALL SALVAGED CARD READER AND ACCESS CONTROL FROM DEMOLITION
LOCKER ROOM SOUND SYSTEM WALL MOUNT RACK. MOUNT RACK AS HIGH AS
POSSIBLE. 120V RECEPTACLE AND JUNCTION BOX TO BE MOUNTED BEHIND
RACK, COORDINATE LOCATION WITH ELECTRICAL CONTRACTOR. REFER TO
SPECIFICATION SECTION 27 51 20 AND DETAIL THIS SHEET FOR ADDITIONAL
INFORMATION.
LOCKED DOOM COUNT CVCTEM WALL MOUNT CDEAKED MOUNT CDEAKED AC

- LOCKER ROOM SOUND SYSTEM WALL MOUNT SPEAKER. MOUNT SPEAKER AS HIGH AS POSSIBLE.
- REMOTE SWITCH FOR SOUND SYSTEM. BOTTOM OF SWITCH SHALL BE 44" AFF. COORDINATE ROUGH-IN REQUIREMENTS WITH DIVISION 26.
- BLUETOOTH CONNECTION POINT FOR SOUND SYSTEM. DEVICE SHALL BE WALL MOUNTED AT APPROXIMATELY 44" AFF. COORDINATE ROUGH-IN REQUIREMENTS WITH DIVISION 26.
- PROVIDE 1X4 HDMI SPLITTER AND SCREENBEAM 1100 PLUS OR EQUAL FOR

CONNECT LOCKER ROOM 108 VID'S CAT6A CABLES TO D2.

WIRELESS CONNECTIVITY.

MATTHEW

HIBNER


MATTHEW R. HIBNER

EXPIRATION DATE: 12/31/2025

LICENSE #1416052

CONSTRUCTION DOCUMENTS 12/11/2025

TECHNOLOGY CABLING PLAN

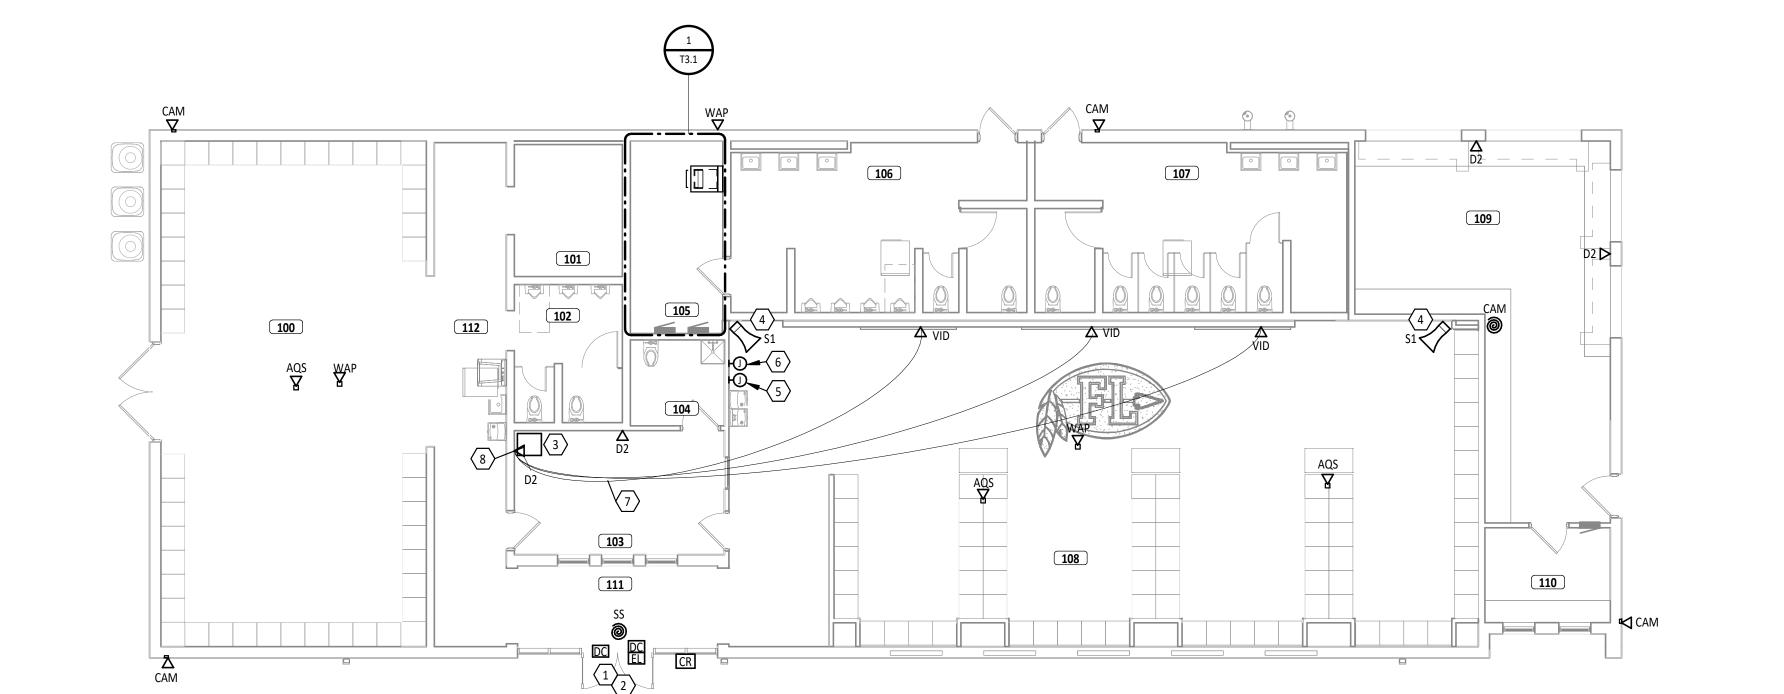

FIRST FLOOR PLAN ROOM INDEX ROOM NUMBER **ROOM NAME** AREA 935 SF 100 LOCKER ROOM 99 SF 100 SF 181 SF 56 SF 105 MECHANICAL 124 SF 327 SF 106 MENS RESTROOM 349 SF 1,631 SF 491 SF 83 SF 107 WOMENS RESTROOM 108 FOOTBALL LOCKER ROOM 109 CONCESSIONS
110 TICKET OFFICE
111 ENTRANCE 124 SF 255 SF 112 CORRIDOR

KEYNOTE LEGEND

1 SFP'S TO BE OWNER PROVIDED AND CONTRACTOR INSTALLED.

KEYNOTE DESCRIPTION

MATTHEW HIBNER 1416052 MATTHEW R. HIBNER LICENSE #1416052 EXPIRATION DATE: 12/31/2025

LOCKER SCHOOLS FORT LORAMIE LOCAL

ISSUANCES/REVISIONS

CONSTRUCTION DOCUMENTS 12/11/2025

PROJECT
NUMBER: DRAWN BY: CHECKED BY: **25041.00** CDT

TECHNOLOGY EQUIPMENT PLAN

> SHEET NUMBER: **TE1.1**