

## CITY OF MIAMISBURG SYCAMORE TRAILS AQUATIC CENTER MIAMISBURG, OHIO



# **ISSUED FOR CONSTRUCTION - JANURARY 17th, 2025**

ADDENDUM #01 - FEBRUARY 3rd, 2025 ADDENDUM #02 - FEBRUARY 12th, 2025



10 South Patterson Blvd. Dayton, OH 45402 Tel: 937.224.4474 CIVIL ENGINEER / LANDSCAPE ARCHITECTURE



6219 Centre Park Drive West Chester, OH 45069 Tel: 513.779.7851 STRUCTURAL ENGINEER



537 East Pete Rose Way, Ste. 400 Cincinnati, OH 45202 Tel: 513.542.3300 MEP ENGINEER





## VICINITY MAP



KEYMAP

### AQUATIC DESIGNER




12851 Manchester Road, Suite 120 St. Louis, MO 63131 Tel: 314.894.1245

## **Counsilman - Hunsaker**


AQUATICS FOR LIFE



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SHEET NUMBER	SHEET NAME	Sheet Issue Date	Current Revision	Current Revision Date	SHEET NUMBER	SHEET NAME	Sheet Issue Date	Current Revision	Current Revision Date
ENERAL -000		01/17/25	2	02/12/25	MECHANICAL M-001		01/17/25		
-002 S-101	SHEET INDEX PROJECT CODE SUMMARY & LIFE SAFETY	01/17/25 01/17/25	2	02/12/25	MD-101 M-101	MECHANICAL FLOOR PLANS - DEMOLITION MECHANICAL FLOOR PLANS	01/17/25 01/17/25		
	PLANS				M-501 M-601	MECHANICAL DETAILS & SCHEDULES MECHANICAL SCHEDULES	01/17/25 01/17/25	1	01/31/25
IVIL 100	GENERAL NOTES & DETAILS	01/17/25			ELECTRICAL				
:101 :102	DETAILS CITY OF MIAMISBURG STANDARD NOTES	01/17/25 01/17/25			E-001 E-002	LEGEND AND INDEX LEGEND AND GENERAL NOTES	01/17/25 01/17/25		
110 111	SURVEY BASEMAP SURVEY BASEMAP	01/17/25 01/17/25			ED-101 ED-102	ELECTRICAL SITE PLAN - DEMOLITION	01/17/25 01/17/25		
;120 ;121	DEMOLITION PLAN DEMOLITION PLAN	01/17/25			ED-103 E-101	ELECTRICAL FLOOR PLANS - DEMOLITION ELECTRICAL SITE PLAN - PARKING	01/17/25		
130	LOCATION PLAN	01/17/25	1	02/12/25	E-102	ELECTRICAL SITE PLAN - LIGHTING	01/17/25		
;131 ;140	LOCATION PLAN UTILITY PLAN	01/17/25 01/17/25	1	02/12/25 01/31/25	E-103 E-104	ELECTRICAL SITE PLAN - POWER ELECTRICAL SITE PLAN - POOL LIGHTING	01/17/25 01/17/25		
;141 ;142	UTILITY PLAN UTILITY PROFILES	01/17/25 01/17/25			E-105 E-201	ELECTRICAL SITE PLAN - POOL GROUNDING NEW WORK - FLOOR PLAN - LIGHTING	01/17/25 01/17/25	1	01/31/25
C143 C150	UTILITY PROFILES GRADING PLAN	01/17/25 01/17/25			E-301 E-302	NEW WORK FLOOR PLAN - POWER NEW WORK FLOOR PLAN - POOL POWER	01/17/25 01/17/25		
C151 C160	GRADING PLAN EROSION CONTROL NOTES	01/17/25			E-401	ENLARGED CONCESSIONS PLAN	01/17/25		
2161	EROSION CONTROL NOTES & DETAILS	01/17/25			E-501 E-502	ELECTRICAL DETAILS ELECTRICAL DETAILS	01/17/25 01/17/25		
ANDSCAPE	1				E-503 E-601	LIGHTING CONTROLS AND DETAILS MOTOR AND LIGHTING SCHEDULES	01/17/25 01/17/25		
100 101	LAYOUT PLAN LAYOUT ENLARGEMENT PLAN	01/17/25 01/17/25			E-602 E-603	ELECTRICAL PANEL SCHEDULES ELECTRICAL PANEL SCHEDULES	01/17/25 01/17/25		
102 200	JOINTING PLAN LANDSCAPE PLAN	01/17/25 01/17/25			E-701	ELECTRICAL SINGLE LINE	01/17/25		
201 202	LANDSCAPE ENLARGEMENT PLAN LANDSCAPE SCHEDULE AND DETAILS	01/17/25			AQUATICS AQ0.0		01/17/25		1
300	SITE LANDSCAPE DETAILS	01/17/25			AQ1.0	POOL REFERENCE PLAN LAP POOL STRUCTURAL PLAN	01/17/25		
301 302	SITE LANDSCAPE DETAILS SITE LANDSCAPE DETAILS	01/17/25 01/17/25			AQ1.1 AQ1.2	WASING POOL STRCUTURAL PLAN POOL NOTES & TYPICAL DETAILS	01/17/25 01/17/25		
303 304	SITE LANDSCAPE DETAILS SITE LANDSCAPE DETAILS	01/17/25 01/17/25			AQ1.3 AQ1.4	TYPICAL DETAILS POOL STRUCTURAL SECTIONS	01/17/25 01/17/25		
100 101	IRRIGATION PLAN IRRIGATION NOTES & DETAILS	01/17/25 01/17/25			AQ1.5 AQ2.0	POOL STRUCTURAL SECTIONS LAP POOL PLAN	01/17/25 01/17/25		
102	IRRIGATION DETAILS	01/17/25			AQ2.1	LAP POOL SECTIONS	01/17/25		
TRUCTURAL					AQ2.2 AQ2.3	LAP POOL SECTIONS & STAIR PLAN LAP POOL DETAILS	01/17/25 01/17/25		
001 002	GENERAL NOTES GENERAL NOTES, LEGEND & ABBREVIATIONS	01/17/25 01/17/25			AQ2.4 AQ2.5	LAP POOL DETAILS	01/17/25 01/17/25		
003 005	SPECIAL INSPECTIONS SNOW DRIFT LOADING PLANS	01/17/25 01/17/25			AQ3.0 AQ3.1	TEACHING / EXERCISE POOL PLAN & SECTIONS TEACHING / EXERCISE POOL DETAILS	01/17/25 01/17/25		
101 102	FOUNDATION PLAN FOUNDATION PLAN, LOW STEEL, & ROOF	01/17/25			AQ3.2 AQ4.0	TEACHING / EXERCISE POOL DETAILS WADING POOL PLAN & SECTIONS	01/17/25		
103	FRAMING PLAN - PUMP HOUSE ROOF FRAMING PLAN	01/17/25			AQ4.1	WADING POOL DETAILS	01/17/25		
201	TYPICAL FOUNDATION DETAILS & SECTIONS	01/17/25			AQ4.2 AQ5.0	WADING POOL DETAILS LEISURE POOL PLAN	01/17/25 01/17/25		
301	FOUNDATION DETAILS & SECTIONS TYPICAL STEEL FRAMING DETAILS	01/17/25 01/17/25			AQ5.1 AQ5.2	LEISURE POOL SECTIONS LEISURE POOL DETAILS	01/17/25 01/17/25		
311 312	CANOPY FRAMING DETAILS & SECTIONS ROOF FRAMING DETAILS & SECTIONS	01/17/25 01/17/25			AQ5.3 AQ5.4	LEISURE POOL DETAILS LEISURE POOL DETAILS	01/17/25 01/17/25		
313 3400	ROOF FRAMING DETAILS & SECTIONS TYPICAL MASONRY DETAILS & SECTIONS &	01/17/25 01/17/25	1	02/12/25	AQ5.5 AQ5.6	LEISURE POOL DETAILS WATERSLIDE PLAN, ELEVATION & DETAILS	01/17/25		
\$500	SCHEDULES SCHEDULES	01/17/25			AQ6.0	POOL STAKING PLAN	01/17/25		
RCHITECTUR		1			AQ7.0 AQ7.1	POOL PIPING NOTES & SCHEDULES POOL SUCTION PIPING PLAN	01/17/25 01/17/25		
D-101	DEMOLITION - FLOOR PLANS	01/17/25			AQ7.2 AQ7.3	POOL RETURN PIPING PLAN POOL FEATURE RETURN PIPING PLAN	01/17/25 01/17/25		
ND-102 ND-103	DEMOLITION - ROOF PLANS DEMOLITION - CEILING PLANS	01/17/25 01/17/25			AQ8.0 AQ8.1	POOL MECHANICAL NOTES & SCHEDULES POOL MECHANICAL ROOM PLANS	01/17/25 01/17/25		
ND-201 ND-202	DEMOLITION - EXTERIOR ELEVATIONS DEMOLITION - EXTERIOR ELEVATIONS	01/17/25 01/17/25			AQ8.2 AQ8.3	POOL MECHANICAL ROOM SECTIONS POOL MECHANICAL PIPING ISOMETRICS	01/17/25 01/17/25		
A-002 A-101	PARTITION TYPES NEW WORK - FLOOR PLANS	01/17/25 01/17/25			AQ8.4	LAP POOL SURGE TANK PLAN & SECTIONS TEACHING / EXERCISE POOL SURGE TANK	01/17/25		
A-121 A-131	REFLECTED CEILING PLANS - NEW WORK ROOF PLANS - NEW WORK	01/17/25 01/17/25			AQ8.5	PLAN & SECTIONS	01/17/25		
A-201 A-202	EXTERIOR ELEVATIONS	01/17/25	1	01/31/25	AQ8.6 AQ8.7	WADING POOL SURGE TANK PLAN & SECTIONS LEISURE POOL SURGE TANK PLAN & SECTIONS	01/17/25 01/17/25		
-301	EXTERIOR ELEVATIONS BUILDING SECTIONS	01/17/25 01/17/25			AQ8.8	SPRAYGROUND BALANCE TANK PLAN & SECTIONS	01/17/25		
-302 -310	BUILDING SECTIONS WALL SECTIONS	01/17/25 01/17/25			AQ8.9 AQ8.10	POOL MECHANICAL DETAILS POOL MECHANICAL DETAILS	01/17/25 01/17/25		
-311 -400	WALL SECTIONS ENLARGED RESTROOM DETAILS AND	01/17/25 01/17/25	2	02/12/25	AQ8.11 AQ8.12	POOL MECHANICAL DETAILS POOL MECHANICAL DETAILS	01/17/25 01/17/25		
-401	EQUIPMENT LEGEND ENLARGED PLANS	01/17/25			AQ8.13	POOL MECHANICAL DETAILS	01/17/25		
-402 -403	ENLARGED PLANS ENLARGED PLANS	01/17/25			AQ8.14 AQ9.0	POOL MECHANICAL DETAILS LAP POOL SYSTEMS SCHEMATIC	01/17/25 01/17/25		
-404	ENLARGED PLANS	01/17/25			AQ9.1	TEACHING / EXERCISE POOL SYSTEMS SCHEMATIC	01/17/25		
-405 -420	ENLARGED PLANS INTERIOR ELEVATIONS	01/17/25 01/17/25	1	01/31/25 01/31/25	AQ9.2 AQ9.3	WADING POOL SYSTEMS SCHEMATIC LEISURE POOL SYSTEMS SCHEMATIC	01/17/25 01/17/25		
-421 -422	INTERIOR ELEVATIONS INTERIOR ELEVATIONS	01/17/25 01/17/25	1	01/31/25 01/31/25	AQ9.4	SPRAYGROUND SYSTEMS SCHEMATIC	01/17/25	_	
-423 -520	INTERIOR ELEVATIONS ROOF DETAILS	01/17/25	1	01/31/25	PRESENTATIC	DN 3D AXON IMAGES	01/17/25		
-521	ROOF DETAILS	01/17/25			PT102	3D AXON IMAGES	01/17/25		
-530 -534	SECTION DETAILS MISC. DETAILS	01/17/25 01/17/25			PT103	FINISH ELEVATIONS & ISOMETRICS	01/17/25		
-535 -540	MISC. DETAILS CASEWORK SECTIONS AND DETAILS	01/17/25 01/17/25	1	01/31/25					
-541 -601	CASEWORK SECTIONS AND DETAILS DOOR SCHEDULE, FRAMES, TYPES, AND	01/17/25 01/17/25	1	01/31/25					
-602	HARDWARE DOOR & WINDOW DETAILS	01/17/25							
-610 -611	WINDOW ELEVATIONS WINDOW ELEVATIONS	01/17/25							
-900	FINISH SCHEDULE AND LEGEND	01/17/25	1	01/31/25					
901	OVERALL FINISH PLAN	01/17/25	1	01/31/25					
LUMBING -001	LEGENDS AND SCHEDULES	01/17/25							
-300 -701	MAIN PUMP HOUSE FOUNDATION PLAN SANITARY DIAGRAMS	01/17/25							
-101	PLUMBING SITE UTILITY PLAN PLUMBING NEW WORK FLOOR PLANS	01/17/25	1	01/21/05					
-201 -301	PLUMBING NEW WORK FLOOR PLANS	01/17/25 01/17/25	1	01/31/25					
-401	ENLARGED CONCESSIONS PLANS DETAILS AND NOTES	01/17/25							
-501				· · ·					

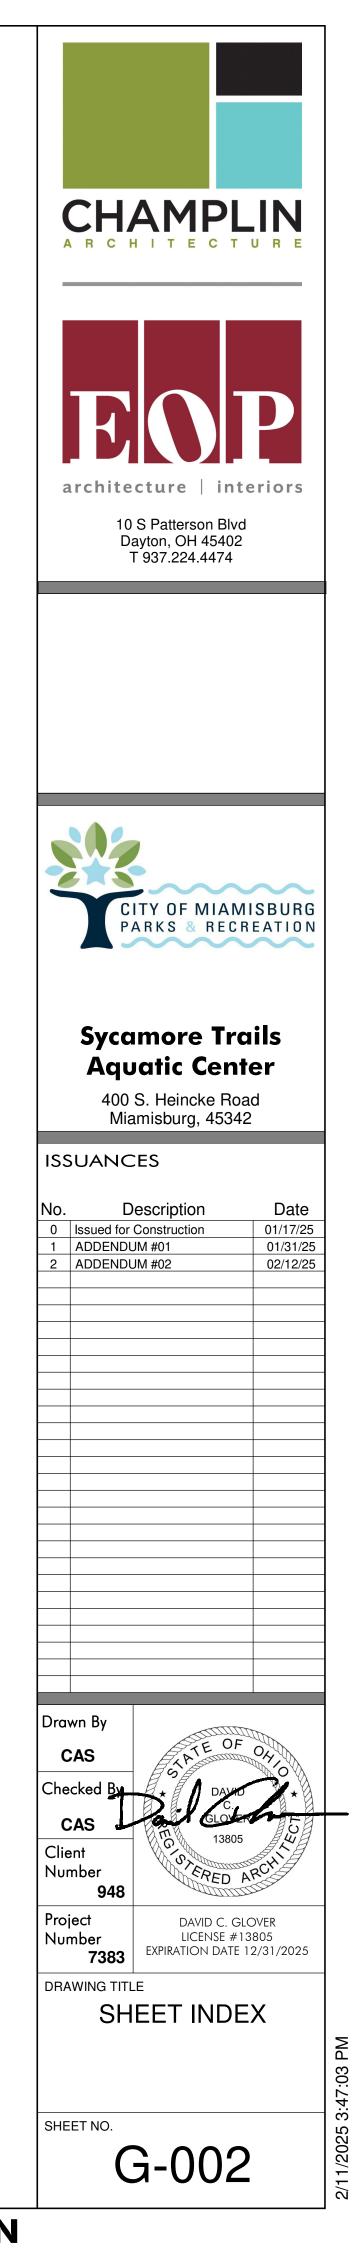

## **ISSUED FOR CONSTRUCTION**

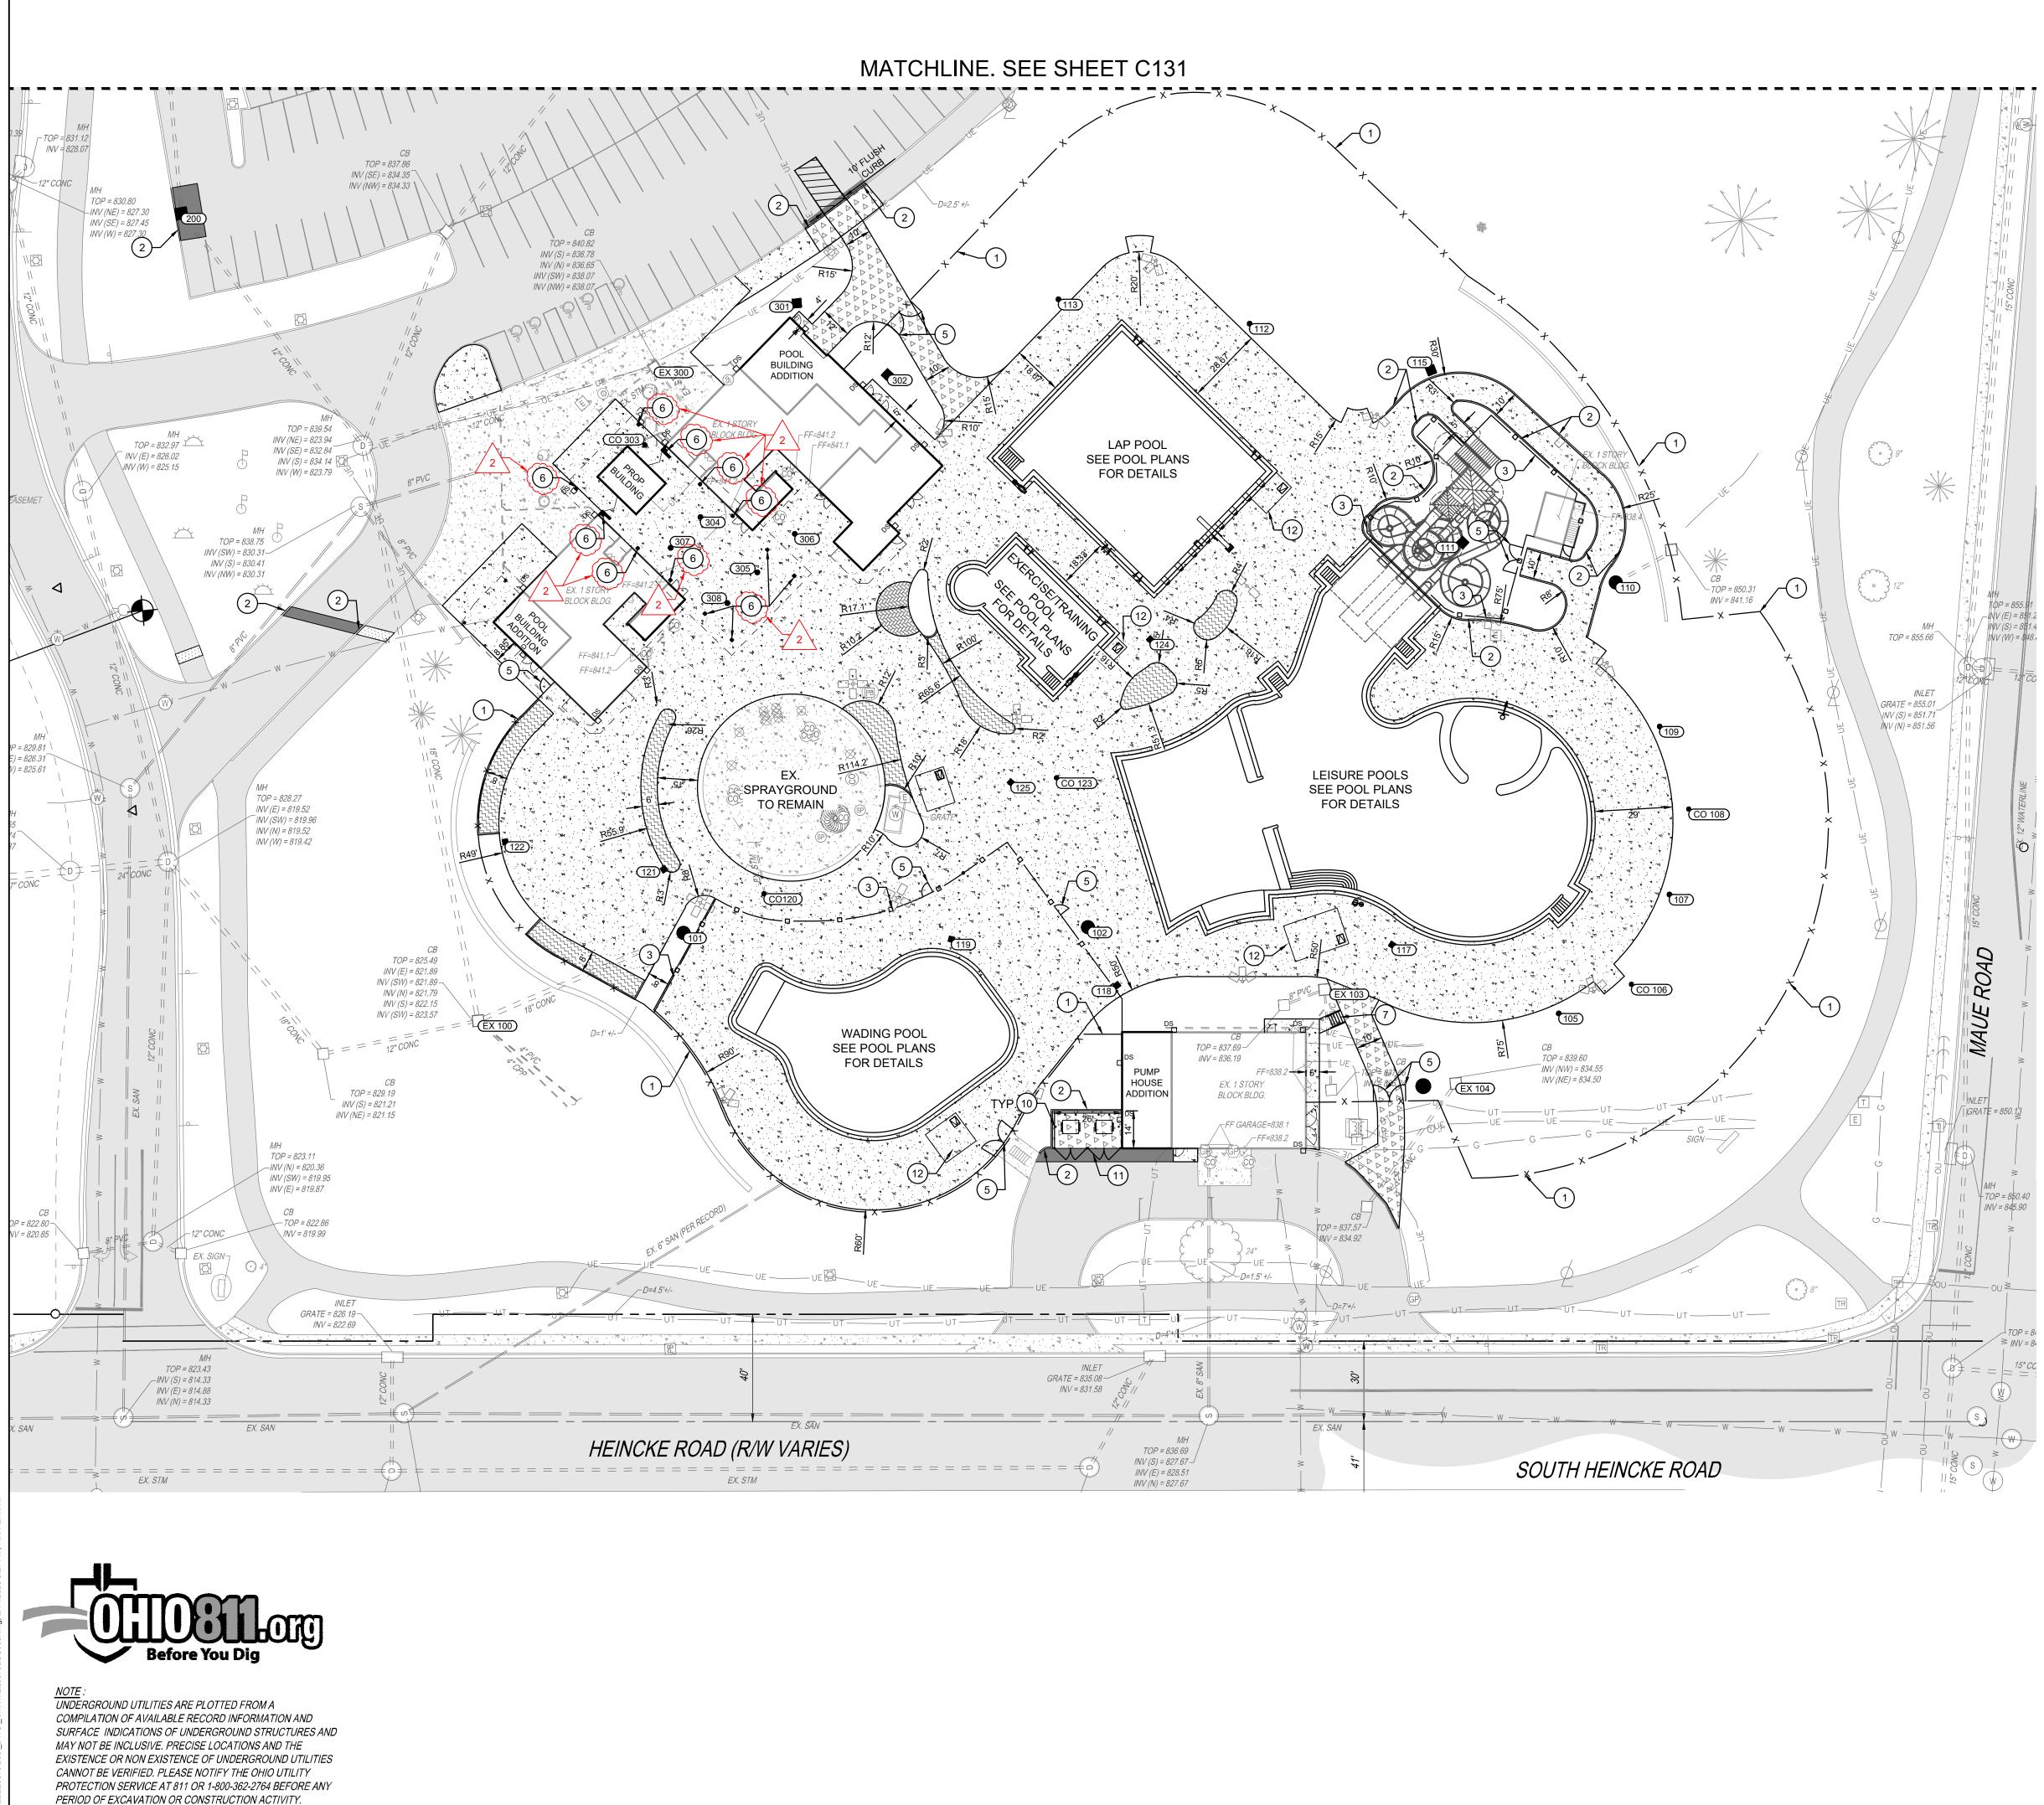


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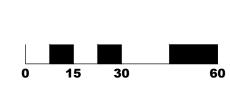
_		
<u>'R(</u>	<u>JPOSI</u> _(100)	ED LEGEND
		CATCH BASIN
	( <u>100</u> )	CURB INLET
	( <u>100</u> )	YARD DRAIN
	(100)	MANHOLE
	o <sup>co</sup>	STORM SEWER CLEANOUT
		DOWNSPOUT
		LIGHT POLE. SEE ELECTRIC PLANS FOR DETAILS.
		STANDARD DUTY ASPHALT PAVEMENT PER DETAIL 1/C100
• • • •		LIGHT DUTY ASPHALT PAVEMENT PER DETAIL 2/C100
	$\bigtriangledown$	HEAVY DUTY CONCRETE PAVEMENT PER DETAIL 3/C100
	4 4 4	CONCRETE WALK PER DETAIL 6/C100
		UNIT PAVERS. SEE LANDSCAPE PLANS FOR DETAILS.
		SYNTHETIC TURF. SEE LANDSCAPE PLANS FOR DETAILS.
00		N PLAN KEY NOTES
1)	8' TALL	VINYL COATED CHAIN LINK FENCE. SEE LANDSCAPI FOR DETAILS.
2)	BARRIE	R CURB PER DETAIL 4/C100
3	4' TALL DETAILS	ALUMINUM FENCE. SEE LANDSCAPE PLANS FOR S.
4)	6' LONG	G, 1' WIDE PIANO-KEY STRIPED CROSSWALK, 3' O.C.
5	GATE. S	SEE LANDSCAPE PLANS FOR DETAILS.
6)	COLUM	N. REFER TO ARCHITECTURAL PLANS.
$\overline{\mathcal{O}}$	STAIRS	AND HANDRAIL PER DETAIL 10/C100

- 8 TIE PROPOSED WALKING PATH TO EXISTING BRICK PAVERS
- (9) ACCESSIBLE PARKING SIGN PER DETAIL 5/C100
- 10 PIPE BOLLARD PER DETAIL 13/C100
- DUMPSTER ENCLOSURE. SEE LANDSCAPE PLANS FOR DETAILS.
- (12) SURGE TANK. REFER TO POOL PLANS.
- (13) CONCRETE WHEEL STOP PER DETAIL 1/C101
- (14) CURB RAMP- PERPENDICULAR WITH FLARED SIDES PER DETAIL 3/C101
- (15) CURB RAMP DOUBLE SIDED PARALLEL PER DETAIL 2/C100

#### LOCATION PLAN GENERAL NOTES


- A. ALL DIMENSIONS ARE TO THE EDGE OF PAVEMENT AND/OR
- BACK OF CURB UNLESS OTHERWISE NOTEDB. ALL STANDARD PARKING SPACES ARE TO BE 9.5X18 UNLESS OTHERWISE NOTED
- C. PARKING LOT STRIPING SHALL BE 4" WIDE HIGHWAY-TYPE APPLIED IN ACCORDANCE WITH THE PLAND. ALL RADII TO BE 5' UNLESS OTHERWISE NOTED



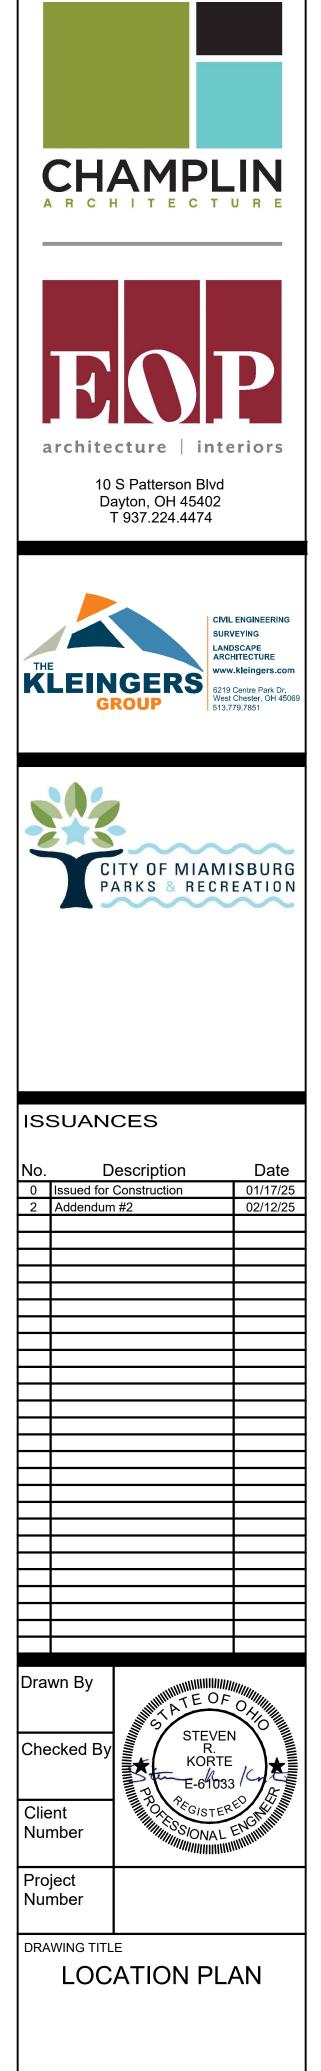



SHEET NO.

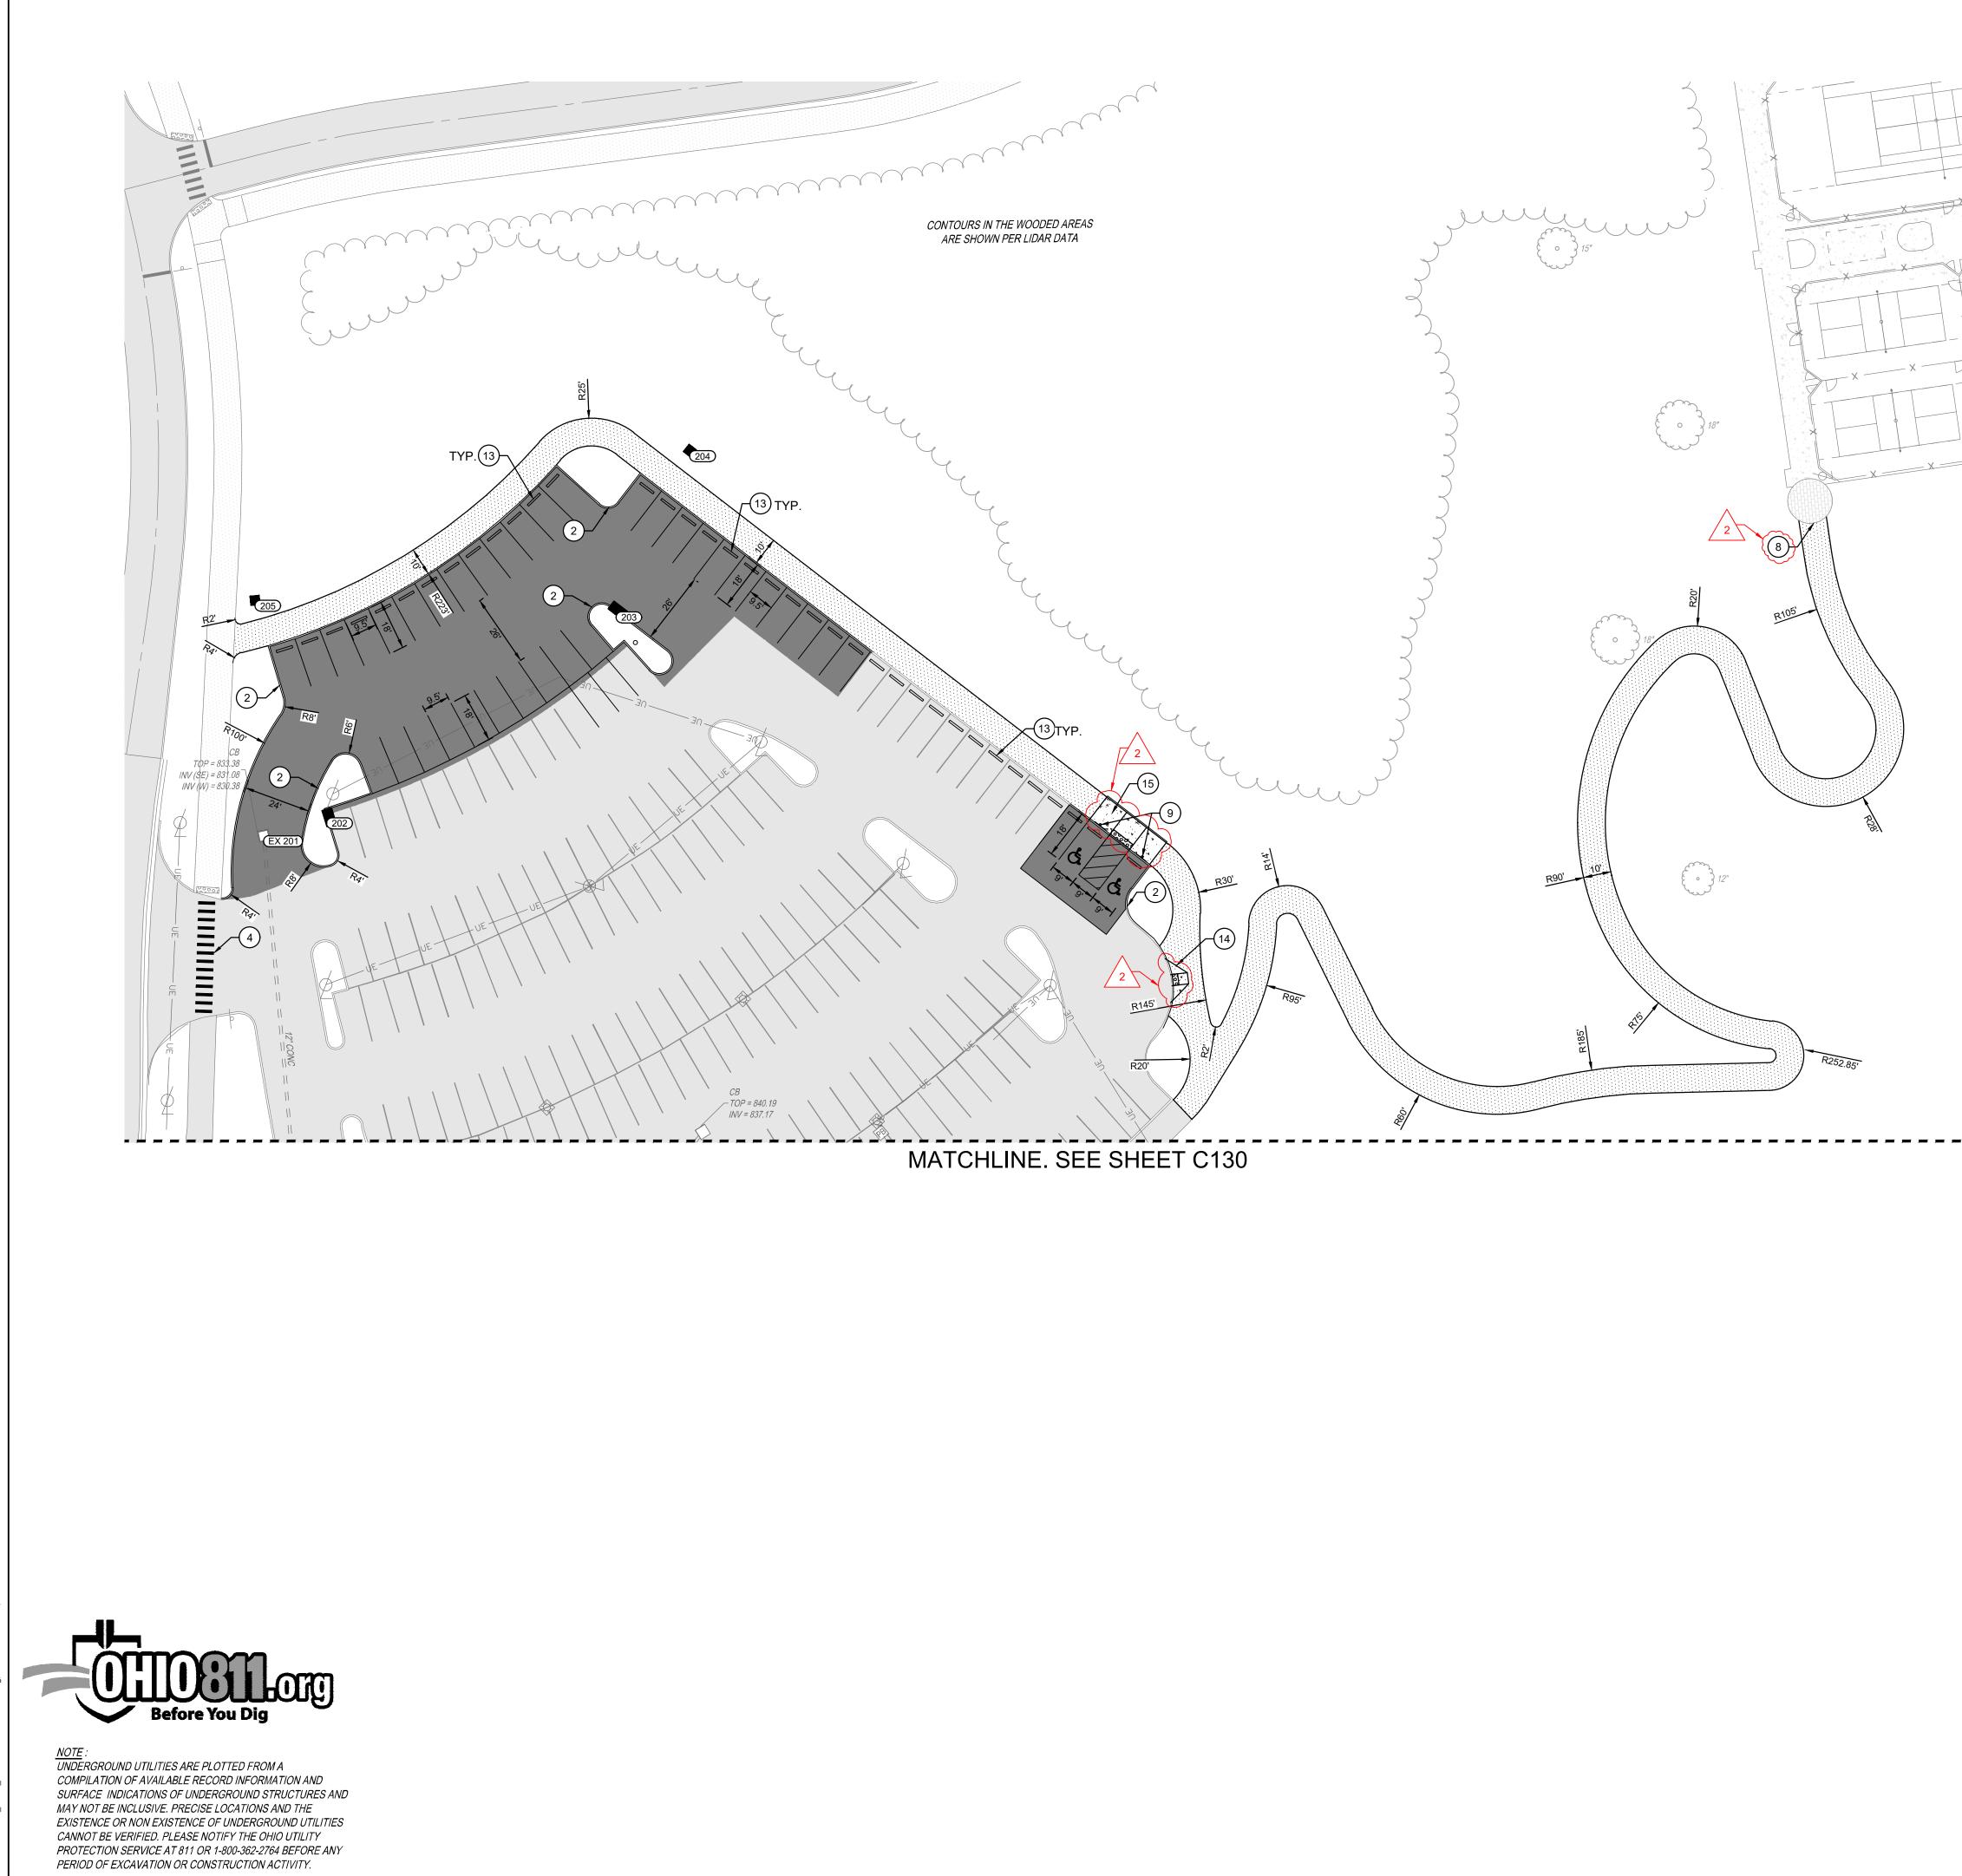

2/220070/008\ DWG\ Sheets\220070LOC008.dwg, 2/11/2025 8:27 AM, Katie Emme

#### PROPOSED LEGEND

(100)	CATCH BASIN
(100)	CURB INLET
(100)	YARD DRAIN
(100)	MANHOLE
o <sup>co</sup>	STORM SEWER CLEANOUT
	DOWNSPOUT
	LIGHT POLE. SEE ELECTRIC PLANS FOR DETAILS.
	STANDARD DUTY ASPHALT PAVEMENT PER DETAIL 1/C100
	LIGHT DUTY ASPHALT PAVEMENT PER DETAIL 2/C100
$\begin{array}{c} & & \\$	HEAVY DUTY CONCRETE PAVEMENT PER DETAIL 3/C100
	CONCRETE WALK PER DETAIL 6/C100

## SYNTHETIC TURF. SEE LANDSCAPE PLANS FOR DETAILS.


8' TALL VINYL COATED CHAIN LINK FENCE. SEE LANDSCAPE PLANS FOR DETAILS.


UNIT PAVERS. SEE LANDSCAPE PLANS FOR DETAILS.

- 2 BARRIER CURB PER DETAIL 4/C100
- 3 4' TALL ALUMINUM FENCE. SEE LANDSCAPE PLANS FOR DETAILS.
- (4) 6' LONG, 1' WIDE PIANO-KEY STRIPED CROSSWALK, 3' O.C.
- 5 GATE. SEE LANDSCAPE PLANS FOR DETAILS.
- 6 COLUMN. REFER TO ARCHITECTURAL PLANS.
- 7 STAIRS AND HANDRAIL PER DETAIL 10/C100
- 8 TIE PROPOSED WALKING PATH TO EXISTING BRICK PAVERS
- 9 ACCESSIBLE PARKING SIGN PER DETAIL 5/C100
- 10 PIPE BOLLARD PER DETAIL 13/C100
- DUMPSTER ENCLOSURE. SEE LANDSCAPE PLANS FOR DETAILS.
- (12) SURGE TANK. REFER TO POOL PLANS.
- (13) CONCRETE WHEEL STOP PER DETAIL 1/C101
- (14) CURB RAMP- PERPENDICULAR WITH FLARED SIDES PER DETAIL 3/C101
- (15) CURB RAMP DOUBLE SIDED PARALLEL PER DETAIL 2/C100

#### LOCATION PLAN GENERAL NOTES

- A. ALL DIMENSIONS ARE TO THE EDGE OF PAVEMENT AND/OR
- BACK OF CURB UNLESS OTHERWISE NOTEDB. ALL STANDARD PARKING SPACES ARE TO BE 9.5X18 UNLESS OTHERWISE NOTED
- C. PARKING LOT STRIPING SHALL BE 4" WIDE HIGHWAY-TYPE APPLIED IN ACCORDANCE WITH THE PLAN
- D. ALL RADII TO BE 5' UNLESS OTHERWISE NOTED

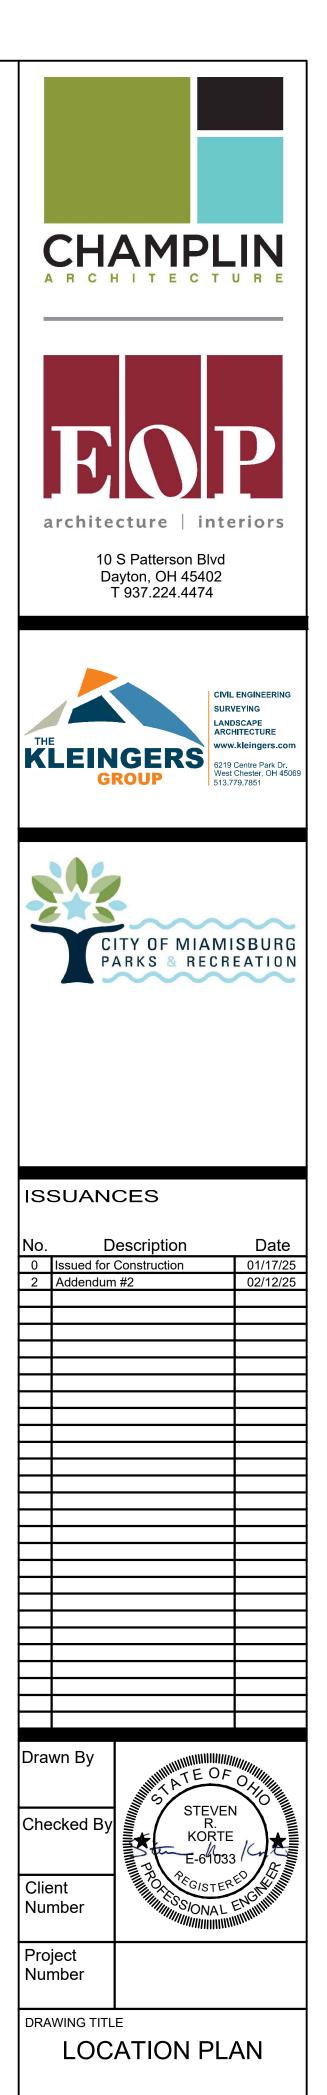


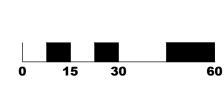




SHEET NO.

C131

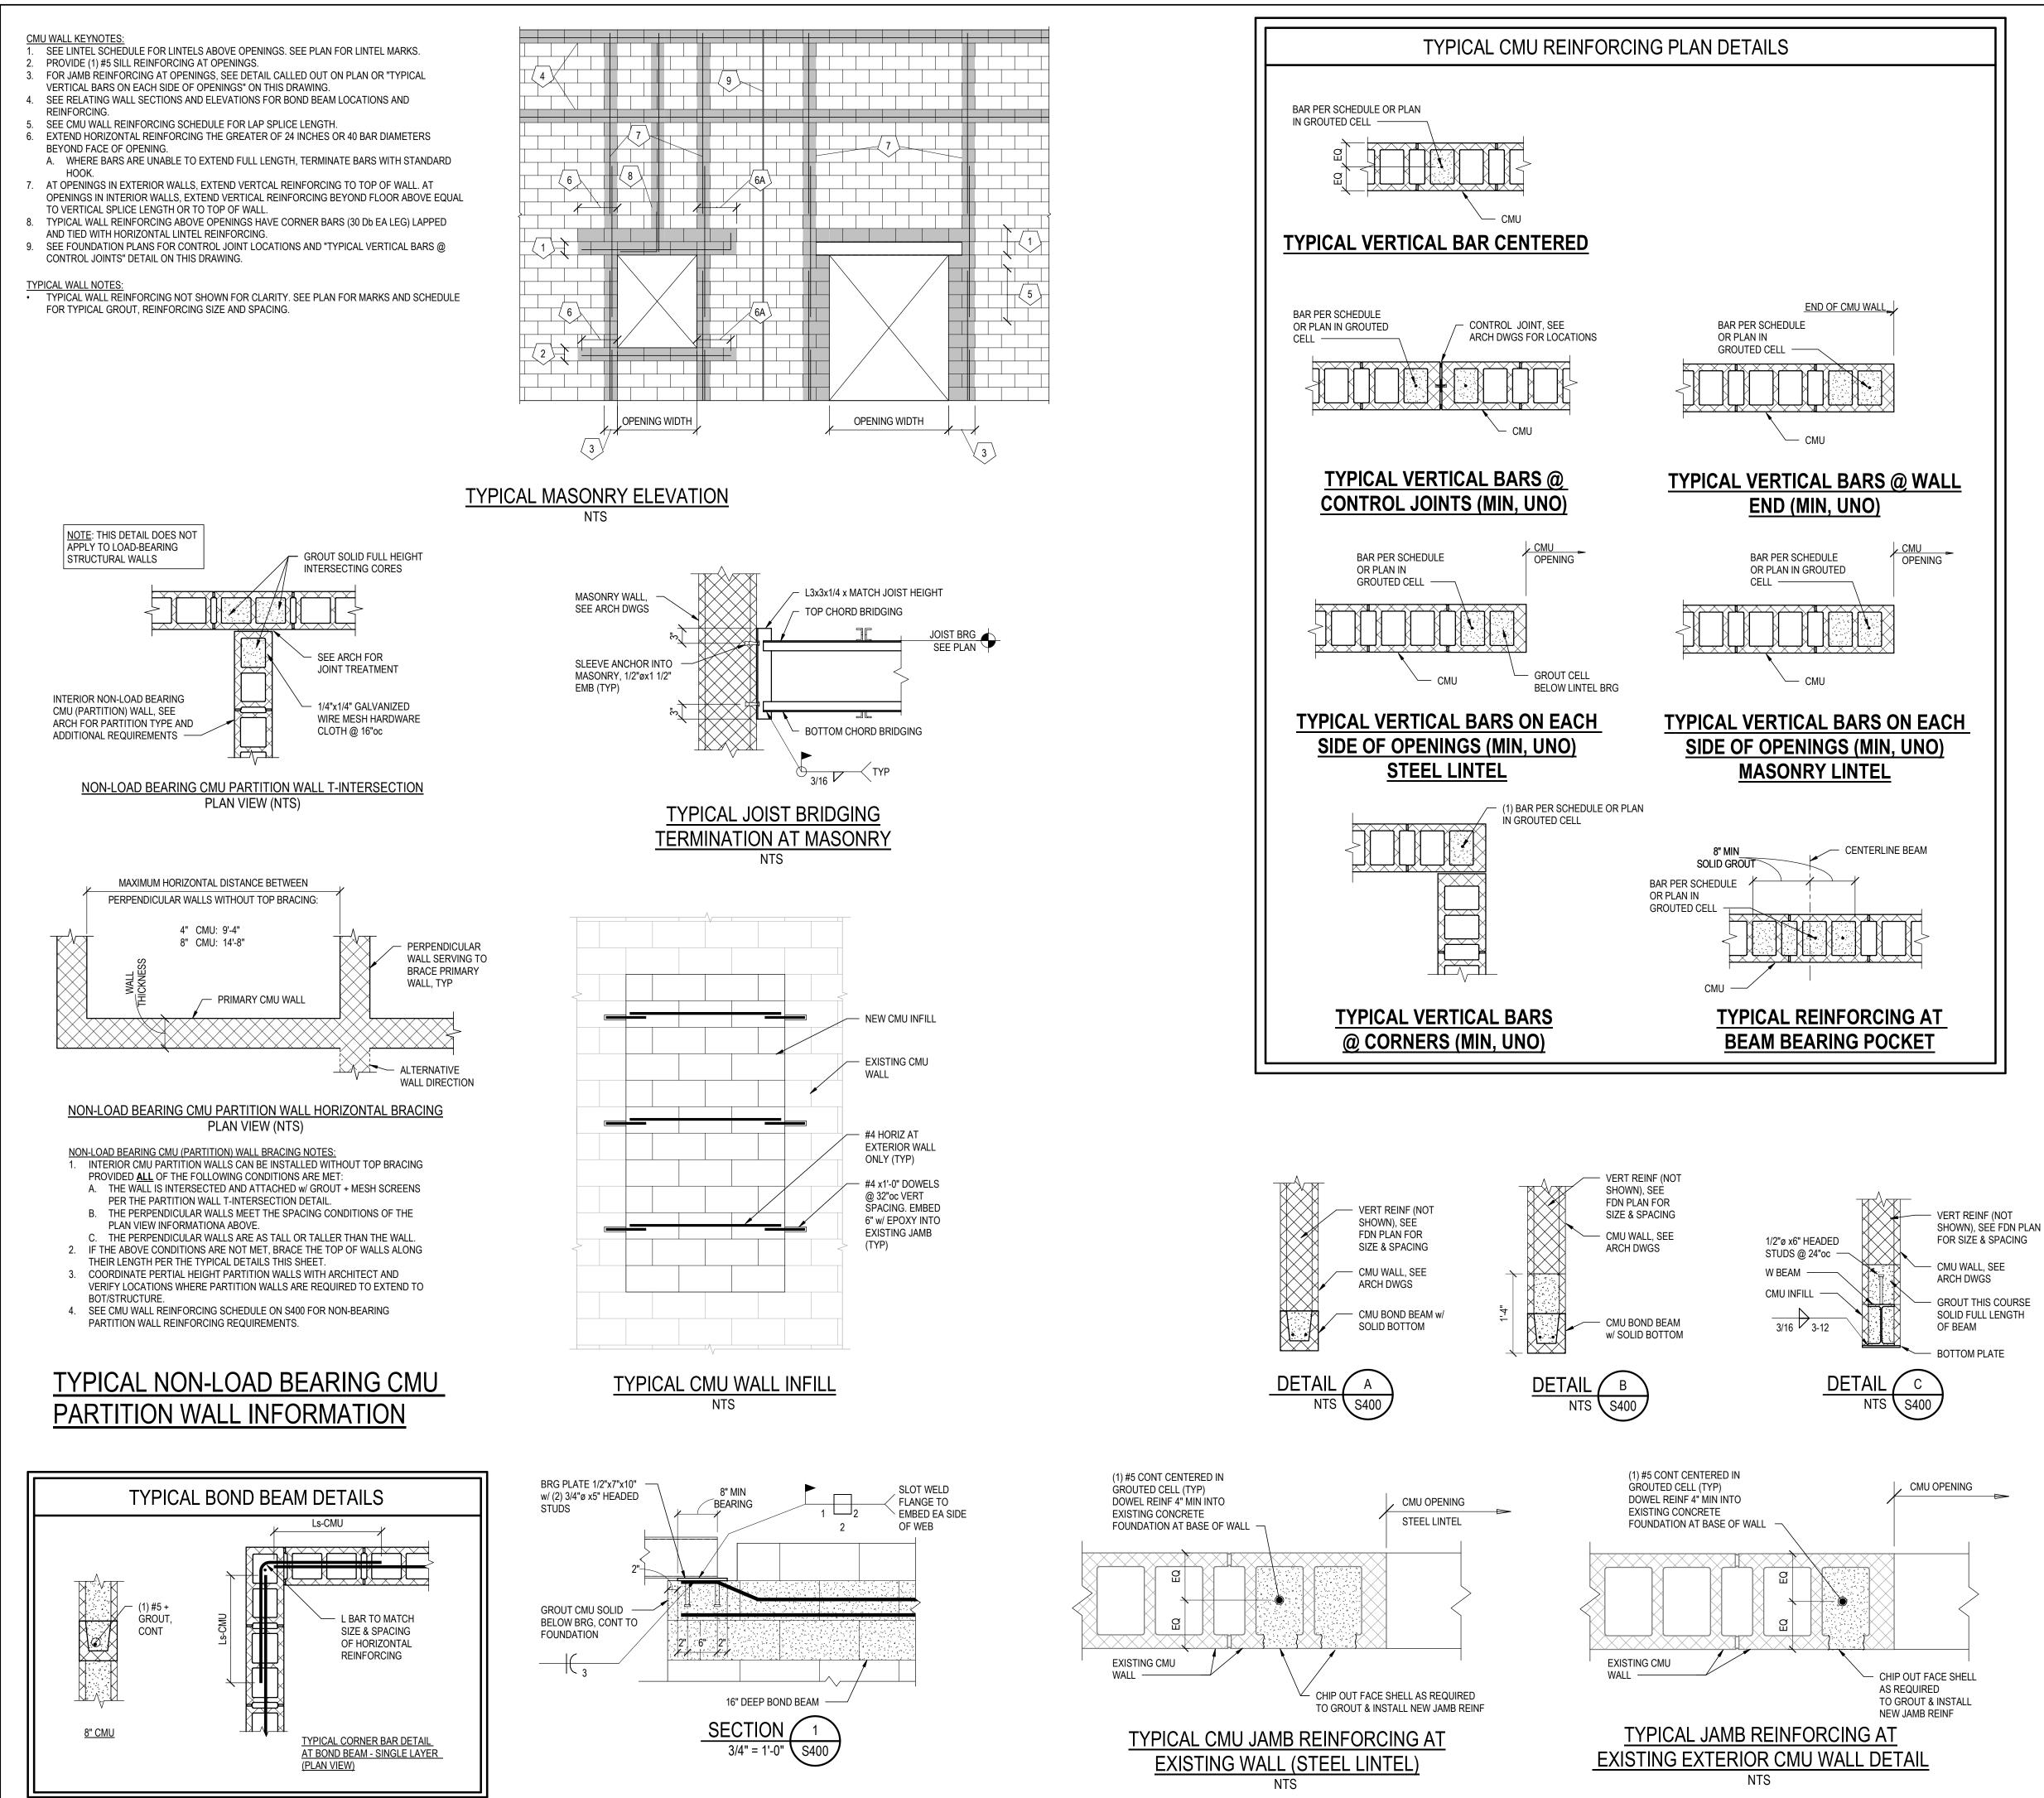

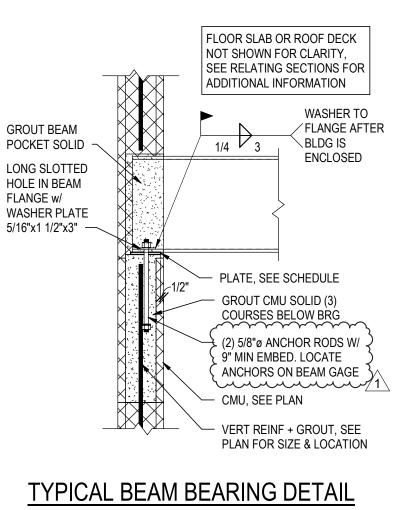

NTS

BEAM BE	ARING PLATE SCHEDU	LE
BEAM SIZE	PLATE DIMENSIONS (t x N x B)	NOTES
W8, W10, W12, W14, W16	PL3/8x5-1/2x0'-8"	AT 8" CMU

Wx	CM	U WALL REINFOR	CING SCHI	EDULE	
MARK	CMU SIZE	TYPICAL VERTICAL REINFORCING	DETAIL	SPLICE LENGTH	SPLICE f'm
W1	8	(1) #5 @48"oc	1/S251	20"	2000PSI
W2	8	(1) #5 @16"oc	1/S251	20"	2000PSI

NOTES: 1. "Wn" - INDICATES VERTICAL WALL REINFORCING.

2. SOLID GROUT ALL CELLS CONTAINING REINFORCING. 3. REINFORCING TO BE PLACED IN CENTER OF GROUTED CELL UNLESS NOTED

OTHERWISE. 4. EXTEND REINFORCING FROM PLAN LEVEL SHOWN DOWN TO LEVEL BELOW AND LAP PER SCHEDULE IN MASONRY SECTION OF GENERAL STRUCTURAL NOTES. EXTEND DOWEL OR BENT BAR OUT OF CONCRETE WALL OR FOOTING TO PROVIDE LAP WITH EACH CMU VERTICAL REINFORCING BAR.

5. ALL WALLS NOT NOTED WITH "Wn" ON PLAN, USE WALL REINFORCEMENT MARK W2.


•	BOTTOM PLATE

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NTS	S4	00	7

Ln		CMU LINTEL SCHEDULE	
MARK	DETAIL	DESCRIPTION	REMARKS
L1	A/S251	8" TALL BOND BEAM w/ (2) #5 BOTTOM	
L2	B/S251	16" TALL BOND BEAM w/ (2) #5 BOTTOM	
L3	C/S251	W8x24 w/ BOTTOM PL1/4"x11"xCONT	

NOTES: 1. PROVIDE 8" BEARING EACH END OF LINTEL, UNO.

2. CENTER LINTEL UNDER CMU, UNO IN PLAN OR SECTION.

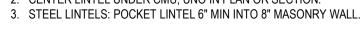





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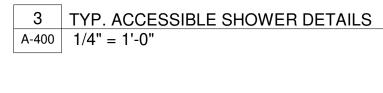
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	Drawn By WCM Checked By QCB	CHRISTOP AMES BUCKREL 82481		
	WCM Checked By QCB Client Number Project Number 2412.31 DRAWING TITL	E	2/11/2025	
2	WCM Checked By QCB Client Number 2412.31 DRAWING TITL TYPIC DETAIL & S SHEET NO.	BUCKREL 82481 82 82 82 82 82 82 82 82 82 82 82 82 82	NRY IONS	2/11/2025 5:29:38 PM





RECESSED SOAP / SHAMPOO SHELF

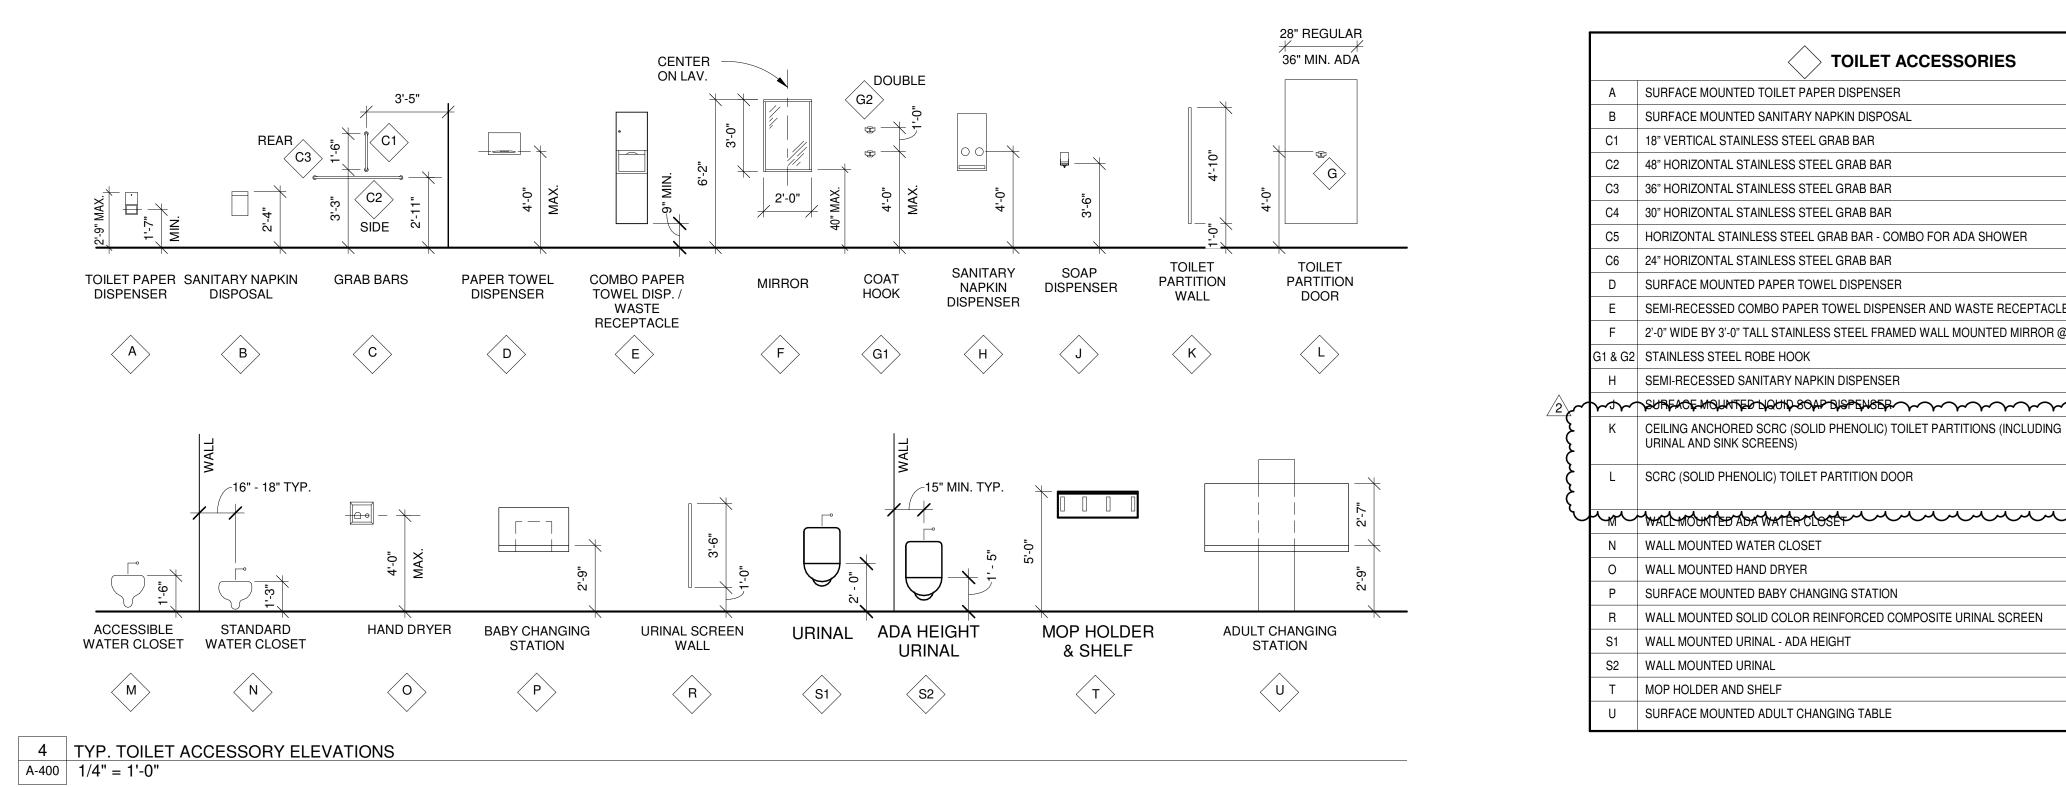


SOLID SURFACE SHOWER PAN, TYP.

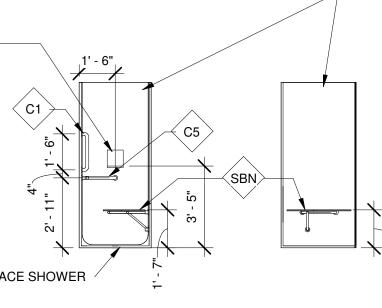

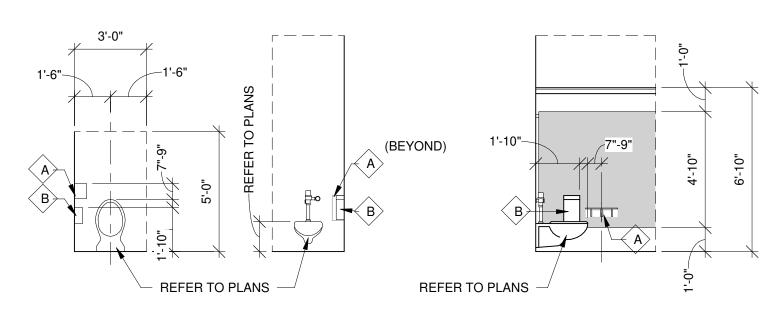

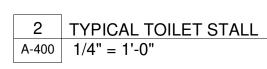


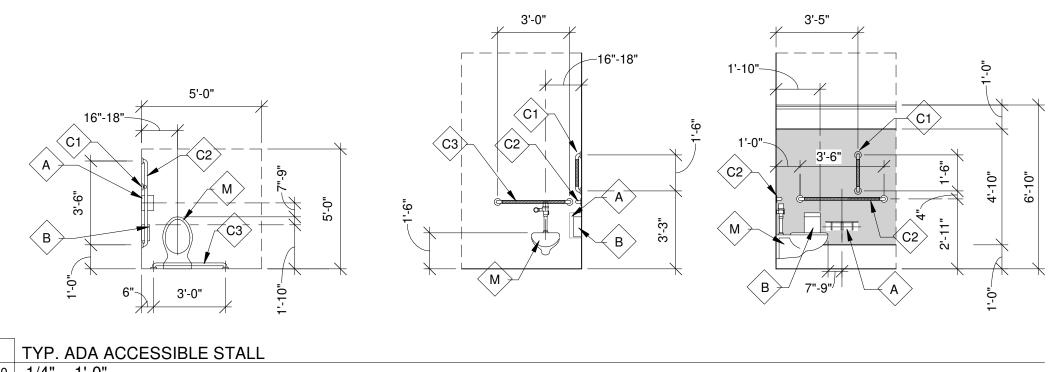

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 TYP. ADA ACCESSIBLE STALL

 A-400
 1/4" = 1'-0"

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4
SANIFLOW MACHFLOW M09ACS-UL
<u>}</u>
SANIFLOW BABYMEDI CP0016HCS-ASTN

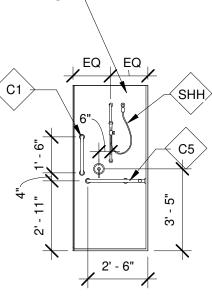

BACK WALL

<u>SEAT WALL</u>

CONTROL WALL



