

# Harrison Township District 10 Sheriff Substation Renovation

6001 N Dixie Dr, Dayton, OH 45414

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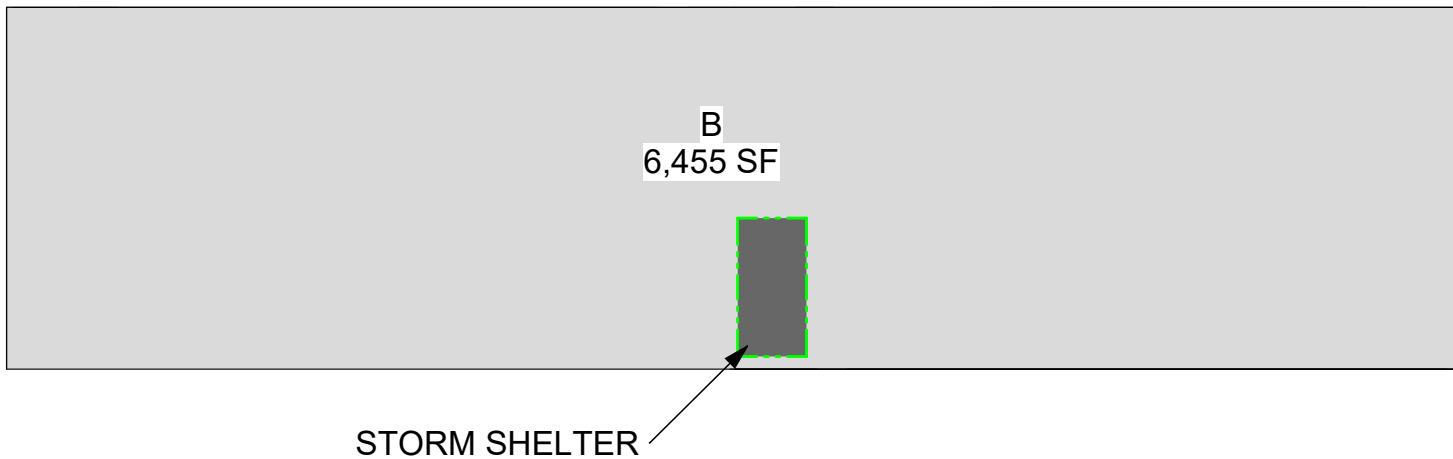
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D4 USE GROUP PLAN  
3/64" = 1'-0"



## VICINITY MAP



## CODE INFORMATION

(OEBC 2024)

### 2024 OHIO EXISTING BUILDING CODE (OEBC)

#### COMPLIANCE METHOD

2024 OHIO EXISTING BUILDING CODE (OEBC)  
SECTION 301.3.1 PRESCRIPTIVE COMPLIANCE METHOD  
COMPLIANCE WITH OEBC SECTIONS 302.309 AND CHAPTER 5.  
ALTERATIONS TO COMPLY WITH REQUIREMENTS OF THE CODE FOR NEW  
CONSTRUCTION (OBC 2024).

### 2024 OHIO BUILDING CODE (OBC)

#### PROJECT DESCRIPTION

PROJECT CONSISTS OF A RENOVATION OF AN EXISTING OFFICE BUILDING INTO  
A FUNCTIONAL SHERIFF SUBSTATION FOR HARRISON TOWNSHIP.

#### USE GROUP CLASSIFICATION

OBC (302) USE GROUP = B BUSINESS - SHERIFF SUBSTATION

#### CONSTRUCTION TYPE CLASSIFICATION

OBC (602) CONSTRUCTION TYPE = V B

#### HEIGHT AND AREA LIMITATIONS

BUILDING DESCRIPTION: B 2 STORIES/9,000 SF STORY ALLOWABLE

ACTUAL HEIGHT AND FLOOR AREA: 1 STORY/6,455 SF (NO CHANGE)

#### FIRE PROTECTION

BUILDING DESCRIPTION : NON-SPRINKLERED

#### STORM SHELTER PROVISIONS

REFER TO SHEET G0.3 FOR STORM SHELTER INFORMATION.

#### PLUMBING FIXTURES REQUIRED

REQUIRED:	WC	LAV.	SHOWER	DF	SERVICE SINK
PROPOSED*	5	9	2	0*	1

\*Drinking fountains shall not be required for an occupant load of 15 or fewer.  
When water dispensers are provided, drinking fountains shall not be required.


#### ACCESSIBILITY STANDARD

EXISTING BUILDINGS: OBC 2024, CHAPTER 11, ACCESSIBILITY AND ICC A117.1-2009

#### OCCUPANT LOAD

OBC (1004) ALLOWABLE B = 6,440 SF/150 = 43 OCCUPANTS ALLOWABLE  
15 OCCUPANTS DECLARED

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#### ISSUE

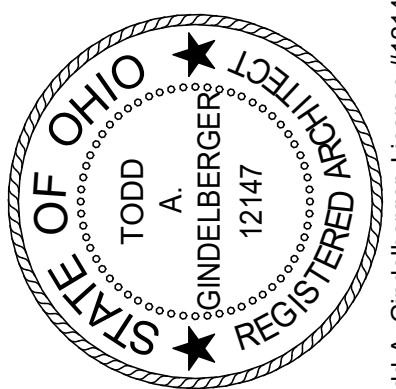NO.	DATE	DESCRIPTION
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01/22/2026 FOR CONSTRUCTION

DATE 01/22/2026

JOB NO. 4325.00

DRAWN SEP

CHECKED RFW

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TITLE  
COVER SHEET

SHEET NO.

G0.1



\*BOUNDARY DATA BASED ON GIS INFORMATION FROM MONTGOMERY COUNTY AUDITOR OFFICE'S PARCEL MAP. FOR SCHEMATIC PURPOSES ONLY. THIS IS NOT A SURVEY

CONSTRUCTION NOTES

- INDICATES CONSTRUCTION NOTE.
- CONCRETE PAD. REFER TO SHEET A5.1 FOR DETAILS.
  - ONCE FOUNDATION IS REPAIRED, REGRADE, PATCH, AND REPAIR PAVING AT THIS CORNER TO DIVERT WATER AWAY FROM BUILDING.
  - CONCRETE PAD AND STEPS TO BE COORDINATED WITH OWNER. REFER TO SHEET A5.1 FOR DETAILS.

GENERAL NOTES

- A. ARCHITECTURAL SITE PLAN IS PROVIDED FOR REFERENCE ONLY.
- B. HARRISON TOWNSHIP OWNS BOTH THE PARCEL WHICH THE PROPOSED SHERIFF STATION IS LOCATED, THE PARCEL WHERE THE EXISTING GOVERNMENT CENTER IS LOCATED.
- C. HARRISON TOWNSHIP ZONING AND STREET DEPARTMENT IS ADDRESSING ZONING ITEMS AND PARKING DISTRIBUTION BETWEEN THE TWO PARCELS. G.C. SHALL INCLUDE PATCHING AND REPAIR OF AREAS DISTRIBUTED BY CONSTRUCTION AND SAL AND RESTRIPE THE 6001 NORTH DIXIE DRIVE PARCEL.

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STATE OF OHIO  
TODD A. GINDEBERGER  
REGISTERED ARCHITECT  
#12147  
Expiration Date 12/31/2027

Harrison Township District 10  
Sheriff Substation Renovation

6001 N Dixie Dr, Dayton, OH 45414

ISSUE		
NO.	DATE	DESCRIPTION
01/22/2026 FOR CONSTRUCTION		

DATE	01/22/2026
JOB NO.	4325.00
DRAWN	SEP
CHECKED	RFW

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TITLE  
ARCHITECTURAL SITE  
PLAN

SHEET NO.  
**G0.2**

1/21/2026 9:55:09 AM

F1 SITE PLAN STUDY  
1/16" = 1'-0"



## STORM SHELTER INFORMATION

GOVERNING CODES:

- OBC 2024, SECTION 423 STORM SHELTERS
- ICC 500 2020

THIS SHELTER IS CLASSIFIED AS A COMMUNITY TORNADO SHELTER. THE SHELTER IS LOCATED ON THE MAIN FLOOR LEVEL OF THE SHERIFF STATION.

THE SHELTER IS DESIGNED TO ACCOMMODATE 15 OCCUPANTS OF THE SHERIFF STATION.

### ICC 500, 2020 CHAPTER 1: APPLICATION AND ADMINISTRATION

DESIGN INFORMATION PER 106.2.1 IS LOCATED OR REFERENCED ON THIS SHEET.

- ITEM 2: USE OF COMMUNITY STORM SHELTER IS BY BUILDING OCCUPANTS ONLY.
- ITEM 9: DESIGN WIND PRESSURES ARE INCLUDED IN STRUCTURAL STORM SHELTER CALCULATIONS SECTION 1; DESIGN LOADS FOR BASIC DESIGN WIND LOAD AND SECTION 6 & 7 FOR COMPONENTS AND CLADDING WIND LOAD DESIGNS. FOUNDATION CAPACITY REQUIREMENTS AND REINFORCEMENT ARE INCLUDED ON STRUCTURAL SHEET S4.2 STRUCTURAL SECTIONS.
- ITEM 21: POST INSTALLED ANCHORS ARE USED FOR THE INSTALLATION OF THE IMPACT RESISTANT DOOR, AND THE WALL OPENING PLATE SHROUDS. REFER TO SHEETS A0.3, A0.6 AND S5.4 FOR ADDITIONAL INFORMATION.

### ICC 500, 2020 CHAPTER 3: STRUCTURAL DESIGN AND TESTING CRITERIA

THE TORNADO SHELTER HAS BEEN DESIGNED PER THE REQUIREMENTS OF ICC 500 - 2020.

- SHELTER DESIGN WIND SPEED,  $V_{ult}$ : 250 mph
- WIND EXPOSURE CATEGORY: C
- INTERNAL PRESSURE COEFFICIENT ( $GCP_i$ ): +/- 0.55
- TOPOGRAPHICAL FACTOR: 1.0
- DIRECTIONALITY FACTOR: 1.0
- MINIMUM FOUNDATION CAPACITY REQUIREMENTS: REFER TO STRUCTURAL DRAWINGS
- SHELTER INSTALLATION REQUIREMENTS: REFER TO STRUCTURAL DRAWINGS

REFER TO STRUCTURAL DRAWINGS FOR ADDITIONAL STRUCTURAL NOTES AND DETAILS.

### ICC 500, 2020 CHAPTER 4: SITING

THE SHELTER IS NOT BEING CONSTRUCTED WITHIN AN AREA SUSCEPTIBLE TO FLOODING PER FEMA.

THE SITE IS LOCATED OUTSIDE OF ANY FLOOD PLAINS. THEREFORE, BASE FLOOD ELEVATION IS NOT APPLICABLE.

THE SHELTER FINISHED FLOOR ELEVATION IS 100' - 0".

### ICC 500 2020, SECTION 502 OCCUPANCY DENSITY IN COMMUNITY SHELTERS

TABLE 501.1.1 (TORNADO) - OCCUPANCY DENSITY

- 5 SF/STANDING OR SEATED MINIMUM
- 10 SF/WHEELCHAIR SPACE (1:200)

501.1.2.2 - ALTERNATIVE CALCULATION OF USABLE FLOOR AREA

GROSS AREA = 16' x 8' - 3 1/4"	= 132.33 SF
WALL AREA	- 29.23 SF
FIXED OBJECTS	- 15.57 SF
NET CLEAR AREA	87.53 SF

MAXIMUM OCCUPANCY = 14 OCCUPANTS + 1 WHEELCHAIR  
DECLARED BUILDING OCCUPANCY = 15 OCCUPANTS

- 501.2 - NUMBER OF DOORS
- BASED ON SHELTER OCCUPANCY, ONLY ONE MEANS OF EGRESS IS REQUIRED.
  - PER EXCEPTION LISTED UNDER 501.2, NO EMERGENCY ESCAPE OPENING IS REQUIRED FOR SHELTERS WITH AN OCCUPANT LOAD NOT EXCEEDING 15 OCCUPANTS.

- 501.3 - DIRECTION OF SWING
- DOOR SHALL SWING INTO THE SHELTER SPACE IN ACCORDANCE WITH OBC 2024.
  - DOOR ASSEMBLY TO BE TESTED AND LABELED IN ACCORDANCE WITH ICC 500 2020, CHAPTER 8 AND ASTM E361.

- 504 - SIGNAGE FOR COMMUNITY SHELTERS
- REFER TO VIEWS F3 AND F5 ON THIS SHEET FOR SIGNAGE LOCATIONS.
  - REFER TO SIGNAGE LEGEND ON SHEET A.03 FOR SIGNAGE DETAILS.

### ICC 500, 2020 CHAPTER 6: FIRE SAFETY

- 601.1 - FIRE SEPARATION
- ALL SHELTER WALLS ARE 2 HOUR FIRE RATED PARTITIONS, UL DESIGN NO. U905.
  - SHELTER HORIZONTAL ASSEMBLY (CEILING/ROOF) IS A 2 HR. RATED ASSEMBLY, UL DESIGN NO. D219.

- 602 - FIRE EXTINGUISHERS
- A WALL HUNG FIRE EXTINGUISHER IS PROVIDED MEETING IBC AND NFPA 10 REQUIREMENTS.
  - REFER TO SHEET A0.1 FOR MOUNTING DETAILS.

### ICC 500, 2020 CHAPTER 7: SHELTER ESSENTIAL FEATURES AND ACCESSORIES

SECTION 702: TORNADO SHELTERS  
STORM SHELTER OCCUPANCY IS 15 PEOPLE.

- 702.4.2 MECHANICAL VENTILATION
- AN OUTDOOR AIR FLOW RATE OF 5 CFM PER OCCUPANT IS REQUIRED. AT 15 PEOPLE, A TOTAL AIRFLOW RATE OF 80 CFM IS REQUIRED.
  - THE REQUIRED AIRFLOW IS PROVIDED BY EF-3 LOCATED WITHIN THE STORM SHELTER. EF-3 IS POWERED THROUGH THE STORM SHELTER UPS AND WILL OPERATE CONTINUOUSLY THROUGH THE 2-HOUR TIME PERIOD.
  - OUTSIDE AIR IS PROVIDED TO THE STORM SHELTER THROUGH A 6/8" TRANSFER AIR DUCT. THE OUTSIDE AIR DUCT HAS A MOTORIZED CONTROL DAMPER INSTALLED INSIDE OF THE STORM SHELTER. THE DAMPER HAS AN ACTUATOR THAT IS POWERED CLOSED, SPRING RETURN, FAIL OPEN.
  - WHEN THE STORM SHELTER IS IN USE DURING A TORNADO EVENT, THE SHELTER OCCUPANTS MAY ACTIVATE THE MANUAL SWITCH TO OPEN THE DAMPER. THE DAMPER HAS A BUILT-IN FAIL SAFE TO AUTOMATICALLY OPEN UPON THE LOSS OF NORMAL AND BACKUP GENERATOR POWER IF THE USER DOES NOT ACTIVATE THE MANUAL SWITCH PRIOR.

- TABLE 702.3
- ONE WATER CLOSET IS REQUIRED.
  - THE LAVATORY IS NOT REQUIRED.
  - HAND SANITIZER WILL BE STORED BY THE OWNER.

BASED ON 3 WATER CLOSET USES PER 8HR PERIOD PER OCCUPANT (FROM L.E.E.D.), IN A 2 HR PERIOD THAT IS 3/4 USES PER PERSON.  
FOR 15 PEOPLE, 12 FLUSHES WILL BE REQUIRED.

THE TANK WILL BE FILLED ON ENTRY INTO THE SPACE AS A STORM SHELTER, THE POLICE DEPARTMENT WILL BE REQUIRED TO STORE ENOUGH WATER TO ACCOMMODATE 12 FLUSHES.

EACH TANK FILL/FLUSH REQUIRES 1.6 GALLONS OF WATER, 1.6 GALLONS PER FLUSH X 12= 19.2 GALLONS MINIMUM OF POTABLE WATER NEED TO BE MADE AVAILABLE FOR WATER CLOSET USAGE.

ADDITIONAL POTABLE WATER SHALL BE STORED FOR DRINKING.  
INCLUDE THESE REQUIREMENTS IN THE OWNER'S INSTRUCTIONS.

REFER TO PLUMBING DRAWINGS FOR ADDITIONAL INFORMATION.

- 702.8 EMERGENCY LIGHTING
- LIGHTING FIXTURES WILL BE CONNECTED TO AN EMERGENCY BATTERY BACK-UP TO POWER LIGHTS IN SHELTER FOR A MINIMUM OF 2 HOURS UPON LOSS OF NORMAL POWER. REFER TO ELECTRICAL DRAWINGS FOR DETAILS.
  - A MINIMUM OF (3) FLASHLIGHTS >150 LUMENS EACH ARE TO BE STORED IN THE SHELTER.

## STORM SHELTER SPECIAL INSTRUCTIONS

### STORM EVENT OPERATIONS PLAN

POSITION DESIGNATED PERSONNEL AT DOOR TO ENSURE THAT ONCE ALL OCCUPANTS ARE INSIDE SHELTER, DOOR REMAINS CLOSED AND LOCKED DURING THE ENTIRE STORM EVENT.

- OPENING DOOR DURING HIGH PRE-EVENT OR EVENT WINDS COULD DAMAGE THE DEVICE. REMOVE THE DEVICE, OR MAKE IT WHERE THE DEVICE CANNOT BE RE-CLOSED MAKING ALL SHELTER OCCUPANTS VULNERABLE TO THE WIND EVENT FOR WHICH THEY ARE SEEKING PROTECTION.

SHELTER OCCUPANTS ARE NOT TO PHYSICALLY CONTACT THE EXTERIOR WALLS OR OPENING PROTECTIVE DEVICES OF THE SHELTER.


- VERY LARGE POINT LOADS CREATED BY DEBRIS MAY BE EXERTED ON THE EXTERIOR WALL AND THIS KINETIC ENERGY MAY BE TRANSFERRED THROUGH THE SHELTER WALL WHICH COULD INJURE AN INDIVIDUAL THAT IS CONTACT WITH THE EXTERIOR WALL OF THE SHELTER.

### STORAGE CABINET CONTENTS


- 19.2 GALLONS OF POTABLE WATER FOR TOILET FLUSHING (TO BE STORED ON BOTTOM SHELF)
- 2 CASES OF 16 OZ. WATER BOTTLES (EQUALING 3 GALLONS) FOR DRINKING
- HAND SANITIZER
- FIRST AID KIT COMPLYING WITH ANSI/ISEA Z308.1
- (3) FLASHLIGHTS WITH > 150 LUMENS OUTPUT EACH
- EVACUATION TOOLS
- HAMMER
- PRY BAR
- WORK GLOVES

### STORM SHELTER EVENT OPERATIONS PLAN - MECHANICAL VENTILATION


THE STORM SHELTER IS EQUIPPED WITH A MECHANICAL VENTILATION SYSTEM TO PROVIDE OUTSIDE AIR DURING USE. THE RESTROOM EXHAUST FAN INSIDE OF THE SHELTER WILL PULL OUTSIDE AIR IN AND VENTILATE EXHAUST AIR OUT. THE FAN IS POWERED THROUGH THE STORM SHELTER UPS AND WILL CONTINUE TO OPERATE IF THE BUILDING LOSES NORMAL AND GENERATOR BACKUP POWER UNDER A TORNADO STRIKE. THE STORM SHELTER HAS A DEDICATED OUTSIDE AIR INTAKE DUCT AND CONTROL DAMPER THAT IS MANUALLY CONTROLLED THROUGH A TOGGLE SWITCH. UNDER NORMAL BUILDING OPERATION, THE SWITCH SHALL REMAIN IN THE "DAMPER CLOSED" POSITION TO STOP OUTSIDE AIR INFILTRATION COMING INTO THE CONDITIONED BUILDING. WHEN THE STORM SHELTER IS IN USE DURING A TORNADO EVENT, TURN THE SWITCH TO THE "DAMPER OPEN" POSITION TO PROVIDE OUTSIDE AIR TO THE STORM SHELTER. THE OUTSIDE AIR DAMPER HAS A FAIL-SAFE BUILT INTO AUTOMATICALLY OPEN THE DAMPER IN THE EVENT OF BUILDING NORMAL AND BACKUP POWER LOSS. IF THE CONTROL SWITCH IS NOT ACTUATED PRIOR TO NORMAL AND BACKUP POWER LOSS, THE DAMPER FAIL-SAFE WILL OPEN THE DAMPER

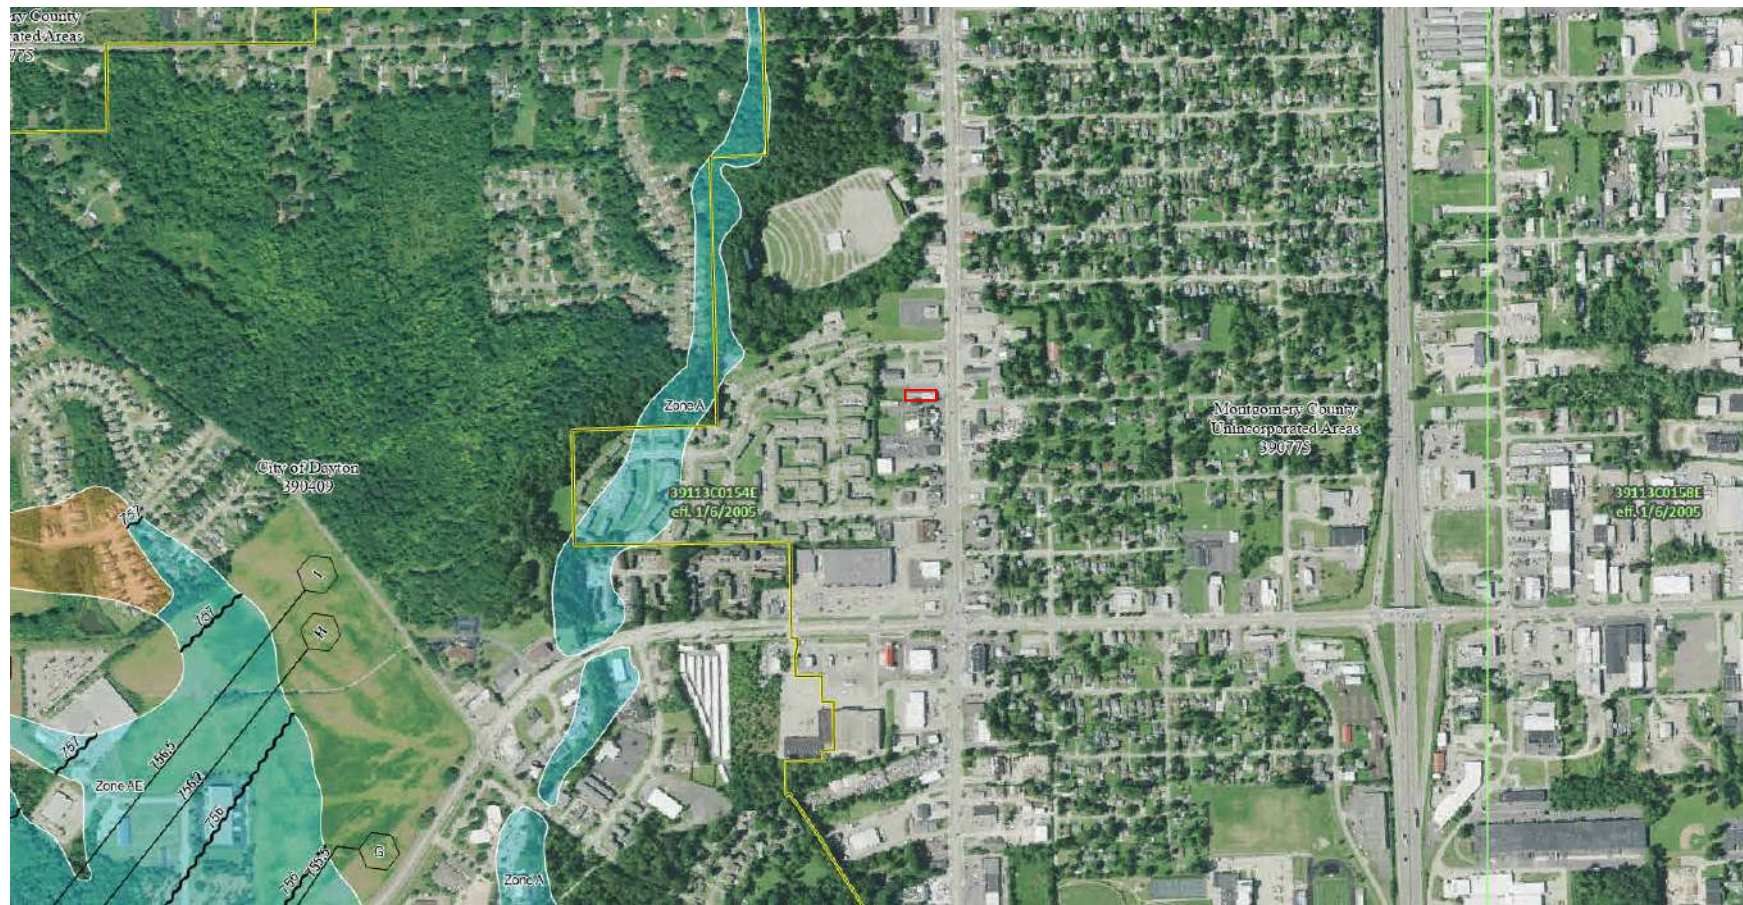

C4 NATIONAL FLOOD HAZARD FIRMETTE  
NOT TO SCALE

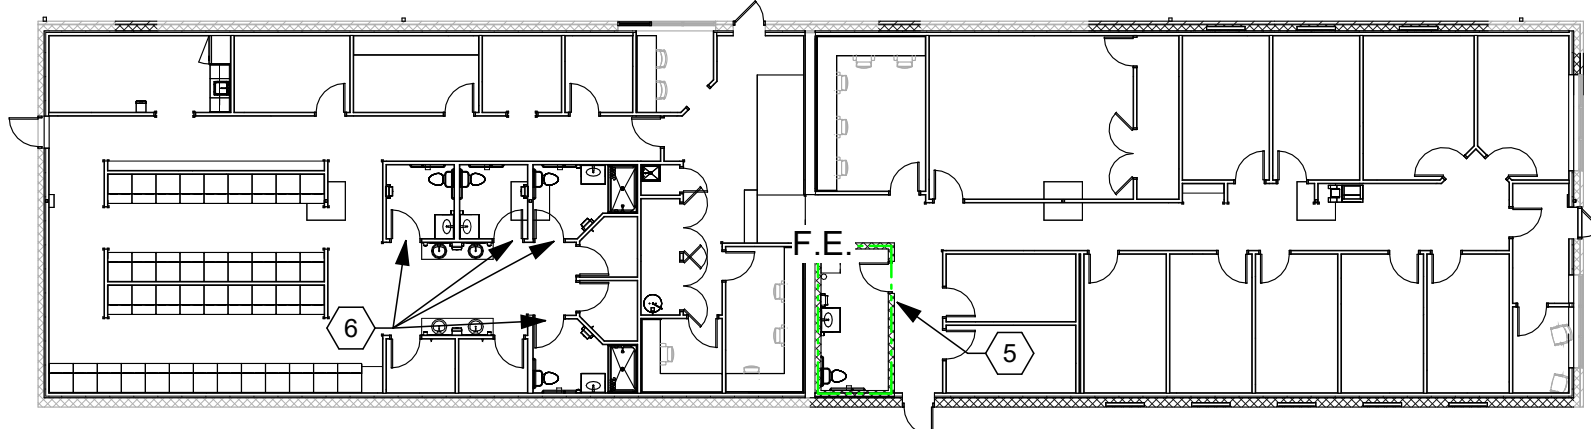

D4 STORM SHELTER KEY PLAN  
1" = 20'-0"

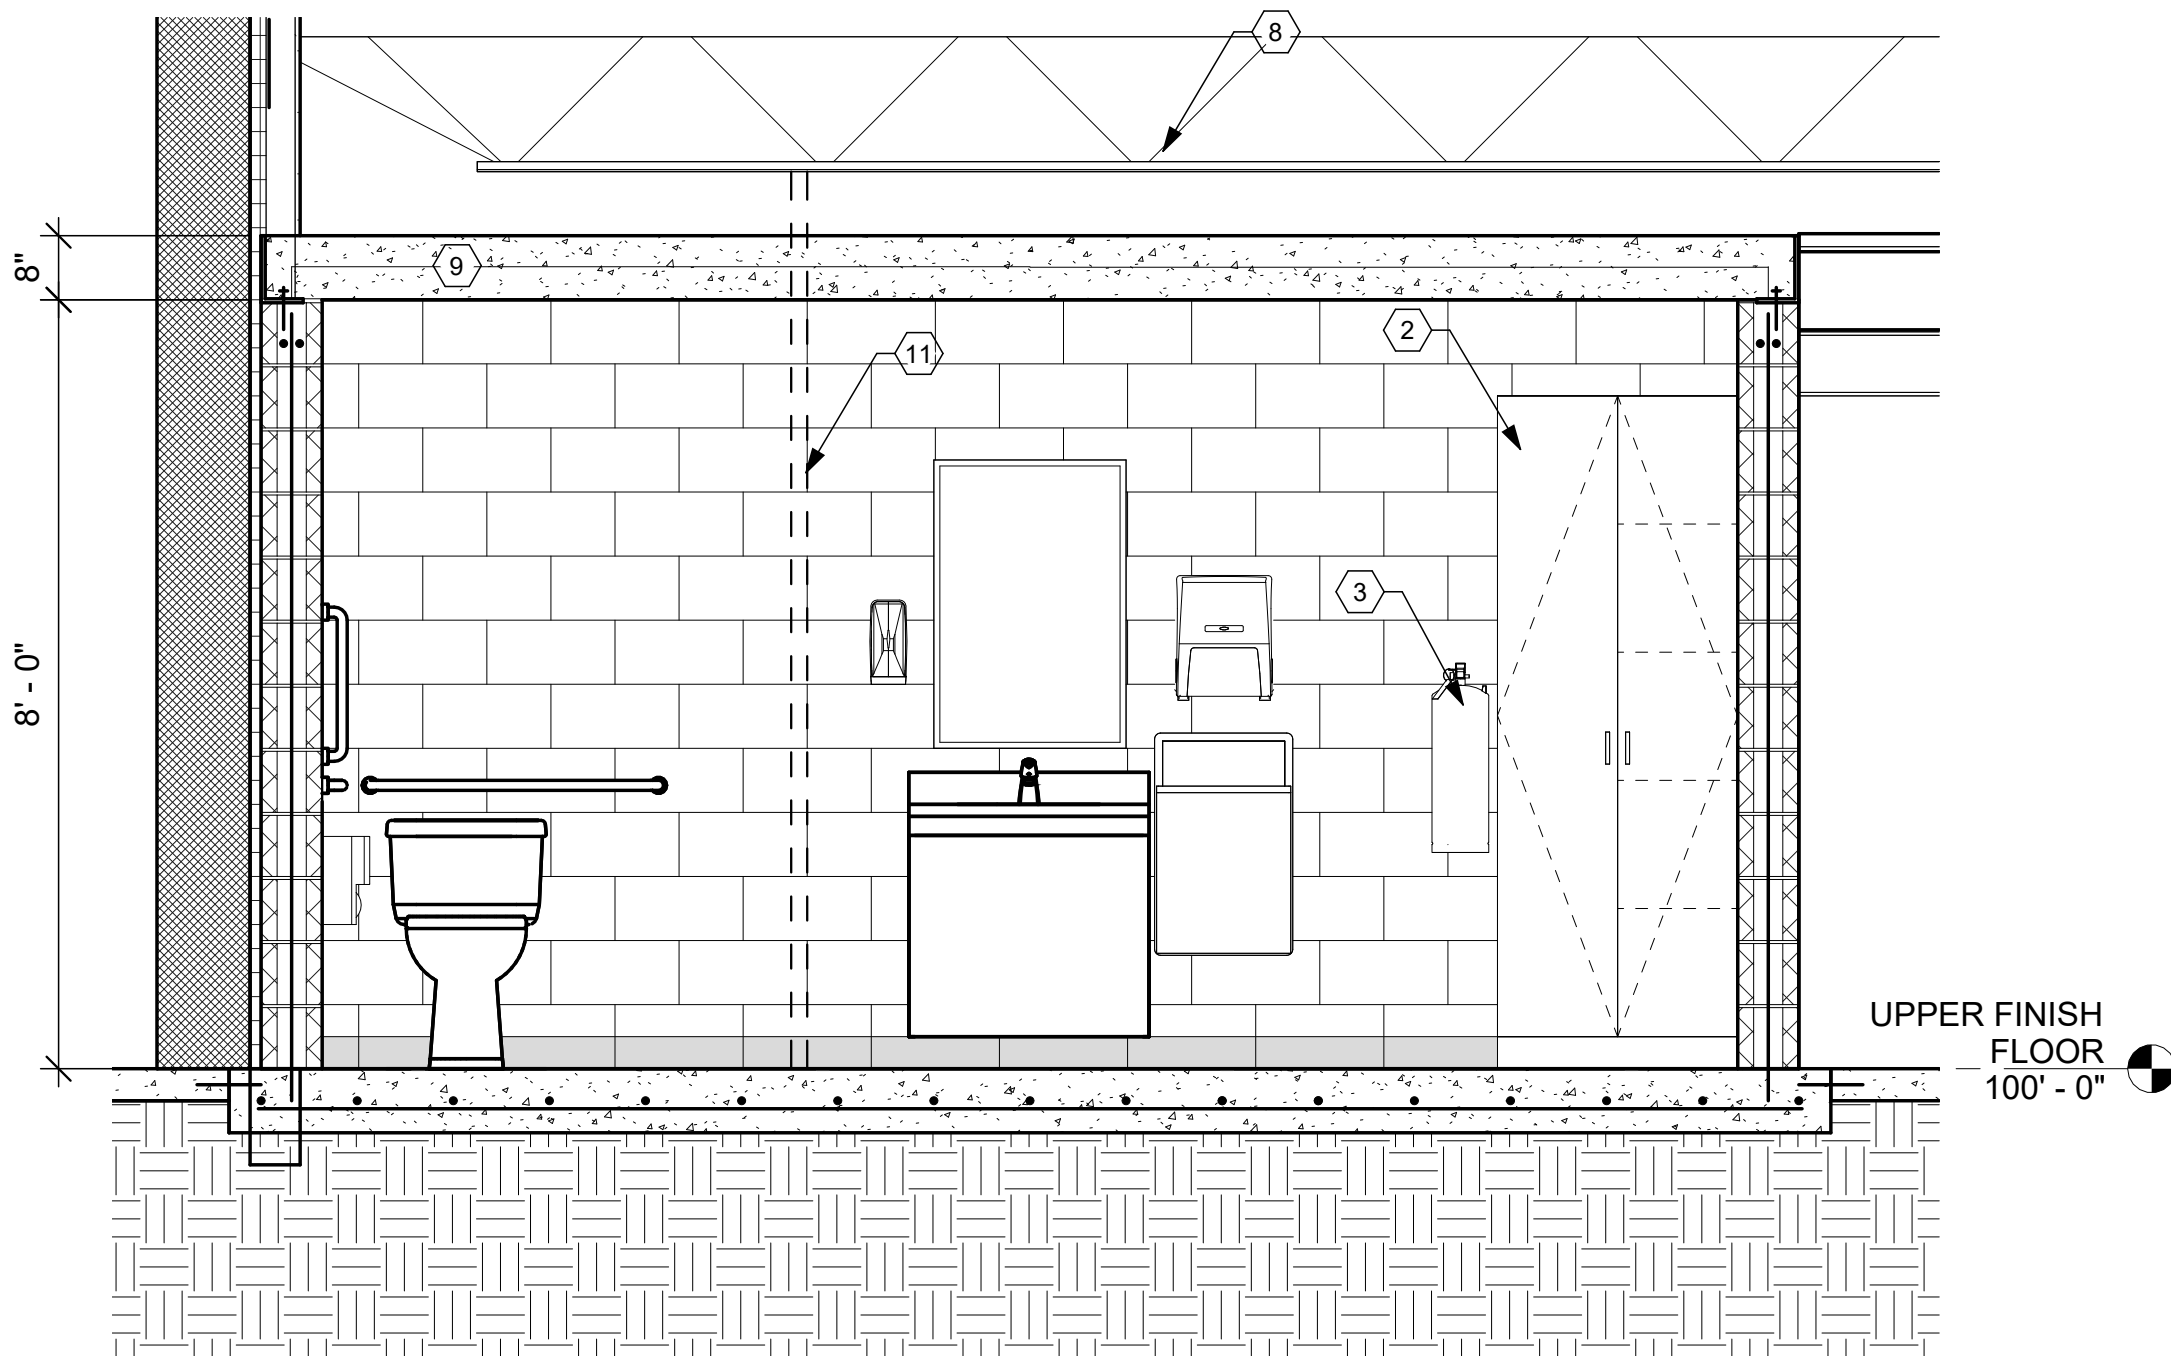

F4 STORM SHELTER SECTION (SEE F5/A7.2 FOR ACCESSORIES AND DIM. INFO.)  
1/2" = 1'-0"

F2 STORM SHELTER 119 ENLARGED PLAN  
1/2" = 1'-0"

## CONSTRUCTION NOTES

(00) INDICATES CONSTRUCTION NOTE.

- 1 SHADED AREA REPRESENTS ACTUAL CLEAR FLOOR AREA OF 87.53 SF. TOTAL ROOM AREA IS 103.10 SF.
- 2 STORAGE CABINET FOR WATER AND EMERGENCY SUPPLIES. REFER TO A8.1.
- 3 WALL MOUNTED FIRE EXTINGUISHER. REFER TO SHEET A0.1 FOR DETAILS.
- 4 ADA TOILET. REFER TO PLUMBING DRAWINGS AND SHEET A0.1 FOR DETAILS.
- 5 SIGN TYPE 5. REFER TO SIGNAGE LEGEND ON SHEET A0.3 FOR DETAILS.
- 6 SIGN TYPE 1. REFER TO SIGNAGE LEGEND ON SHEET A0.3 FOR DETAILS.
- 7 SIGN TYPE 7. REFER TO SIGNAGE LEGEND ON SHEET A0.3 FOR DETAILS.
- 8 CONCRETE LID IS INDEPENDENT OF ROOD STRUCTURE ABOVE. REFER TO STRUCTURAL DRAWINGS FOR DETAILS.
- 9 REFER TO HVAC DRAWINGS FOR DUCT PENETRATIONS. REFER TO STRUCTURAL DRAWINGS FOR SHROUD DETAILS.
- 10 REFER TO STRUCTURAL DRAWINGS FOR CONCRETE REBAR REINFORCEMENT DETAILS.
- 11 PRIVACY CUBICLE AND CURTAIN TRACK.
- 12 SIGN TYPE 10. REFER TO SIGNAGE LEGEND ON SHEET A0.3 FOR DETAILS.

## GENERAL NOTES

- A. THIS SHEET CONTAINS A GENERAL OVERVIEW OF THE TORNADO SHELTER INFORMATION. FOR FURTHER NOTES AND DETAILS REFER TO THE PERTINENT DISCIPLINE'S DRAWINGS CONTAINED IN THIS SET.
- B. REFER TO STRUCTURAL DRAWINGS FOR REINFORCEMENT DETAILS.



ARCHITECTURAL SPECIFICATIONS

DIVISION 00 - PROCUREMENT AND CONTRACTING REQUIREMENTS

DOCUMENT 00 2000 - INSTRUCTIONS FOR PROCUREMENT

1. REFER TO THE HARRISON TOWNSHIP REQUIREMENTS

DIVISION 01 - GENERAL REQUIREMENTS

SECTION 01 1000 - SUMMARY

1. PROJECT IDENTIFICATION:  
A. PROJECT NAME: HARRISON TWP DISTRICT 10 SHERIFF SUBSTATION RENOVATION  
B. PROJECT LOCATION: 6001 N. DIXIE DR. DAYTON, OHIO 45414  
C. OWNER: HARRISON TOWNSHIP, OHIO
2. TYPE OF CONTRACT: SINGLE PRIME CONTRACT  
A. ITEM 1: BASE BID: LUMP SUM  
B. ITEM 2: PHASE II - DELETE WORK AS INDICATED  
C. ITEM 3: DELETE NEW TRANSOM WINDOWS - NORTH AND SOUTH SIDE

3. WORK PHASES:  
A. PHASE I:  
a. INTERIOR SELECTIVE DEMOLITION OF WALLS, FLOORING, CEILINGS AND CORRESPONDING PLUMBING, HVAC AND ELECTRICAL EQUIPMENT AND DEVICES.  
b. NEW WALLS, DOORS, CEILINGS, FINISHES, CASEWORK AND CORRESPONDING PLUMBING, HVAC AND ELECTRICAL EQUIPMENT AND DEVICES.  
B. PHASE II:  
a. ALT. 1 - DELETE WORK FOR THIS PHASE.

4. TIME OF COMPLETION: SINGLE PHASE BID - SIX (6) MONTHS FROM NOTICE TO PROCEED.

5. USE OF PREMISES:  
A. OWNER WILL NOT OCCUPY PREMISES DURING STRINGENT CONSTRUCTION PERIOD.  
B. ON-SITE WORK HOURS SHALL BE PERFORMED INSIDE THE BUILDING DURING NORMAL WORKING HOURS OF (7:00) A.M. TO (5:00) P.M., MONDAY THROUGH FRIDAY AND AS COORDINATED WITH OWNER.

SECTION 01 2600 - CONTRACT MODIFICATION PROCEDURES

1. MINOR CHANGES IN THE WORK: PROVIDED BY CONTRACTOR WITHOUT ADJUSTMENT TO CONTRACT SUM OR CONTRACT TIME.
2. CHANGE ORDERS PER GENERAL CONDITIONS (IN BID BOOKLET).

SECTION 01 3100 - PROJECT MANAGEMENT AND COORDINATION

1. COORDINATION: COORDINATE CONSTRUCTION OPERATIONS OF PROJECT TO ENSURE EFFICIENT AND ORDERLY INSTALLATION OF EACH PART OF THE WORK.
2. PROJECT MEETINGS:  
A. PRECONSTRUCTION CONFERENCE: PRIOR TO STARTING CONSTRUCTION.  
B. PROGRESS MEETINGS: WEEKLY, ON JOB SITE.

SECTION 01 3200 - CONSTRUCTION PROGRESS DOCUMENTATION

1. CONTRACTOR'S CONSTRUCTION SCHEDULE: BAR-CHART SCHEDULE.

SECTION 01 3300 - SUBMITTAL PROCEDURES

1. TRANSMITTAL FORM: AIA G810 (OR APPROVED EQUAL).
2. PRODUCT SUBMITTALS:  
A. PRODUCT DATA: ELECTRONIC.  
B. SHOP DRAWINGS: ELECTRONIC TO SCALE DRAWINGS.  
C. SAMPLES: (2) SETS.

SECTION 01 4200 - REFERENCES

1. APPLICABILITY OF INDUSTRY STANDARDS: UNLESS THE CONTRACT DOCUMENTS INCLUDE MORE STRINGENT REQUIREMENTS, APPLICABLE CONSTRUCTION INDUSTRY STANDARDS HAVE THE SAME FORCE AND EFFECT AS IF BOUND OR COPIED DIRECTLY INTO THE CONTRACT DOCUMENTS TO THE EXTENT REFERENCED. SUCH STANDARDS ARE MADE PART OF THE CONTRACT DOCUMENTS BY REFERENCE.
2. PUBLICATION DATES OF INDUSTRY STANDARDS: COMPLY WITH STANDARDS IN EFFECT AS OF DATE OF CONTRACT DOCUMENTS.

SECTION 01 5000 - TEMPORARY FACILITIES AND CONTROLS

1. TEMPORARY UTILITY INSTALLATION AS FOLLOWS:  
A. GENERAL: INSTALL TEMPORARY SERVICE OR CONNECT TO EXISTING SERVICE.  
B. SEWERS AND DRAINAGE: USE OWNER'S EXISTING WATER SERVICE FACILITIES.  
C. SANITARY FACILITIES: USE OWNER'S EXISTING TOILET FACILITIES. COORDINATE WITH OWNER.  
D. HEATING (AND COOLING):  
a. PROVIDE TEMPORARY HEATING (AND COOLING) REQUIRED BY CONSTRUCTION ACTIVITIES FOR CURING OR DRYING AND PROTECTION OF COMPLETED INSTALLATION OF MATERIALS AND EQUIPMENT.  
b. MAINTAIN HEATING (AND COOLING) OF AREAS NOT UNDER CONSTRUCTION TO MEET OWNER STANDARDS.  
E. VENTILATION AND HUMIDITY CONTROL: PROVIDE TEMPORARY VENTILATION REQUIRED BY CONSTRUCTION ACTIVITIES FOR CURING OR DRYING AND PROTECTION OF COMPLETED INSTALLATION OF MATERIALS AND EQUIPMENT.  
F. ELECTRIC POWER SERVICE:  
a. USE OWNER'S EXISTING POWER SERVICE AND DISTRIBUTION SYSTEM.  
b. MAINTAIN ELECTRICAL SERVICE FROM OWNER'S EXISTING POWER SERVICE IN AREAS NOT UNDER CONSTRUCTION.  
G. LIGHTING: PROVIDE TEMPORARY LIGHTING WITH LOCAL SWITCHING THAT PROVIDES ADEQUATE ILLUMINATION FOR CONSTRUCTION OPERATIONS, OBSERVATIONS, INSPECTIONS, AND TRAFFIC CONDITIONS.  
H. TELEPHONE SERVICE:  
a. MAINTAIN EXISTING TELEPHONE SERVICE IN ALL AREAS NOT UNDER CONSTRUCTION.

2. TEMPORARY EQUIPMENT INCLUDES THE FOLLOWING:  
A. FIRE EXTINGUISHERS: PORTABLE, UL RATED; WITH GLASS AND EXTINGUISHING AGENT AS REQUIRED BY LOCATIONS AND CLASSES OF FIRE EXPOSURES.

3. TEMPORARY SECURITY AND PROTECTION FACILITIES AS FOLLOWS:  
A. FENCE BARRICADES AROUND EXTERIOR.  
B. SECURED DOORS OR OPENINGS.

4. TEMPORARY SUPPORT FACILITIES AS FOLLOWS:  
A. PROJECT IDENTIFICATION SIGN(S): SIGNAGE TO IDENTIFY AREAS OF WORK AND RESTRICTED ACCESS.

SECTION 01 6000 - PRODUCT REQUIREMENTS

1. PRODUCT SUBSTITUTIONS: CONSIDERED IF APPROVED BY OWNER AND ARCHITECT.
2. GENERAL PRODUCT REQUIREMENTS: PROVIDE PRODUCTS COMPLYING WITH CONTRACT DOCUMENTS, UNDAMAGED, AND, UNLESS OTHERWISE INDICATED, ARE NEW AT TIME OF INSTALLATION.

3. PRODUCT DELIVERY, STORAGE, AND HANDLING: USE MEANS AND METHODS THAT WILL PREVENT PRODUCT DAMAGE, DETERIORATION, AND LOSS, INCLUDING THEFT.

SECTION 01 7300 - EXECUTION

1. EXAMINATION OF EXISTING CONDITIONS: INVESTIGATE AND VERIFY THE EXISTENCE AND LOCATION OF MECHANICAL AND ELECTRICAL SYSTEMS AND OTHER CONSTRUCTION, INCLUDING UNDERGROUND UTILITIES AND CONSTRUCTION, AFFECTING THE WORK.
2. ACCEPTANCE OF CONDITIONS: EXAMINE SUBSTRATES, AREAS, AND CONDITIONS, WITH INSTALLER OR APPLICATOR, FOR COMPLIANCE WITH REQUIREMENTS FOR INSTALLATION TOLERANCES AND OTHER CONDITIONS AFFECTING PERFORMANCE.
3. COORDINATE WITH AUTHORITIES HAVING JURISDICTION THE ADJUSTMENT, MOVING, OR RELOCATION OF EXISTING UTILITY SERVICES OR STRUCTURES.
4. FIELD MEASUREMENTS: TAKEN PRIOR TO INSTALLATION TO FIT THE WORK PROPERLY AND VERIFY DIMENSIONS BEFORE FABRICATION.
5. CONSTRUCTION LAYOUT: LOCATE AND LAYOUT SITE IMPROVEMENTS AND CONTROL LINES AND LEVELS FOR BUILDING STRUCTURE.
6. FIELD ENGINEERING: LOCATE, ESTABLISH, AND MAINTAIN BENCHMARKS, CONTROL POINTS, AND SIMILAR REFERENCE POINTS PRIOR TO AND DURING CONSTRUCTION OPERATIONS.

7. INSTALLATION: LOCATE THE WORK AND COMPONENTS ACCURATELY, IN CORRECT ALIGNMENT AND ELEVATION, AND IN ACCORDANCE WITH MANUFACTURER'S WRITTEN INSTRUCTIONS AND RECOMMENDATIONS FOR INSTALLING PRODUCTS IN APPLICATIONS INDICATED.
8. PROGRESS CLEANING: CLEAN PROJECT SITE AND WORK AREAS DAILY, INCLUDING COMMON AREAS. COORDINATE PROGRESS CLEANING FOR JOINT-AREAS WHERE MORE THAN ONE INSTALLER HAS WORKED. MAINTAIN PROJECT SITE FREE OF WASTE MATERIALS AND DEBRIS. BURYING OR BURNING OF WASTE MATERIALS ON-SITE NOT PERMITTED.
9. START EQUIPMENT AND OPERATING COMPONENTS TO CONFIRM PROPER OPERATION. REMOVE MALFUNCTIONING UNITS, REPLACE WITH NEW UNITS AND RETEST.
10. CORRECTION OF WORK: REPAIR OR REMOVE AND REPLACE DEFECTIVE CONSTRUCTION.

SECTION 01 7329 - CUTTING AND PATCHING

1. PROVIDE TEMPORARY SUPPORT OF WORK TO BE CUT.
2. CUT IN PLACE CONSTRUCTION USING METHODS LEAST LIKELY TO DAMAGE ELEMENTS RETAINED OR ADJOINING CONSTRUCTION.
3. CUT OFF PIPE OR CONDUIT IN WALLS OR PARTITIONS TO BE REMOVED. CAP, VALVE, OR PLUG AND SEAL REMAINING PORTION OF PIPE OR CONDUIT.
4. PATCH CONSTRUCTION BY FILLING, REPAIRING, REFINISHING, CLOSING UP, AND SIMILAR OPERATIONS FOLLOWING PERFORMANCE OF OTHER WORK. PATCH WITH DURABLE SEAMS THAT ARE AS INVISIBLE AS POSSIBLE.

SECTION 01 7419 - CONSTRUCTION WASTE MANAGEMENT AND DISPOSAL

1. DISPOSAL OF WASTE: REMOVE WASTE MATERIALS FROM PROJECT SITE AND LEGALLY DISPOSE OFF SITE. DO NOT BURN WASTE MATERIALS.

SECTION 01 7700 - CLOSEOUT PROCEDURES

1. SUBMIT LIST OF ITEMS TO BE COMPLETED AND CORRECTED AND WRITTEN REQUEST FOR AN INSPECTION. COMPLETE AND CORRECT ITEMS ON PUNCH LIST.
2. FINAL CLEANING: CLEAN EACH SURFACE OR UNIT TO CONDITION EXPECTED IN AN AVERAGE COMMERCIAL BUILDING CLEANING AND MAINTENANCE PROGRAM. COMPLY WITH MANUFACTURER'S WRITTEN INSTRUCTIONS. REMOVE DEBRIS AND SURFACES DUST, CLEAN GLASS, REMOVE SOILS AND STAINS, CLEAN LIGHT LENSES AND DUCTWORK, AND REPLACE AIR FILTERS AND LIGHT BULBS USED DURING CONSTRUCTION.

3. WARRANTIES: SUBMIT WRITTEN WARRANTIES FOR DESIGNATED PORTIONS OF WORK.

SECTION 01 7823 - OPERATION AND MAINTENANCE DATA

1. OPERATION AND MAINTENANCE MANUALS:  
A. (2) SETS (BINDERS WITH TABLE OF CONTENTS) FOR SYSTEMS, SUBSYSTEMS, AND EQUIPMENT.  
B. (1) ELECTRONIC COPY; BOOKMARKED. PDF.
2. EMERGENCY MANUALS:  
A. (2) SETS (BINDERS WITH TABLE OF CONTENTS) FOR INSTRUCTIONS AND PROCEDURE FOR EMERGENCIES (FIRE, FLOOD, GAS LEAK, WATER LEAK, POWER FAILURE, WATER OUTAGE, ETC.)  
B. (1) ELECTRONIC COPY; BOOKMARKED. PDF.

SECTION 01 7839 - PROJECT RECORD DOCUMENTS

1. RECORD DRAWINGS: (1) SET MARKED TO SHOW ACTUAL INSTALLATION WHERE VARIES FROM ORIGINAL.
2. RECORD SPECIFICATIONS: (1) SET MARKED TO INDICATE ACTUAL PRODUCT INSTALLATION WHERE VARIES FROM ORIGINAL. (INCLUDE COPIES OF ADDENDA AND CHANGE ORDERS).

DIVISION 02 - EXISTING CONDITIONS

SECTION 02 4119 - SELECTIVE STRUCTURE DEMOLITION

1. SELECTIVE DEMOLITION: DEMOLISH AND REMOVE EXISTING CONSTRUCTION ONLY TO THE EXTENT REQUIRED BY NEW CONSTRUCTION AND AS INDICATED ON DRAWINGS. USE METHODS REQUIRED TO COMPLETE THE WORK WITHIN LIMITATIONS OF GOVERNING REGULATIONS.
2. MAINTAIN UTILITY SERVICES AND MECHANICAL/ELECTRICAL SYSTEMS TO REMAIN AND PROTECT THEM AGAINST DAMAGE DURING SELECTIVE DEMOLITION OPERATIONS.
3. PROVIDE AND MAINTAIN SHORING, BRACING, AND STRUCTURAL SUPPORTS TO PRESERVE STABILITY AND PREVENT MOVEMENT, SETTLEMENT, OR COLLAPSE OF CONSTRUCTION AND FINISHES TO REMAIN.
4. EXCEPT FOR ITEMS TO BE REUSED, SALVAGED, OR REINSTALLED, REMOVE DEMOLISHED MATERIALS FROM PROJECT SITE AND LEGALLY DISPOSE.

DIVISION 03 - CONCRETE

SECTION 033000 - CAST-IN-PLACE CONCRETE

1. CONCRETE WORK SHALL BE ACCOMPLISHED IN ACCORDANCE WITH THE LATEST "AMERICAN CONCRETE INSTITUTE" RECOMMENDATIONS.
2. CONCRETE MIXES FOR BUILDING ELEMENTS: SUPPORTED SLABS, BEAMS: (4000) PSI U.N.O. STRUCTURAL DRAWINGS.
3. FINISHING FORMED SURFACES: EXPOSED WALLS AND OTHER SURFACES SHALL RECEIVE SMOOTH-FORMED FINISH.
4. FINISHING FLOORS AND SLABS: APPLY TROWEL FINISH TO SURFACES EXPOSED TO VIEW AND TO BE COVERED WITH FINISH FLOORING MATERIAL. APPLY CURING AND SEALING COMPOUND UNIFORMLY TO FLOORS.

DIVISION 04 - MASONRY

SECTION 042000 - UNIT MASONRY

1. CONCRETE MASONRY UNITS: ASTM C 90 WITH UNIT COMPRESSIVE STRENGTH OF (1900) PSI, WEIGHT CLASSIFICATION OF (NORMAL WEIGHT), AND SIZED 3/8" LESS THAN NOMINAL DIMENSIONS.
2. MORTAR:  
A. MATERIALS: PORTLAND CEMENT, HYDRATED LIME, AGGREGATES AND WATER.  
B. MIXES: COMPLY WITH ASTM C 270, TYPE N.
3. TIES AND ANCHORS: HOT-DIPPED GALVANIZED STEEL WIRE OR SHEET, ADJUSTABLE ANCHORS.

DIVISION 06 - WOOD, PLASTICS, AND COMPOSITES

SECTION 06 4116 - PLASTIC-LAMINATE-FACED ARCHITECTURAL CABINETS

1. ACTION SUBMITTALS  
A. PRODUCT DATA: FOR EACH TYPE OF PRODUCT, INCLUDING: PANEL PRODUCTS, HIGH-PRESSURE DECORATIVE LAMINATE, ADHESIVE FOR BONDING PLASTIC LAMINATE, CABINET HARDWARE AND ACCESSORIES.  
B. SHOP DRAWINGS: SHOW LOCATION OF EACH ITEM, DIMENSIONED PLANS AND ELEVATIONS, LARGE-SCALE DETAILS, ATTACHMENT DEVICES, AND OTHER COMPONENTS.  
c. SHOW DETAILS' FULL SIZE.  
b. SHOW LOCATIONS AND SIZES OF FURRING, BLOCKING, AND HANGING STRIPS, INCLUDING CONCEALED BLOCKING AND REINFORCEMENT SPECIFIED IN OTHER SECTIONS.  
c. SHOW LOCATIONS AND SIZES OF CUTOUTS AND HOLES FOR AND OTHER ITEMS INSTALLED IN ARCHITECTURAL PLASTIC-LAMINATE CABINETS.  
d. APPLY AII QUALITY CERTIFICATION PROGRAM LABEL TO SHOP DRAWINGS.  
C. SAMPLES FOR VERIFICATION:  
a. WOOD-GRAIN PLASTIC LAMINATES, 8 X 10 INCHES, FOR EACH TYPE, PATTERN AND SURFACE FINISH.  
2. INFORMATIONAL SUBMITTALS  
A. QUALIFICATION DATA: FOR FABRICATOR.  
B. SINGLE SOURCE RESPONSIBILITY: PROVIDE AND INSTALL THIS WORK FROM A SINGLE FABRICATOR.  
3. QUALITY ASSURANCE  
A. FABRICATOR QUALIFICATIONS: SHOP THAT EMPLOYS SKILLED WORKERS WHO CUSTOM FABRICATE PRODUCTS SIMILAR TO THOSE REQUIRED FOR THIS PROJECT.

4. FIELD CONDITIONS  
A. ENVIRONMENTAL LIMITATIONS: DO NOT DELIVER OR INSTALL CABINETS UNLESS BUILDING IS ENCLOSED, WET WORK IS COMPLETE, AND HVAC SYSTEM IS OPERATING AND MAINTAINING TEMPERATURE BETWEEN 60 AND 90 DEG F (16 AND 32 DEG C) AND RELATIVE HUMIDITY BETWEEN 25 AND 55 PERCENT DURING THE REMAINDER OF THE CONSTRUCTION PERIOD.  
B. FIELD MEASUREMENTS: WHERE CABINETS ARE INDICATED TO FIT TO OTHER CONSTRUCTION, VERIFY DIMENSIONS OF OTHER CONSTRUCTION BY FIELD MEASUREMENTS BEFORE FABRICATION, AND INDICATE MEASUREMENTS ON SHOP DRAWINGS. COORDINATE FABRICATION SCHEDULE WITH CONSTRUCTION PROGRESS TO AVOID DELAYING THE WORK.  
a. LOCATE CONCEALED FRAMING, BLOCKING, AND REINFORCEMENTS THAT SUPPORT CABINETS BY FIELD MEASUREMENTS BEFORE BEING ENCLOSED, AND INDICATE MEASUREMENTS ON SHOP DRAWINGS.  
C. ESTABLISHED DIMENSIONS: WHERE CABINETS ARE INDICATED TO FIT TO OTHER CONSTRUCTION, ESTABLISH DIMENSIONS FOR AREAS WHERE CABINETS ARE TO FIT, PROVIDE ALLOWANCE FOR TRIMMING AT SITE, AND COORDINATE CONSTRUCTION TO ENSURE THAT ACTUAL DIMENSIONS CORRESPOND TO ESTABLISHED DIMENSIONS.

5. COORDINATION  
A. COORDINATE SIZES AND LOCATIONS OF FRAMING, LOOKAHEAD FLOORING MATERIAL, AND OTHER RELATED UNITS OF WORK SPECIFIED IN OTHER SECTIONS TO ENSURE THAT CABINETS CAN BE SUPPORTED AND INSTALLED AS INDICATED.

6. PRODUCTS - PLASTIC-LAMINATE-FACED ARCHITECTURAL CABINETS  
A. QUALITY STANDARD: UNLESS OTHERWISE INDICATED, COMPLY WITH THE "ARCHITECTURAL WOODWORK STANDARDS" FOR GRADES OF ARCHITECTURAL PLASTIC-LAMINATE CABINETS INDICATED FOR CONSTRUCTION, FINISHES, INSTALLATION, AND OTHER REQUIREMENTS.  
B. GRADE: PREMIUM.  
C. TYPE OF CONSTRUCTION: FRAMELESS.  
D. CABINET, DOOR, AND DRAWER FRONT INTERFACE STYLE: FLUSH OR BUTT.  
E. HIGH-PRESSURE DECORATIVE LAMINATE: NEMA LD 3, GRADES AS INDICATED OR IF NOT INDICATED, AS REQUIRED BY WOODWORK QUALITY STANDARD.  
a. MANUFACTURERS: SUBJECT TO COMPLIANCE WITH REQUIREMENTS OF REFERENCED QUALITY STANDARD FOR EACH TYPE OF WOODWORK AND QUALITY GRADE SPECIFIED UNLESS OTHERWISE INDICATED.  
F. LAMINATE CLADDING FOR EXPOSED SURFACES:  
a. HORIZONTAL SURFACES: GRADE HGS.  
b. VERTICAL SURFACES: GRADE VGS.  
c. EDGES: 3MM MATCHING LAMINATE IN COLOR, PATTERN, AND FINISH.  
d. PATTERN DIRECTION: VERTICALLY FOR DRAWER FRONTS, DOORS, AND FIXED PANELS.  
G. MATERIALS FOR SEMIEXPOSED SURFACES:  
a. SURFACES OTHER THAN DRAWER BODIES: HIGH-PRESSURE DECORATIVE LAMINATE, NEMA LD 3, GRADE VGS.  
1. EDGES OF PLASTIC-LAMINATE SHELVES: PVC EDGE BANDING, 0.12 INCH (3 MM) THICK, MATCHING LAMINATE IN COLOR, PATTERN, AND FINISH.  
2. FOR SEMIEXPOSED BACKS OF PANELS WITH EXPOSED PLASTIC-LAMINATE SURFACES, PROVIDE SURFACE OF HIGH-PRESSURE DECORATIVE LAMINATE, NEMA LD 3, GRADE VGS.  
H. CONCEALED BACKS OF PANELS WITH EXPOSED PLASTIC-LAMINATE SURFACES: HIGH-PRESSURE DECORATIVE LAMINATE, NEMA LD 3, GRADE BKL.  
I. COLORS, PATTERNS, AND FINISHES: PROVIDE MATERIALS AND PRODUCTS THAT RESULT IN COLORS AND TEXTURES OF EXPOSED LAMINATE SURFACES COMPLYING WITH THE FOLLOWING REQUIREMENTS:  
a. MATCH ARCHITECT'S SAMPLE.  
J. CABINET HARDWARE:  
a. HINGES: 2 1/2 INCH, 5-KNUCKLE STEEL HINGES MADE FROM 0.093 INCH THICK METAL AS FOLLOWS:  
• PRODUCT: ROCKFORD PROCESS CONTROL (RPC) MODEL NO. 376-101 WITH HOSPITAL TIP NON-REMOVABLE PIN.  
• SEMI-CONCEALED HINGES FOR FLUSH OVERLAY DOORS: BAMA A156.9.  
• FINISH: 260 DULL CHROME.  
b. (KITCHENETTES AND BREAK ROOMS ONLY) FRAMELESS CONCEALED HINGES (EUROPEAN TYPE): BHMA A156.9, TYPE B01602, 125 DEGREES OF OPENING, SELF-CLOSING. PROVIDE TWO HINGES FOR DOORS LESS THAN 48 INCHES HIGH, AND PROVIDE THREE HINGES FOR DOORS MORE THAN 48 INCHES HIGH.  
c. DOOR AND DRAWER PULLS: BACK MOUNTED, SOLID METAL, 6 INCHES LONG, 5/16" IN DIAMETER, LANSA BY IKEA.  
d. ADJUSTABLE SHELF STANDARDS AND SUPPORTS: KNAPE AND VOGT #255 STEEL STANDARDS AND #256 STEEL SUPPORTS.  
e. CLOSET SHELF STANDARDS AND SUPPORTS: KNAPE AND VOGT KV185 HEAVY DUTY DOUBLE SLOTTED SHELF BRACKETS AND KV85 HEAVY DUTY DOUBLE SLOTTED SHELF STANDARDS.  
f. DRAWER SLIDES: BHMA A156.9, B05091.  
• (KITCHENETTES AND BREAK ROOMS ONLY) HEAVY DUTY (GRADE 1HD-100 AND GRADE 1HD-200) CONCEALED UNDERMOUNT, FULL-OVERTRAVEL- EXTENSION TYPE; ZINC-PLATED STEEL BALL-BEARING SLIDES; INTEGRATED SOFT-CLOSE; AIR DAMPENING.  
g. FOR EXPOSED HARDWARE, PROVIDE FINISH THAT COMPLIES WITH BHMA A156.9 FOR BHMA FINISH NUMBER INDICATED.  
• SATIN CHROMIUM PLATED: BHMA 626 FOR BRASS OR BRONZE BASE; BHMA 652 FOR STEEL BASE.

7. SOLID SURFACE COUNTERTOP MATERIALS  
A. SOLID SURFACE MATERIAL: HOMOGENEOUS, FILLED PLASTIC RESIN COMPLYING WITH ICPSA SS-1.  
A. MANUFACTURER: AS INDICATED ON THE MATERIAL LEGEND ON THE DRAWINGS.  
B. TYPE: PROVIDE STANDARD TYPE UNLESS SPECIAL PURPOSE TYPE IS INDICATED.  
C. INTEGRAL SINK BOWLS: COMPLY WITH CSA B45 S/APMO 2124. PROVIDE MODELS/SIZES INDICATED ON THE MATERIAL LEGEND ON THE DRAWINGS.  
D. COLORS AND PATTERNS: AS INDICATED ON THE MATERIAL LEGEND ON THE DRAWINGS.  
B. COUNTERTOP FABRICATION  
A. FABRICATE COUNTERTOPS ACCORDING TO SOLID SURFACE MATERIAL MANUFACTURER'S WRITTEN INSTRUCTIONS AND TO THE AIA/ANMAC/WS "ARCHITECTURAL WOODWORK STANDARDS."  
1. GRADE: PREMIUM.  
B. CONFIGURATION:  
1. FRONT: FABRICATE TOPS WITH SHOP-APPLIED EDGES OF MATERIALS AND CONFIGURATION INDICATED ON THE DRAWINGS.  
2. BACKSPLASH: SET ON BACKSPLASHES AND SIDE SPLASHES. PROVIDE WITH COVED CORNER TRIM UNITS FOR JOINING BACK AND SIDE SPLASHES FOR SEAMLESS FABRICATION.  
3. END SPLASH: MATCHING BACKSPLASH.  
C. COUNTERTOPS: 1/2-INCH- (12.7-MM-) THICK, SOLID SURFACE MATERIAL WITH FRONT EDGE BUILT UP WITH SAME MATERIAL.  
D. BACKSPLASHES: 1/2-INCH- (12.7-MM-) THICK, SOLID SURFACE MATERIAL.  
e. FABRICATE TOPS WITH SHOP-APPLIED EDGES AND BACKSPLASHES UNLESS OTHERWISE INDICATED. COMPLY WITH SOLID SURFACE MATERIAL MANUFACTURER'S WRITTEN INSTRUCTIONS FOR ADHESIVES, SEALERS, FABRICATION, AND FINISHING.  
1. INSTALL INTEGRAL SINK BOWLS IN COUNTERTOPS IN THE SHOP.

8. WOOD MATERIALS  
A. WOOD PRODUCTS: PROVIDE MATERIALS THAT COMPLY WITH REQUIREMENTS OF REFERENCED QUALITY STANDARD FOR EACH TYPE OF WOODWORK AND QUALITY GRADE SPECIFIED UNLESS OTHERWISE INDICATED.  
a. WOOD MOISTURE CONTENT: 5 TO 10 PERCENT.  
B. COMPOSITE WOOD AND AGRIFIBER PRODUCTS: PROVIDE MATERIALS THAT COMPLY WITH REQUIREMENTS OF REFERENCED QUALITY STANDARD FOR EACH TYPE OF WOODWORK AND QUALITY GRADE SPECIFIED UNLESS OTHERWISE INDICATED.  
a. MEDIUM-DENSITY FIBERBOARD: ANSI A208.2, MD.  
b. PARTICLEBOARD: ANSI A208.1, GRADE M-2.  
c. SOFTWOOD PLYWOOD: DOC PS 1, MEDIUM-DENSITY OVERLAY.  
d. VENEER-FACED PANEL PRODUCTS (HARDWOOD PLYWOOD): HPVA HP-1.

9. FABRICATION  
A. FABRICATE CABINETS TO DIMENSIONS, PROFILES, AND DETAILS INDICATED.  
B. COMPLETE FABRICATION, INCLUDING ASSEMBLY AND HARDWARE APPLICATION, TO MAXIMUM EXTENT POSSIBLE BEFORE SHIPMENT TO PROJECT SITE. DISASSEMBLE COMPONENTS ONLY AS NECESSARY FOR SHIPMENT AND MINUS 25 PERCENT MOVEMENT CAPABILITY, NONTRAFFIC-USE, ACID-CURING SILICONE JOINT SEALANT: ASTM C 920, TYPE S, GRADE NS, CLASS 25, USE NT; (DOW CORNING CORPORATION, 786-M; GE CONSTRUCTION SEALANTS, SCS1700; TREMCO INCORPORATED, TREMSIL 200).  
B. INTERIOR LATEX SEALANT: ASTM C 834, TYPE CP, GRADE NF (BOSTIC CHEM-CALK 600, PECORA AC-20 +, SONNEBORN SONOLAC, OR TREMCO TREMFLEX 834).  
a. SHOP-CUT OPENINGS TO MAXIMUM EXTENT POSSIBLE TO RECEIVE HARDWARE, APPLIANCES, ELECTRICAL WORK, AND SIMILAR ITEMS. LOCATE OPENINGS ACCURATELY AND USE TEMPLATES OR ROUGH-IN DIAGRAMS TO PRODUCE ACCURATELY SIZED AND SHAPED OPENINGS. SAND EDGES OF CUTOUTS TO REMOVE SPLINTERS AND BURRS.

10. INSTALLATION PREPARATION  
A. BEFORE INSTALLATION, CONDITION CABINETS TO AVERAGE PREVAILING HUMIDITY CONDITIONS IN INSTALLATION AREAS.  
B. BEFORE INSTALLING CABINETS, EXAMINE SHOP-FABRICATED WORK FOR COMPLETION AND COMPLETE WORK AS REQUIRED.

11. INSTALLATION  
A. GRADE: INSTALL CABINETS TO COMPLY WITH SAME GRADE AS ITEM TO BE INSTALLED.  
B. ASSEMBLE CABINETS AND COMPLETE FABRICATION AT PROJECT SITE TO THE EXTENT THAT IT WAS NOT COMPLETED IN THE SHOP.  
C. INSTALL CABINETS LEVEL, PLUMB, TRUE, AND STRAIGHT. SHIM AS REQUIRED WITH CONCEALED SHIMS. INSTALL LEAD AND PLUMB TO A TOLERANCE OF 1/8 INCH IN 96 INCHES (3 MM IN 2400 MM).  
D. SCRIBE AND CUT CABINETS TO FIT ADJOINING WORK; REFINISH CUT SURFACES, AND REPAIR DAMAGED FINISH AT CUTS.  
E. ANCHOR CABINETS TO ANCHORS OR BLOCKING BUILT IN OR DIRECTLY ATTACHED TO SUBSTRATES. SECURE WITH COUNTERSUNK CONCEALED FASTENERS AND NAILS. USE FINE FINISHING NAILS OR FINISHING SCREWS FOR EXPOSED FASTENING, COUNTERSUNK AND FILLED FLUSH WITH WOODWORK.  
a. USE FILLER MATCHING FINISH OF ITEMS BEING INSTALLED.  
F. CABINETS: INSTALL WITHOUT DISTORTION SO DOORS AND DRAWERS FIT OPENINGS PROPERLY AND ARE ACCURATELY ALIGNED. ADJUST HARDWARE TO CENTER DOORS AND DRAWERS IN OPENINGS AND TO PROVIDE UNENCUMBERED OPERATION. COMPLETE INSTALLATION OF HARDWARE AND ACCESSORY ITEMS AS INDICATED.  
a. INSTALL CABINETS WITH NO MORE THAN 1/8 INCH IN 96-INCH (3 MM IN 2400-MM) SAG, BOW, OR OTHER VARIATION FROM A STRAIGHT LINE.  
b. FASTEN WALL CABINETS THROUGH BACK, NEAR TOP AND BOTTOM, AND AT ENDS NOT MORE THAN 16 INCHES (400 MM) O.C. WITH NO. 10 WATER-HEAD SHEET METAL SCREWS THROUGH METAL BACKING OR METAL FRAMING BEHIND WALL FINISH.

12. ADJUSTING AND CLEANING  
A. REPAIR DAMAGED AND DEFECTIVE CABINETS, WHERE POSSIBLE, TO ELIMINATE FUNCTIONAL AND VISUAL DEFECTS; WHERE NOT POSSIBLE TO REPAIR, REPLACE WOODWORK. ADJUST JOINERY FOR UNIFORM APPEARANCE.  
B. CLEAN, LUBRICATE, AND ADJUST HARDWARE.  
C. CLEAN CABINETS ON EXPOSED AND SEMIEXPOSED SURFACES.

DIVISION 07 - THERMAL AND MOISTURE PROTECTION

SECTION 07 2100 - THERMAL INSULATION

1. GENERAL  
A. BATT INSULATION FOR FILLING PERIMETER WINDOW AND DOOR SHIM SPACES AND CREVICES IN EXTERIOR WALL.  
B. BOARD INSULATION AT EXTERIOR WALLS.
2. PRODUCTS  
A. APPLICATIONS  
a. INSULATION OVER METAL STUD FRAMED WALLS, CONTINUOUS: EXTRUDED POLYSTYRENE (XPS) BOARD.  
b. INSULATION IN METAL FRAMED WALLS: BATT INSULATION WITH SEPARATE VAPOR RETARDER.  
B. FOAM BOARD INSULATION MATERIALS  
a. EXTRUDED POLYSTYRENE (XPS) BOARD INSULATION: COMPLY WITH ASTM C578 WITH EITHER NATURAL SKIN OR CUT CELL SURFACES.  
b. TYPE AND COMPRESSIVE RESISTANCE: TYPE XII 15 PSI (104 KPA), MINIMUM.  
c. FLAME SPREAD INDEX (FDI): CLASS A - 0 TO 25, WHEN TESTED IN ACCORDANCE WITH ASTM E84.  
d. SMOKE DEVELOPED INDEX (SDI): 450 OR LESS, WHEN TESTED IN ACCORDANCE WITH ASTM E84.  
C. MINERAL FIBER BLANKET INSULATION MATERIALS  
a. FLEXIBLE GLASS FIBER BLANKET THERMAL INSULATION: PREFORMED INSULATION, COMPLYING WITH ASTM C665: FRICTION FIT.  
b. FLAME SPREAD INDEX: 25 OR LESS, WHEN TESTED IN ACCORDANCE WITH ASTM E84.  
c. SMOKE DEVELOPED INDEX: 50 OR LESS, WHEN TESTED IN ACCORDANCE WITH ASTM E84.  
d. COMBUSTIBILITY: NON-COMBUSTIBLE, WHEN TESTED IN ACCORDANCE WITH ASTM E136, EXCEPT FOR FACING IF ANY.
3. EXECUTION  
A. EXAMINATION  
a. VERIFY THAT SUBSTRATE, ADJACENT MATERIALS, AND INSULATION MATERIALS ARE DRY AND THAT SUBSTRATES ARE READY TO RECEIVE INSULATION AND ADHESIVE.

SECTION 07 9200 - JOINT SEALANTS

1. MAINTAIN WATERTIGHT AND AIRTIGHT CONTINUOUS SEALS WITHOUT STAINING OR DETERIORATING ADJOINING SUBSTRATES.
2. MATERIALS: COMPATIBLE WITH ONE ANOTHER AND WITH SUBSTRATES UNDER CONDITIONS OF SERVICE AND APPLICATIONS AS FOLLOWS:  
A. MILDEW-RESISTANT JOINT SEALANTS: SILICONE, MILDEW RESISTANT, ACID CURING, S, NS, 25, NT; MILDEW-RESISTANT, SINGLE-COMPONENT, NONSAG, PLUS 25 PERCENT AND MINUS 25 PERCENT MOVEMENT CAPABILITY, NONTRAFFIC-USE, ACID-CURING SILICONE JOINT SEALANT: ASTM C 920, TYPE S, GRADE NS, CLASS 25, USE NT; (DOW CORNING CORPORATION, 786-M; GE CONSTRUCTION SEALANTS, SCS1700; TREMCO INCORPORATED, TREMSIL 200).  
B. INTERIOR LATEX SEALANT: ASTM C 834, TYPE CP, GRADE NF (BOSTIC CHEM-CALK 600, PECORA AC-20 +, SONNEBORN SONOLAC, OR TREMCO TREMFLEX 834).  
C. JOINT SEALANT BACKING: CYLINDRICAL, ASTM C 1330, TYPE C AND POLYETHYLENE BOND-BREAKER TAPE.  
D. MISCELLANEOUS: PRIMER, CLEANERS, AND MASKING TAPE.  
E. INSTALLATION: EXAMINE JOINTS AND PREPARE BY CLEANING, PRIMING WHERE RECOMMENDED, AND MASKING ADJOINING SURFACES. COMPLY WITH MANUFACTURER'S WRITTEN INSTALLATION INSTRUCTIONS AND ASTM C 1193. INSTALL BACKING AND BOND-BREAKERS AND PLACE SEALANTS SO THEY DIRECTLY CONTACT AND FULLY WET SUBSTRATES. TOOL TO PRODUCE SMOOTH, UNIFORM CROSS-SECTIONAL SHAPES AND DEPTHS.

DIVISION 08 - OPENINGS

SECTION 081113 - HOLLOW METAL DOORS AND FRAMES

- A. REFER TO ACCOMPANYING PROJECT MANUAL.

SECTION 081416 - FLUSH WOOD DOORS

1. DOORS (GENERAL): COMPLY WITH AII "ARCHITECTURAL WOODWORK QUALITY STANDARD".  
A. MANUFACTURERS: ALGOMA, EGGERs, GRAHAM, OR OSHKOSH.  
B. WARRANTY PERIOD: LIFE OF INSTALLATION. (FACTORY FIT DOORS.)  
C. PARTICLEBOARD CORE DOORS, ANSI A208.1, GRADE LD-2 OR M-2 WITH WOOD BLOCKING.  
D. CONSTRUCTION: 5 OR 7 PLYS; FACES BONDED TO CORE.  
E. FABRICATION: MACHINE FOR HARDWARE (FACTORY FITTED).  
2. DOORS FOR TRANSPARENT FINISH:  
A. GRADE: PREMIUM, WITH GRADE AA FACE (PREMIUM, WITH GRADE A FACES).  
B. SPECIES AND CUT: RED OAK, PLAIN SLICED.  
C. EXPOSED EDGES: SAME SPECIES AS FACES.  
D. FACTORY TRANSPARENT FINISH: PREMIUM GRADE, AII TR-4 CONVERSION VARNISH FINISH SYSTEM, SATIN SHEEN, AND (STAINED TO MATCH EXISTING).  
3. INSTALLATION: IN ACCORDANCE WITH MANUFACTURER'S WRITTEN INSTRUCTIONS AND THE REFERENCED QUALITY STANDARD. ALIGN AND FIT IN FRAMES WITH UNIFORM CLEARANCES OF 1/8" (1/4" AT THRESHOLDS). SEAL CUT SURFACES OF JOB-FITTED DOORS. REHANG OR REPLACE DOORS THAT DO NOT SWING OR OPERATE FREELY. REPLACE DAMAGED FINISHED DOORS.

SECTION 087100 - DOOR HARDWARE

1. REFER TO ACCOMPANYING PROJECT MANUAL.



ISSUE		
NO.	DATE	DESCRIPTION
01/22/2026 FOR CONSTRUCTION		

SPECIFICATIONS	
DATE	01/22/2026
JOB NO.	4325.00
DRAWN	SEP
CHECKED	RFW
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TITLE	
SPECIFICATIONS	
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| A | <div> <div>DIVISION 09 - FINISHES</div> <div>SECTION 09 2216 - NON-STRUCTURAL METAL FRAMING</div> <div> <div>1. FRAMING MEMBERS, GENERAL: COMPLY WITH ASTM C 754 FOR CONDITIONS INDICATED.</div> <div> <div>A. STEEL SHEET COMPONENTS: ASTM C 645.</div> <div>B. PROTECTIVE COATING: ASTM A 653/A 653M G40, HOT-DIP GALVANIZED.</div> </div> <div>2. SUSPENSION SYSTEM COMPONENTS:</div> <div> <div>A. TIE WIRE: ASTM A 641/A, CLASS 1, ZINC COATING, 0.0625".</div> <div>B. WIRE HANGERS: ASTM A 641/A, CLASS 1, ZINC COATING, 0.162".</div> <div>C. CARRYING CHANNELS: COLD-ROLLED, STEEL SHEET, 0.0538" WITH MINIMUM 1/2" FLANGES.</div> <div>D. FURRING CHANNELS: COLD-ROLLED, STEEL SHEET, 0.0538" WITH MINIMUM 1/2" FLANGES, 3/4" DEEP.</div> <div>E. HAT-SHAPED RIGID FURRING CHANNELS: ASTM C 645, 7/8".</div> </div> <div>3. STEEL FRAMING FOR FRAMED ASSEMBLIES:</div> <div> <div>A. STEEL STUDS AND RUNNERS: ASTM C 645, (0.0312, 20 GAUGE), (1-5/8" AND 6") DEPTH (AND SLIP TYPE HEAD JOINTS).</div> <div>B. RESILIENT FURRING CHANNELS: 1/2" DEEP, ASYMMETRICAL.</div> <div>C. COLD-ROLLED FURRING CHANNELS: 0.053", WITH 1/2" FLANGES AND 3/4" DEEP (UNLESS OTHERWISE INDICATED).</div> </div> <div>4. INSTALLATION STANDARD: ASTM C 754 AND (ASTM C 840 FOR GYPSUM BOARD ASSEMBLIES). INSTALL FRAMING AND BLOCKING TO SUPPORT FIXTURES, EQUIPMENT SERVICES, GRAB BARS, TOILET ACCESSORIES, OR SIMILAR CONSTRUCTION. INSTALL STUDS AT 16" O.C.</div> </div> </div> <div> <div>SECTION 09 2900 - GYPSUM BOARD</div> <div> <div>1. INTERIOR GYPSUM BOARD: ASTM A 36.</div> <div> <div>A. TYPICAL CONDITIONS: 5/8" TYPE X.</div> <div>B. WET WALLS: 5/8" TYPE X, MOISTURE AND MOLD RESISTANT.</div> <div>C. FIRE WALLS: 5/8" TYPE C.</div> </div> <div>2. AUXILIARY MATERIALS:</div> <div> <div>A. JOINT TREATMENT: JOINT TAPE AND COMPOUND FOR APPROPRIATE MATERIALS &amp; APPLICATION.</div> <div>B. TRIM ACCESSORIES: CONTROL JOINTS, CORNER BEADS,BULLNOSE BEADS, AND EDGE BEADS.</div> <div>C. FASTENERS: STEEL DRILL SCREWS, ASTM C 100 (LAMINATING ADHESIVE FOR DIRECT ADHERENCE).</div> <div>D. SOUND ATTENUATION BLANKETS: (2') ASTM C 665, TYPE I.</div> </div> <div>3. APPLICATION AND FINISH: COMPLY WITH ASTM C 840. (SINGLE-LAYER) APPLICATION WITH EDGE AND END JOINTS OVER SUPPORTS AND VERTICAL JOINTS STAGGERED ON OPPOSITE SIDES OF PARTITIONS. ATTACH TRIM ACCORDING TO MANUFACTURER'S WRITTEN INSTRUCTIONS. FINISH BOARD IN CONCEALED AREAS TO LEVEL 1 AND TO LEVEL 4 IN EXPOSED AREAS.</div> </div> </div> <div> <div>SECTION 09 3013 - CERAMIC TILING</div> <div> <div>1. TILE PRODUCTS</div> <div> <div>A. TILE TYPE (PT-1): COLORBODY PORCELAIN TILE FOR FLOORS.</div> <div> <div>a. MANUFACTURERS: AS INDICATED ON THE MATERIAL LEGEND ON THE DRAWINGS.</div> <div>B. COMPOSITION: PORCELAIN.</div> <div>C. FACE SIZE: 12" X 24".</div> <div>D. FACE: PATTERN OF DESIGN INDICATED, WITH SQUARE EDGES.</div> <div>E. SURFACE: SLIP-RESISTANT.</div> <div>F. TILE COLOR, PATTERN, AND FINISH: AS INDICATED ON THE MATERIAL LEGEND ON THE DRAWINGS.</div> <div>G. GROUT COLOR: AS SELECTED BY ARCHITECT FROM MANUFACTURER'S FULL RANGE.</div> </div> <div>B. TILE TYPE (PT-2, PWT-1): COLORBODY PORCELAIN TILE FOR FLOORS AND WALLS.</div> <div> <div>a. MANUFACTURERS: AS INDICATED ON THE MATERIAL LEGEND ON THE DRAWINGS.</div> <div>B. COMPOSITION: PORCELAIN.</div> <div>C. FACE SIZE: 12" X 12".</div> <div>D. FACE: PATTERN OF DESIGN INDICATED, WITH SQUARE EDGES.</div> <div>E. SURFACE: SLIP-RESISTANT.</div> <div>F. TILE COLOR, PATTERN, AND FINISH: AS INDICATED ON THE MATERIAL LEGEND ON THE DRAWINGS.</div> <div>g. GROUT COLOR: AS SELECTED BY ARCHITECT FROM MANUFACTURER'S FULL RANGE.</div> </div> <div>C. TILE TYPE (PT-3, PWT-2): COLORBODY PORCELAIN TILE FOR FLOORS AND WALLS.</div> <div> <div>a. MANUFACTURERS: AS INDICATED ON THE MATERIAL LEGEND ON THE DRAWINGS.</div> <div>B. COMPOSITION: PORCELAIN.</div> <div>C. FACE SIZE: MOSAIC TILES ON 12" X 12" SHEET.</div> <div>D. FACE: PATTERN OF DESIGN INDICATED, WITH SQUARE EDGES.</div> <div>E. SURFACE: SLIP-RESISTANT.</div> <div>F. TILE COLOR, PATTERN, AND FINISH: AS INDICATED ON THE MATERIAL LEGEND ON THE DRAWINGS.</div> <div>g. GROUT COLOR: AS SELECTED BY ARCHITECT FROM MANUFACTURER'S FULL RANGE.</div> </div> <div>D. TILE TYPE (PTWB): COLORBODY PORCELAIN TILE FOR FLOORS AND WALLS.</div> <div> <div>a. MANUFACTURERS: AS INDICATED ON THE MATERIAL LEGEND ON THE DRAWINGS.</div> <div>B. COMPOSITION: PORCELAIN.</div> <div>C. FACE SIZE: 6" X 12".</div> <div>D. FACE: PATTERN OF DESIGN INDICATED, WITH SQUARE EDGES.</div> <div>E. SURFACE: SLIP-RESISTANT.</div> <div>F. TILE COLOR, PATTERN, AND FINISH: AS INDICATED ON THE MATERIAL LEGEND ON THE DRAWINGS.</div> <div>g. GROUT COLOR: AS SELECTED BY ARCHITECT FROM MANUFACTURER'S FULL RANGE.</div> </div> </div> </div> </div> <div> <div>2. OTHER MATERIALS:</div> <div> <div>A. SETTING AND GROUTING MATERIALS: LARGE FORMAT, THIN-SET MORTAR; POLYMER-MODIFIED MORTAR, MAPEI KERAFLEX PLUS, READY-TO-USE SPECIALTY GROUT, WITH COLOR-COATED QUARTZ AGGREGATE, MAPEI FLEXCOLOR CQ.</div> <div>B. ELASTOMERIC SEALANTS: (ONE-PART, MILDEW-RESISTANT SILICONE SEALANT ASTM C 290, TYPE S, GRADE NS, CLASS 25 (DOW 786 OR PECORA 898)).</div> <div>C. CEMENTITIOUS BACKER UNITS: (1/2") THICK, ANSI A118.9 (USG DUROCK OR G-P DENS-SHIELD).</div> <div>D. WATERPROOFING MEMBRANE: NONE REQUIRED.</div> <div>E. METAL EDGE STRIPS: ANGLE OR L-SHAPE, HEIGHT TO MATCH TILE AND SETTING-BED THICKNESS, METALLIC OR COMBINATION OF METAL AND PVC OR NEOPRENE BASE, DESIGNED SPECIFICALLY FOR FLOORING APPLICATIONS; EXPOSED-EDGE MATERIAL.</div> <div>F. MANUFACTURER: SUBJECT TO COMPLIANCE WITH REQUIREMENTS, PROVIDE THE FOLLOWING:</div> <div> <div>1. SCHLUTER.</div> <div>B. STYLE: SCHIENE, SATIN ANODIZED ALUMINUM.</div> <div>2. ADA COMPLIANT</div> </div> <div>G. TILE CLEANER: A NEUTRAL CLEANER CAPABLE OF REMOVING SOIL AND RESIDUE WITHOUT HARMING TILE AND GROUT SURFACES, SPECIFICALLY APPROVED FOR MATERIALS AND INSTALLATIONS INDICATED BY TILE AND GROUT MANUFACTURERS.</div> </div> <div>3. INSTALLATION:</div> <div> <div>A. COMPLY WITH APPLICABLE PARTS OF ANSI A108 SERIES "SPECIFICATIONS FOR INSTALLATION OF CERAMIC TILE AND TCAS" "HANDBOOK FOR CERAMIC TILE INSTALLATION" PROVIDE EXPANSION, CONTROL, AND ISOLATION JOINTS.</div> <div> <div>a. INTERIOR FLOOR INSTALLATION ON CONCRETE: THIN-SET SETTING MORTAR AND GROUT DESIGNED FOR LARGE FORMAT TILE.</div> <div>b. WALL TILE INSTALLATION: THIN-SET, ORGANIC ADHESIVE, ANSI A108.4.</div> </div> <div>B. PREINSTALLATION MEETING REQUIRED PRIOR TO TILE INSTALLATION.</div> <div>4. CLEANING AND PROTECTING</div> <div> <div>A. CLEANING: ON COMPLETION OF PLACEMENT AND GROUTING, CLEAN ALL CERAMIC TILE SURFACES SO THEY ARE FREE OF FOREIGN MATTER.</div> <div> <div>a. REMOVE GROUT RESIDUE FROM TILE AS SOON AS POSSIBLE</div> <div>b. CLEAN GROUT SMEARS AND HAZE FROM TILE ACCORDING TO TILE AND GROUT MANUFACTURER'S WRITTEN INSTRUCTIONS. USE ONLY CLEANERS RECOMMENDED BY TILE AND GROUT MANUFACTURERS AND ONLY AFTER DETERMINING THAT CLEANERS ARE SAFE TO USE BY TESTING ON SAMPLES OF TILE AND OTHER SURFACES TO BE CLEANED. PROTECT METAL SURFACES AND PLUMBING FIXTURES FROM EFFECTS OF CLEANING. FLUSH SURFACES WITH CLEAN WATER BEFORE AND AFTER CLEANING.</div> </div> <div>B. WHEN RECOMMENDED BY TILE MANUFACTURER, APPLY COAT OF NEUTRAL PROTECTIVE CLEANER TO COMPLETED TILE WALLS AND FLOORS. PROTECT INSTALLED TILE WORK WITH KRAFT PAPER OR OTHER HEAVY COVERING DURING CONSTRUCTION PERIOD TO PREVENT STAINING, DAMAGE, AND WEAR.</div> <div>C. PROHIBIT FOOT AND WHEEL TRAFFIC FROM TILED FLOORS FOR AT LEAST SEVEN DAYS AFTER GROUTING IS COMPLETED.</div> <div>D. BEFORE FINAL INSPECTION, REMOVE PROTECTIVE COVERINGS AND RINSE NEUTRAL CLEANER FROM TILE SURFACES.</div> </div> </div> <div> <div>SECTION 09 5113 - ACOUSTICAL PANEL CEILINGS</div> <div> <div>1. ACOUSTICAL PANELS: CLASS A, (WET-FORMED MINERAL FIBER) COMPLYING WITH ASTM E 1284 CLASSIFICATIONS FOR TYPES, PATTERNS, ACOUSTICAL RATINGS AND LIGHT REFLECTANCE.</div> <div> <div>A. ACOUSTICAL PANEL: 24" X 24" X 3/4".</div> <div>B. ACOUSTICAL PANEL: 24" X 48" X 3/4".</div> <div>C. REFER TO MATERIAL LEGEND FOR MANUFACTURER AND MODEL.</div> </div> <div>2. METAL SUSPENSION SYSTEM: WIDE-FACE, CAPPED, DOUBLE-WEB, STEEL, INTERMEDIATE-DUTY, WITH PAINTED WHITE ALUMINUM CAP AND COMPLYING WITH ASTM A 653. (MANUFACTURERS: ARMSTRONG, CHICAGO METALLIC, AND USG.)</div> <div>3. METAL EDGE MOLDINGS AND TRIM: ROLL-FORMED SHEET-METAL, OF SAME MATERIAL, FINISH , AND COLOR AS GRID.</div> <div>4. INSTALL TO COMPLY WITH ASTM C 636, PER MANUFACTURER'S WRITTEN INSTRUCTIONS, AND OISCA'S "CEILING SYSTEM HANDBOOK", SUPPORT LIGHT FIXTURES AT FOUR CORNERS WITH WIRE HANGERS.</div> </div> </div> <div> <div>SECTION 09 6513 - RESILIENT WALL BASE AND ACCESSORIES</div> <div> <div>1. RESILIENT WALL BASE:</div> <div> <div>A. ASTM F 1861, TYPE (TS), GROUP (I), COVE STYLE, WITH (PRE-FORMED OUTSIDE CORNERS).</div> <div>B. THERMOSET RUBBER WALL BASE - 6".</div> </div> <div>2. PREPARE AND INSTALL COMPLYING WITH MANUFACTURER'S WRITTEN INSTRUCTIONS TO ENSURE ADHESION.</div> </div> </div> <div> <div>SECTION 10 2800 - TOILET, BATH, AND LAUNDRY ACCESSORIES</div> <div> <div>1. SUMMARY</div> <div> <div>A. SECTION INCLUDES:</div> <div> <div>A. PUBLIC-USE WASHROOM ACCESSORIES.</div> <div>B. OWNER-FURNISHED MATERIAL:</div> <div> <div>A. REFER TO DRAWINGS.</div> </div> </div> </div> <div>2. ACTION SUBMITTALS</div> <div> <div>A. 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IDENTIFY PRODUCTS USING DESIGNATIONS INDICATED.</div> </div> </div> <div>3. CLOSEOUT SUBMITTALS</div> <div> <div>A. MAINTENANCE DATA: FOR TOILET AND BATH ACCESSORIES TO INCLUDE IN MAINTENANCE MANUALS.</div> </div> <div>4. QUALITY ASSURANCE</div> <div> <div>A. SOURCE LIMITATIONS: FOR PRODUCTS LISTED TOGETHER IN THE SAME PART 2 ARTICLES, OBTAIN PRODUCTS FROM SINGLE SOURCE FROM SINGLE MANUFACTURER.</div> </div> <div>5. COORDINATION</div> <div> <div>A. COORDINATE ACCESSORY LOCATIONS WITH OTHER WORK TO PREVENT INTERFERENCE WITH CLEARANCES REQUIRED FOR ACCESS BY PEOPLE WITH DISABILITIES, AND FOR PROPER INSTALLATION, ADJUSTMENT, OPERATION, CLEANING, AND SERVICING OF ACCESSORIES.</div> <div>B. DELIVER INSERTS AND ANCHORING DEVICES SET INTO CONCRETE OR MASONRY AS REQUIRED TO PREVENT DELAYING THE WORK.</div> </div> <div>6. PRODUCT MATERIALS</div> <div> <div>A. STAINLESS STEEL: ASTM A 666, TYPE 304, 0.031-INCH (0.8-MM) MINIMUM NOMINAL THICKNESS UNLESS OTHERWISE INDICATED.</div> <div>B. 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BRADLEY CORPORATION.</div> <div>D. GEORGIA PACIFIC</div> </div> <div>B. T01 - LIQUID SOAP DISPENSER</div> <div> <div>A. DIAL FIT UNIVERSAL TOUCH FREE DISPENSER SLATE-IL. CASE UPC, 17000166261.</div> </div> <div>C. T02 - PAPER TOWEL DISPENSER</div> <div> <div>a. EMOTION 10 AUTOMATED PAPER TOWEL DISPENSER BY GEORGIA PACIFIC.</div> </div> <div>D. T03 - MIRROR WITH FRAME:</div> <div> <div>A. BASIS-OF-DESIGN PRODUCT: BOBRICK, B-165 SERIES.</div> <div>B. FRAME: TYPE-430 STAINLESS STEEL, 1/2" X 1/2" X 3/8" (13 X 13 X 9.5MM) CHANNEL WITH 1/4" (6MM) RETURN AT REAR FOR SNAP LOCK-ING DESIGN; 1/2" X 1/2" X 1/2" (13 X 13 X 13MM) CHANNEL FOR LOCK TAB DESIGN, WITH BRIGHT POLISHED FINISH.</div> <div> <div>a. CORNERS: MANUFACTURER'S STANDARD.</div> <div>b. MIRROR: 1/4" (6MM) SELECT FLOAT GLASS.</div> <div>c. MOUNTING: CONCEALED WALL HANGER, 16 GAUGE COLD ROLL STEEL CONSTRUCTION. INCORPORATES UPPER AND LOWER SUPPORT MEMBERS, WHICH ENGAGE BACKPLATE LOUVERS TO KEEP MIRROR AGAINST WALL.</div> <div>e. SIZE: 24 X 36 INCHES.</div> </div> </div> <div>E. T04 - TOILET TISSUE DISPENSER</div> <div> <div>a. OWNER FURNISHED CONTRACTOR INSTALLED.</div> <div>b. EXISTING, TO BE SALVAGED AND REUSED.</div> </div> </div> </div> <div> <div>G. T06 - GRAB BARS:</div> <div> <div>A. BASIS-OF-DESIGN PRODUCT: BOBRICK, B-6806 SERIES.</div> <div>B. CONFIGURATION: AS INDICATED ON DRAWINGS.</div> <div>C. LENGTH:</div> <div> <div>1. (1) @ 18" VERTICAL BAR</div> <div>2. (1) @ 36" HORIZONTAL BAR</div> <div>3. (1) @ 42" HORIZONTAL BAR</div> </div> <div>D. MOUNTING: FLANGES WITH CONCEALED FASTENERS.</div> <div>E. MATERIAL: STAINLESS STEEL, 0.05 INCH (1.3 MM) THICK.</div> <div> <div>1. FINISH: SMOOTH, NO. 4 FINISH (SATIN) ON ENDS AND SLIP-RESISTANT TEXTURE IN GRIP AREA.</div> <div>2. OUTSIDE DIAMETER: 1-1/2 INCHES (38 MM).</div> </div> </div> <div>H. T08 - WASTE RECEPTACLE</div> <div> <div>A. BASIS-OF-DESIGN: BOBRICK, B-3644.</div> <div> <div>b. RECESSED WASTE RECEPTACLE SHALL BE TYPE-304 STAINLESS STEEL WITH ALL-WELDED CONSTRUCTION; EXPOSED SURFACES SHALL HAVE SATIN FINISH. FLANGE SHALL BE DRAWN AND BEVELED, ONE-PIECE, SEAMLESS CONSTRUCTION. REMOVABLE WASTE RECEPTACLE SHALL BE SECURED TO CABINET WITH A TUMBLER LOCK, HAVE FRONT AND SIDE EDGES OF BOTTOM AND ALL TOP EDGES HEMMED FOR SAFE HANDLING, AND SHALL HAVE A MINIMUM CAPACITY OF 12-GAL. (45.4-L).</div> </div> <div>C. INCLUDE LINERMATE 3944-134.</div> <div>D. BOBRICK B-277 FOR STORM SHELTER (118).</div> </div> <div>I. T09 - WALL STOP</div> <div> <div>A. BASIS OF DESIGN: ROCKWOOD, 430-RKW</div> <div>B. CONVEX SOLID CAST WALL STOP WITH US32D FINISH.</div> </div> <div>1. INSTALLATION</div> <div> <div>A. INSTALL ACCESSORIES ACCORDING TO MANUFACTURERS' WRITTEN INSTRUCTIONS, USING FASTENERS APPROPRIATE TO SUBSTRATE INDICATED AND RECOMMENDED BY UNIT MANUFACTURER. INSTALL UNITS LEVEL, PLUMB, AND FIRMLY ANCHORED IN LOCATIONS AND AT HEIGHTS INDICATED.</div> <div>B. GRAB BARS: INSTALL TO WITHSTAND A DOWNWARD LOAD OF AT LEAST 250 LBF (112 N), WHEN TESTED ACCORDING TO ASTM F 446.</div> </div> <div>2. ADJUSTING AND CLEANING</div> <div> <div>A. ADJUST ACCESSORIES FOR UNENCUMBERED, SMOOTH OPERATION. REPLACE DAMAGED OR DEFECTIVE ITEMS.</div> <div>B. REMOVE TEMPORARY LABELS AND PROTECTIVE COATINGS.</div> <div>C. CLEAN AND POLISH EXPOSED SURFACES ACCORDING TO MANUFACTURER'S WRITTEN RECOMMENDATIONS.</div> </div> <div>*****</div> <div>END OF ARCHITECTURAL SPECIFICATIONS</div> </div> <tr> <td>B</td><td> <div> <div>SECTION 09 5113 - ACOUSTICAL PANEL CEILINGS</div> <div> <div>1. ACOUSTICAL PANELS: CLASS A, (WET-FORMED MINERAL FIBER) COMPLYING WITH ASTM E 1284 CLASSIFICATIONS FOR TYPES, PATTERNS, ACOUSTICAL RATINGS AND LIGHT REFLECTANCE.</div> <div> <div>A. ACOUSTICAL PANEL: 24" X 24" X 3/4".</div> <div>B. ACOUSTICAL PANEL: 24" X 48" X 3/4".</div> <div>C. REFER TO MATERIAL LEGEND FOR MANUFACTURER AND MODEL.</div> </div> <div>2. 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SOURCE LIMITATIONS: FOR PRODUCTS LISTED TOGETHER IN THE SAME PART 2 ARTICLES, OBTAIN PRODUCTS FROM SINGLE SOURCE FROM SINGLE MANUFACTURER.</div> </div> <div>5. COORDINATION</div> <div> <div>A. COORDINATE ACCESSORY LOCATIONS WITH OTHER WORK TO PREVENT INTERFERENCE WITH CLEARANCES REQUIRED FOR ACCESS BY PEOPLE WITH DISABILITIES, AND FOR PROPER INSTALLATION, ADJUSTMENT, OPERATION, CLEANING, AND SERVICING OF ACCESSORIES.</div> <div>B. DELIVER INSERTS AND ANCHORING DEVICES SET INTO CONCRETE OR MASONRY AS REQUIRED TO PREVENT DELAYING THE WORK.</div> </div> <div>6. PRODUCT MATERIALS</div> <div> <div>A. STAINLESS STEEL: ASTM A 666, TYPE 304, 0.031-INCH (0.8-MM) MINIMUM NOMINAL THICKNESS UNLESS OTHERWISE INDICATED.</div> <div>B. STEEL SHEET: ASTM A 1008/A 1008M, DESIGNATION CS (COLD ROLLED, COMMERCIAL STEEL), 0.036-INCH (0.9-MM) MINIMUM NOMINAL THICKNESS.</div> <div>C. GALVANIZED-STEEL SHEET: ASTM A 653/A 653M, WITH G60 (Z180) HOT-DIP ZINC COATING.</div> <div>D. GALVANIZED-STEEL MOUNTING DEVICES: ASTM A 153/A 153M, HOT-DIP GALVANIZED AFTER FABRICATION.</div> <div>E. FASTENERS: SCREWS, BOLTS, AND OTHER DEVICES OF SAME MATERIAL AS ACCESSORY UNIT AND TAMPER-AND- THEFT RESISTANT WHERE EXPOSED, AND OF GALVANIZED STEEL WHERE CONCEALED.</div> <div>F. MIRRORS: ASTM C 1503, MIRROR GLAZING QUALITY, CLEAR-GLASS MIRRORS, NOMINAL 6.0 MM THICK.</div> <div> <div>A. ABS PLASTIC: ACRYLONITRILE-BUTADIENE-STYRENE RESIN FORMULATION.</div> </div> </div> <div>7. WASHROOM ACCESSORIES</div> <div> <div>A. SUBJECT TO COMPLIANCE WITH REQUIREMENTS, PROVIDE PRODUCT INDICATED IN PARAGRAPHS BELOW OR COMPARABLE PRODUCT BY ONE OF THE FOLLOWING:</div> <div> <div>A. BOBRICK</div> <div>B. AMERICAN SPECIALTIES, INC.</div> <div>C. BRADLEY CORPORATION.</div> <div>D. GEORGIA PACIFIC</div> </div> <div>B. T01 - LIQUID SOAP DISPENSER</div> <div> <div>A. DIAL FIT UNIVERSAL TOUCH FREE DISPENSER SLATE-IL. CASE UPC, 17000166261.</div> </div> <div>C. T02 - PAPER TOWEL DISPENSER</div> <div> <div>a. EMOTION 10 AUTOMATED PAPER TOWEL DISPENSER BY GEORGIA PACIFIC.</div> </div> <div>D. T03 - MIRROR WITH FRAME:</div> <div> <div>A. BASIS-OF-DESIGN PRODUCT: BOBRICK, B-165 SERIES.</div> <div>B. FRAME: TYPE-430 STAINLESS STEEL, 1/2" X 1/2" X 3/8" (13 X 13 X 9.5MM) CHANNEL WITH 1/4" (6MM) RETURN AT REAR FOR SNAP LOCK-ING DESIGN; 1/2" X 1/2" X 1/2" (13 X 13 X 13MM) CHANNEL FOR LOCK TAB DESIGN, WITH BRIGHT POLISHED FINISH.</div> <div> <div>a. CORNERS: MANUFACTURER'S STANDARD.</div> <div>b. MIRROR: 1/4" (6MM) SELECT FLOAT GLASS.</div> <div>c. MOUNTING: CONCEALED WALL HANGER, 16 GAUGE COLD ROLL STEEL CONSTRUCTION. INCORPORATES UPPER AND LOWER SUPPORT MEMBERS, WHICH ENGAGE BACKPLATE LOUVERS TO KEEP MIRROR AGAINST WALL.</div> <div>e. SIZE: 24 X 36 INCHES.</div> </div> </div> <div>E. T04 - TOILET TISSUE DISPENSER</div> <div> <div>a. OWNER FURNISHED CONTRACTOR INSTALLED.</div> <div>b. EXISTING, TO BE SALVAGED AND REUSED.</div> </div> </div> </div> <div> <div>G. T06 - GRAB BARS:</div> <div> <div>A. BASIS-OF-DESIGN PRODUCT: BOBRICK, B-6806 SERIES.</div> <div>B. CONFIGURATION: AS INDICATED ON DRAWINGS.</div> <div>C. LENGTH:</div> <div> <div>1. (1) @ 18" VERTICAL BAR</div> <div>2. (1) @ 36" HORIZONTAL BAR</div> <div>3. (1) @ 42" HORIZONTAL BAR</div> </div> <div>D. MOUNTING: FLANGES WITH CONCEALED FASTENERS.</div> <div>E. MATERIAL: STAINLESS STEEL, 0.05 INCH (1.3 MM) THICK.</div> <div> <div>1. FINISH: SMOOTH, NO. 4 FINISH (SATIN) ON ENDS AND SLIP-RESISTANT TEXTURE IN GRIP AREA.</div> <div>2. OUTSIDE DIAMETER: 1-1/2 INCHES (38 MM).</div> </div> </div> <div>H. T08 - WASTE RECEPTACLE</div> <div> <div>A. BASIS-OF-DESIGN: BOBRICK, B-3644.</div> <div> <div>b. RECESSED WASTE RECEPTACLE SHALL BE TYPE-304 STAINLESS STEEL WITH ALL-WELDED CONSTRUCTION; EXPOSED SURFACES SHALL HAVE SATIN FINISH. FLANGE SHALL BE DRAWN AND BEVELED, ONE-PIECE, SEAMLESS CONSTRUCTION. 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| D | <div> <div>SECTION 09 5113 - ACOUSTICAL PANEL CEILINGS</div> <div> <div>1. ACOUSTICAL PANELS: CLASS A, (WET-FORMED MINERAL FIBER) COMPLYING WITH ASTM E 1284 CLASSIFICATIONS FOR TYPES, PATTERNS, ACOUSTICAL RATINGS AND LIGHT REFLECTANCE.</div> <div> <div>A. ACOUSTICAL PANEL: 24" X 24" X 3/4".</div> <div>B. ACOUSTICAL PANEL: 24" X 48" X 3/4".</div> <div>C. REFER TO MATERIAL LEGEND FOR MANUFACTURER AND MODEL.</div> </div> <div>2. METAL SUSPENSION SYSTEM: WIDE-FACE, CAPPED, DOUBLE-WEB, STEEL, INTERMEDIATE-DUTY, WITH PAINTED WHITE ALUMINUM CAP AND COMPLYING WITH ASTM A 653. (MANUFACTURERS: ARMSTRONG, CHICAGO METALLIC, AND USG.)</div> <div>3. METAL EDGE MOLDINGS AND TRIM: ROLL-FORMED SHEET-METAL, OF SAME MATERIAL, FINISH , AND COLOR AS GRID.</div> <div>4. INSTALL TO COMPLY WITH ASTM C 636, PER MANUFACTURER'S WRITTEN INSTRUCTIONS, AND OISCA'S "CEILING SYSTEM HANDBOOK", SUPPORT LIGHT FIXTURES AT FOUR CORNERS WITH WIRE HANGERS.</div> </div> </div> <div> <div>SECTION 09 6513 - RESILIENT WALL BASE AND ACCESSORIES</div> <div> <div>1. RESILIENT WALL BASE:</div> <div> <div>A. ASTM F 1861, TYPE (TS), GROUP (I), COVE STYLE, WITH (PRE-FORMED OUTSIDE CORNERS).</div> <div>B. THERMOSET RUBBER WALL BASE - 6".</div> </div> <div>2. PREPARE AND INSTALL COMPLYING WITH MANUFACTURER'S WRITTEN INSTRUCTIONS TO ENSURE ADHESION.</div> </div> </div> <div> <div>SECTION 10 2800 - TOILET, BATH, AND LAUNDRY ACCESSORIES</div> <div> <div>1. SUMMARY</div> <div> <div>A. SECTION INCLUDES:</div> <div> <div>A. PUBLIC-USE WASHROOM ACCESSORIES.</div> <div>B. OWNER-FURNISHED MATERIAL:</div> <div> <div>A. REFER TO DRAWINGS.</div> </div> </div> </div> <div>2. ACTION SUBMITTALS</div> <div> <div>A. PRODUCT DATA: FOR EACH TYPE OF PRODUCT INDICATED, INCLUDE THE FOLLOWING:</div> <div> <div>A. CONSTRUCTION DETAILS AND DIMENSIONS.</div> <div>B. ANCHORING AND MOUNTING REQUIREMENTS, INCLUDING REQUIREMENTS FOR CUTOUTS IN OTHER WORK AND SUBSTRATE PREPARATION.</div> <div>C. MATERIAL AND FINISH DESCRIPTIONS.</div> <div>D. FEATURES THAT WILL BE INCLUDED FOR PROJECT.</div> <div>E. MANUFACTURER'S WARRANTY.</div> </div> <div>B. PRODUCT SCHEDULE: INDICATING TYPES, QUANTITIES, SIZES, AND INSTALLATION LOCATIONS BY ROOM OF EACH ACCESSORY REQUIRED.</div> <div> <div>A. IDENTIFY LOCATIONS USING ROOM DESIGNATIONS IND</div></div></div></div></div>   
   
   
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Expiration Date 12/31/2027


Harrison Township District 10

Sheriff Substation Renovation

6001 N Dixie Dr, Dayton, OH 45414

ISSUE		
NO.	DATE	DESCRIPTION
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E1 PHASING PLAN  
1/8" = 1'-0"

## CONSTRUCTION NOTES

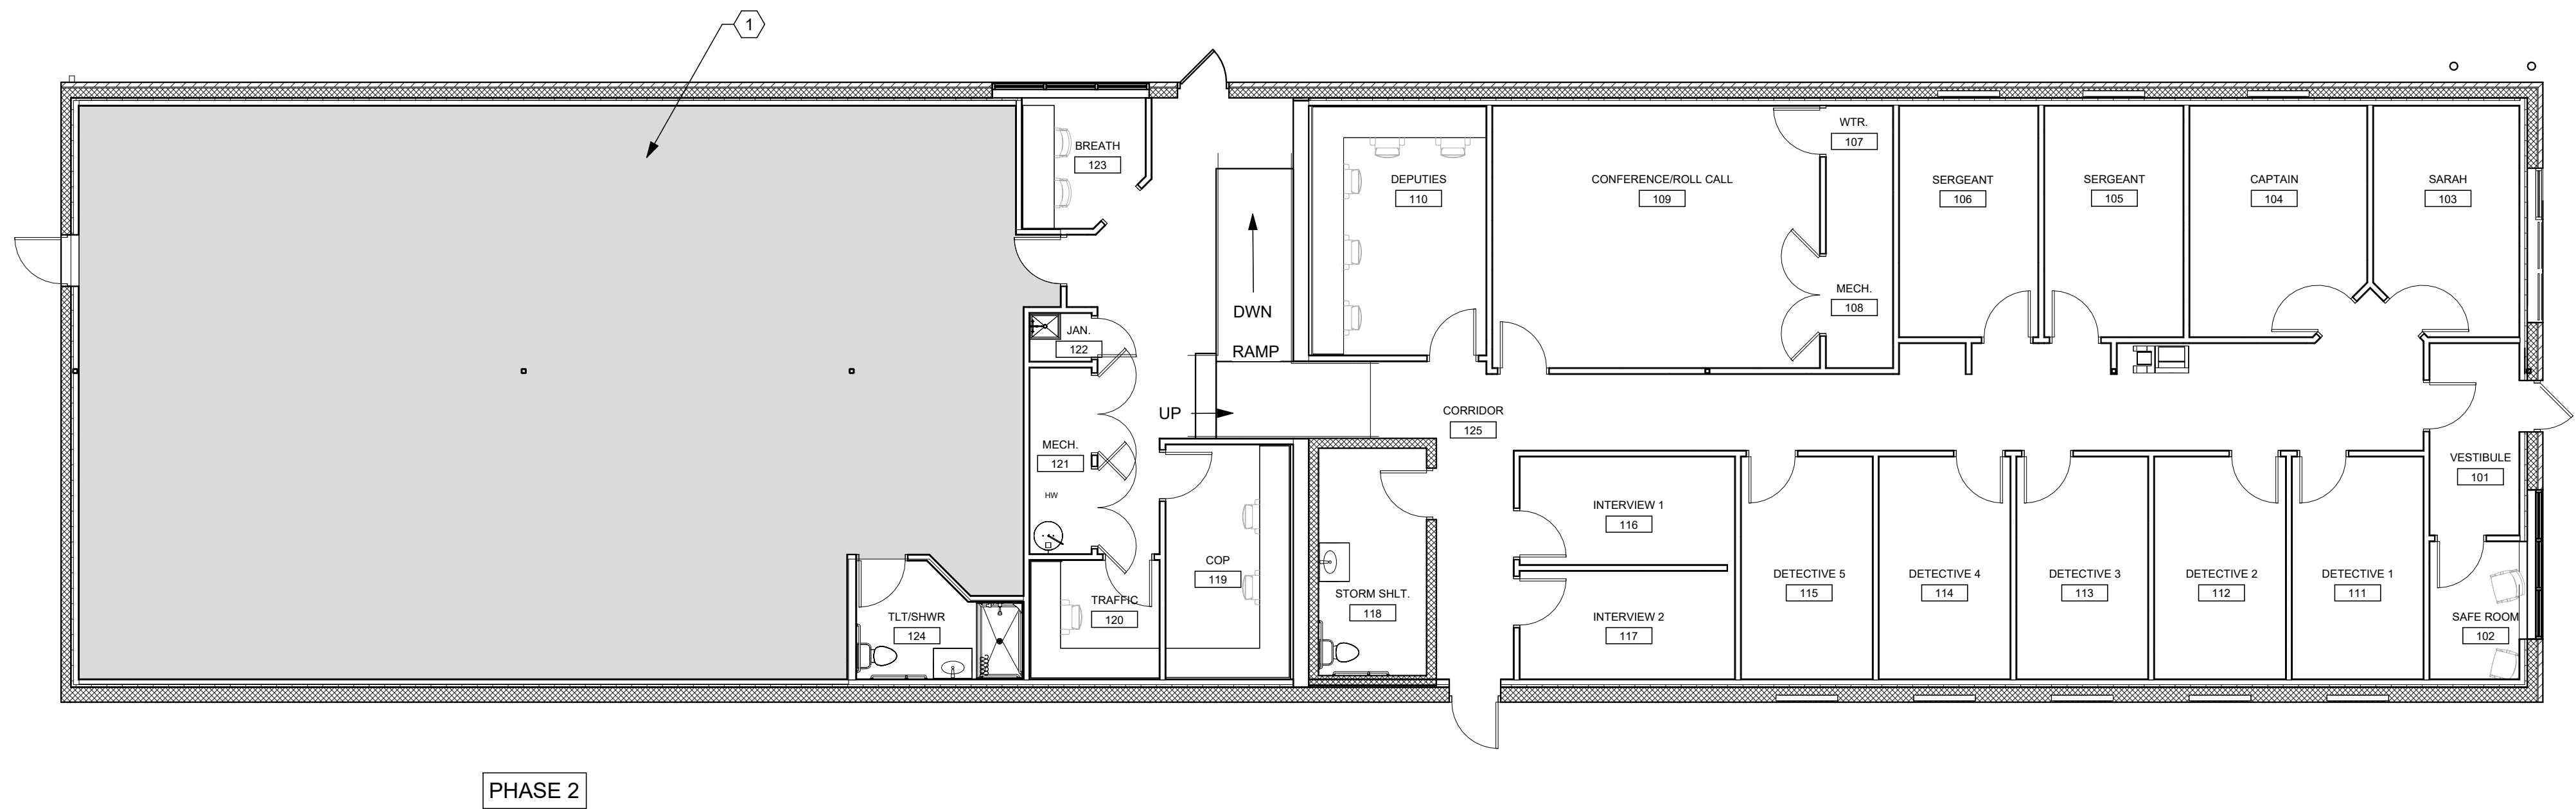(00) INDICATES CONSTRUCTION NOTE.


- 1 PHASE ONE CONSTRUCTION TO CREATE "TRUE SHELL". FLOORS TO BE FINISHED. EGRESS DOOR 140B TO BE INSTALLED. EXTERIOR WALLS TO BE COMPLETED EXCEPT FOR FINISH FACE GYPSUM BOARD.

## GENERAL NOTES

- THIS SHEET CONTAINS A GENERAL OVERVIEW OF A PHASING PLAN SCOPE.  
PHASE 1: COMPLETE ENTIRE PROJECT BOTH EAST AND WEST OF THE FLOOR PLAN.  
PHASE 2: SHADED AREA SHOULD NOT TO BE COMPLETED WITH EXCEPTION OF STRUCTURAL REINFORCING (INCLUDING STUDS AND INSULATION), CONCRETE SLAB REPAIR, HVAC TRUNKS, AND NEW EGRESS DOOR 140B.
- REFER TO MEP DRAWINGS FOR ADDITIONAL PHASING NOTES.

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## Harrison Township District 10 Sheriff Substation Renovation

6001 N Dixie Dr, Dayton, OH 45414
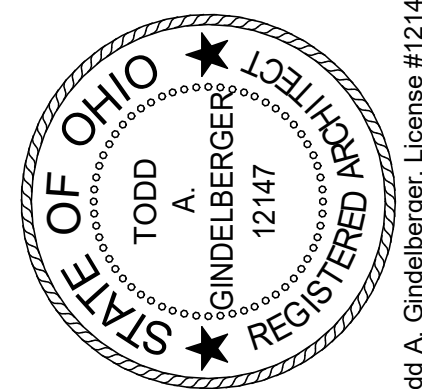
### ISSUE

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TITLE  
**PHASING**

SHEET NO.

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C

## D

## E

## F

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## BUILDING/DETAIL SECTION

## EXTERIOR ELEVATIONS

## MATERIAL SYMBOLS IN SECTION

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## PLAN SYMBOLS

## ELEVATION SYMBOLS

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RECESSED LIGHT FIXTURES

## FIRE BARRIER LEGEND

NO.	DATE	DESCRIPTION
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MATERIAL LEGEND								
SORT MATERIAL	ITEM	MATERIAL	MANUFACTURER	MATERIAL MODEL NO.	CONTACT INFO	COLOR	FLAME / SMOKE	REMARKS
BASE								
BASE	PTWB-1	CERAMIC TILE WALL BASE 6"	CROSSVILLE	NVM02.10612CBS (6"x12")	MICEALA CARNEVALE-WETZEL, 512.500.5135 (m)	NICKLE PLATE		1
BASE	RB-1	RUBBER BASE	FLEXCO	COVERED RUBBER BASE, 4"x120"-0"	ROD SEABOLT, 513.560.1040 (m)	01, BLACK DAHLIA	CLASS A, ≤ 450	
BASE	RB-2	RUBBER BASE	FLEXCO	COVERED RUBBER BASE, 6"x120"-0"	ROD SEABOLT, 513.560.1040 (m)	01, BLACK DAHLIA	CLASS A, ≤ 450	2
CABINETS								
CABINETS	PL-1	PLASTIC LAMINATE	WILSONART	7949K-18, FINISH 18 -LINEARITY	KATIE MASON, 614.971.9636 (m)	ASIAN NIGHT	CLASS B	
CABINETS	PL-2	PLASTIC LAMINATE	WILSONART	4990-38	KATIE MASON, 614.971.9636 (m)	FLAX LINEN		3
CABINETS	SSM-1	SOLID SURFACE	LX HAUSYS	LO16	MICHELLE ALLEN 513.214.9939(m)	LUSTRE	CLASS A	
CABINETS	SSM-2	SOLID SURFACE	LX HAUSYS	GT909	MICHELLE ALLEN 513.214.9939(m)	ARMADILLO	CLASS A	4
CABINETS	SSM-3	SOLID SURFACE	LX HAUSYS	OVVAL ADA BOWL, MODEL 1613	MICHELLE ALLEN 513.214.9939(m)	ARCTIC WHITE		
CEILING								
CEILING	APC-1	ACOUSTIC PANEL CEILING	ARMSTRONG	MESA 686, 24"x24"	JEN McCOY, 513.919.2263 (m)	WHITE	CLASS A	
CEILING	APC-2	ACOUSTIC PANEL CEILING	ARMSTRONG	MESA 684, 24"x48"	JEN McCOY, 513.919.2263 (m)	WHITE	CLASS A	
CEILING	GYB / P-1	GYPSUM BOARD PAINTED	SHERWIN WILLIAMS	SW 7007	KAREN McILWAIN, 317.714.5610 (m)	CEILING BRIGHT WHITE		
DOORS								
DOORS	DEP-1	DOOR & FRAME PAINT	SHERWIN WILLIAMS	SW 6258	KAREN McILWAIN, 317.714.5610 (m)	TRICORN BLACK		
FLOOR								
FLOOR	C-1	CARPET (TILES)	TARKETT	MEALSTROM, 04849, 24"x24", ETHOS MODULAR	GREG WELDON, 513.909.9033 (m)	33212, TERRA FIRMA	CLASS 1,≤ 450	5,6
FLOOR	MAT-1	WALK-OFF MAT	SHAW CONTRACT	51103, WELCOME II TILE, 24"x24"	THERESA SCHNIDER, 513.581.0321 (m)	CHARCOAL, 31549	CLASS 1,≤ 450	5
FLOOR	MCT-1	MCT (MARMOLEUM COMPOSITION TILE)	FORBO	MCT-3048	KEVIN SHORT, 440.715.3327 (m)	GRAPHITE	CLASS 1,≤ 450	5,6,8
FLOOR	MCT-2	MCT (MARMOLEUM COMPOSITION TILE)	FORBO	MCT-629	KEVIN SHORT, 440.715.3327 (m)	EIGER	CLASS 1,≤ 450	7
FLOOR	PC-1	POLISHED CONCRETE						
FLOOR	PT-1	PORCELAIN TILE (FLOOR)	CROSSVILLE	NVM02. 12"x24"	MICEALA CARNEVALE-WETZEL, 512.500.5135 (m)	NICKLE PLATE		8,9
FLOOR	SC-1	SEALED CONCRETE						
SPECIALTY								
SPECIALTY	CG-1	CORNER GUARD	INPRO CORP	STAINLESS STEEL	KRISTI ASHFORD, 513.646.2163 (m)	STAINLESS		10
SPECIALTY	CR-1	CHAIR RAIL	LX HAUSYS	GT909	MICHELLE ALLEN 513.214.9939(m)	ARMADILLO	CLASS A	4
SPECIALTY	TB-1	TACKBOARD MATERIAL						
WALL								
WALL	EP-1	ENAMEL/EPOXY PAINT	SHERWIN WILLIAMS	SW 7570	KAREN McILWAIN, 317.714.5610 (m)	EGRET WHITE		
WALL	P-1	PAINT	SHERWIN WILLIAMS	SW 7570	KAREN McILWAIN, 317.714.5610 (m)	EGRET WHITE		
WALL	P-2	PAINT	SHERWIN WILLIAMS	SW 7674	KAREN McILWAIN, 317.714.5610 (m)	PEPPERCORN		
WALL	P-3	PAINT	SHERWIN WILLIAMS	SW 7641	KAREN McILWAIN, 317.714.5610 (m)	COLLONADE GRAY		
WALL	PT-1	PORCELAIN WALL TILE	CROSSVILLE	NVM02. 12"x24"	MICEALA CARNEVALE-WETZEL, 512.500.5135 (m)	NICKLE PLATE		
WALL	VWP-1	VINYL WALL PROTECTION	INPRO CORP	LEGACY PATTERN .040 THICKNESS	KRISTI ASHFORD, 513.646.2163 (m)	2405	CLASS A	
WALL	VWP-2	VINYL WALL PROTECTION	INPRO CORP	0113, .060	KRISTI ASHFORD, 513.646.2163 (m)	TAUPE	CLASS A	

MATERIAL LEGEND REMARKS	
No.	REMARK
1.	6x12" UNPOLISHED", TOP EDGE TO BE CAPPED WITH SCHLUTER RONDEC STRIP WHERE TILE BASE DOESN 'T DIE INTO TILE EDGE ON WET WALL -AS NOTED ON INTERIOR ELEVATION/FINISH PLANS. UPPER SIDE OF TILE BASE TO BE CAPPED WITH SCHLUTER RONDEC, FINISHING AND EDGE PROTECTION STRIP, 9.5MM. THIS CONDITION ONLY EXISTS ON NON-TILED WALLS.
2.	USE 6" RUBBER BASE AT WET LOCATIONS AS NOTED, EXCEPT FOR JANITORS CLOSET AND TILED WALLS.
3.	ITEM USED FOR COUNTER TOP, USE MATCHING PVC-EDGE BANDING FOR PLASTIC LAMINATE ONLY.
4.	ITEM USED FOR CHAIR RAIL. REFER TO INTERIOR FINISH PLAN AND MATERIAL LEGEND FOR LOCATIONS AND EXTENTS.
5.	ASHLAR INSTALL, USE WITH TRANSITION STRIP, CTA-XX-H, 1/4" TO 1/8" MATERIAL, COLOR BLACK, MFG: JOHNSONITE/TARKETT WHERE CPT ABUTS RESILIENT FLOOR (MCT).
6.	QUARTER TURN INSTALL, WHERE MCT TRANSITIONS TO PT, USE REDUCER, CTA-XX-K, 3/8" TO 1/8". COLOR BLACK, MFG TARKETT/JOHNSONITE.
7.	QUARTER TURN INSTALL, ACCENT INSET AT CONFERENCE ROLL-CALL, REFER TO INTERIOR FINISHES PLAN FOR LOCATIONS AND EXTENT OF ACCENT.
8.	WHERE MCT TRANSITIONS TO PT, USE REDUCER,CTA-XX-K, 3/8" TO 1/8". COLOR BLACK, MFG TARKETT/JOHNSONITE.
9.	STACKED INSTALLATION, GROUT JOINT 3MM, GROUT: TBD.
10.	STAINLESS STEEL CORNER GUARD, REFER TO INTERIOR FINISH PLAN FOR LOCATIONS.

ROOM FINISH SCHEDULE											
Number	ROOM NAME	FLOOR	BASE	WAINSCOT		WALLS				CEILING	REMARKS
				MAT.	HT.	N	S	E	W	MAT.	
101	VESTIBULE	MAT-1	RB-1			P-1	P-1	P-1	P-1	APC-1	HIGH ABUSE GWB.
102	SAFE ROOM	MAT-1	RB-1			P-1	P-1	P-1	P-1	APC-1	HIGH ABUSE GWB.
103	OFFICE	C-1	RB-1	CR-1	2' 6"	P-2	P-1	P-2	P-1	APC-1	
104	CAPTAIN	C-1	RB-1	CR-1	2' 6"	P-2	P-1	P-1	P-2	APC-1	
105	SERGEANT	C-1	RB-1	CR-1	2' 6"	P-2	P-1	P-2	P-1	APC-1	
106	SERGEANT	C-1	RB-1	CR-1	2' 6"	P-2	P-1	P-1	P-2	APC-1	
107	WTR.	SC-1	RB-1			P-1	P-1	P-1	P-1	APC-1	
108	MECH	SC-1	RB-1			P-1	P-1	P-1	P-1	APC-1	
109	CONFERENCE/ROLL CALL	MCT-1/2	RB-1	CR-1	2' 6"	P-3/VWP-1	P-3/VWP-1	P-3/VWP-1	P-3/VWP-1	APC-1	VWP-1 UP TO CHAIR RAIL ONLY.
110	DEPUTIES	MCT-1	RB-1	CR-1	2' 6"	P-1/VWP-2	P-1	P-1	P-1/VWP-2	APC-1	VWP-2 BELOW COUNTER.
111	DETECTIVE 1	C-1	RB-1	CR-1	2' 6"	P-1	P-1	P-1	P-1	APC-1	CR-1 EXCLUDE N WALL.
112	DETECTIVE 2	C-1	RB-1	CR-1	2' 6"	P-1	P-1	P-1	P-1	APC-1	CR-1 EXCLUDE N WALL.
113	DETECTIVE 3	C-1	RB-1	CR-1	2' 6"	P-1	P-1	P-1	P-1	APC-1	CR-1 EXCLUDE N WALL.
114	DETECTIVE 4	C-1	RB-1	CR-1	2' 6"	P-1	P-1	P-1	P-1	APC-1	CR-1 EXCLUDE N WALL.
115	DETECTIVE 5	C-1	RB-1	CR-1	2' 6"	P-1	P-1	P-1	P-1	APC-1	CR-1 EXCLUDE N WALL.
116	INTERVIEW 1	C-1	RB-1			VWP-2	VWP-2	VWP-2	VWP-2	GYB/P-1	HIGH ABUSE SOUND ATTENUATION GWB, VWP-2 RUNS FULL HEIGHT THIS AREA USE COLOR MATCH CAULK AT ALL SEAMS
117	INTERVIEW 2	C-1	RB-1			VWP-2	VWP-2	VWP-2	VWP-2	GYB/P-1	HIGH ABUSE SOUND ATTENUATION GWB, VWP-2 RUNS FULL HEIGHT THIS AREA USE COLOR MATCH CAULK AT ALL SEAMS
118	STORM SHLT/TLT	PC-1	PTWB-1			EP-1	EP-1	EP-1	EP-1	P-1	CEILING P-1 ON CONCRETE
119	COP	MCT-1	RB-1			P-1	P-1/VWP-2	P-1/VWP-2	P-1	APC-1	HIGH ABUSE VINYL BELOW COUNTER.
120	TRAFFIC	MCT-1	RB-1			P-1/VWP-2	P-1/VWP-2	P-1/VWP-2	P-1/VWP-2	APC-1	HIGH ABUSE VINYL BELOW COUNTER.
121	MECH.	SC-1	RB-1			P-1	P-1	P-1	P-1	APC-1	
122	JAN.	SC-1	RB-1			EP-1/VWP-2	EP-1/VWP-2	EP-1/VWP-2	EP-1/VWP-2	APC-1	
123	BREATH	MCT-1	RB-1	CR-1	2' 6"	P-1	P-1	P-1	P-1/VWP-2	APC-1	HIGH ABUSE GWB.
124	TLT/SHWR	PT-1	PTWB-1			EP-1	PTW-1	EP-1	PTW-1	GYB/EP-1	REFER TO INTERIOR ELEVATIONS FOR LOCATIONS AND EXTENT OF MATERIALS
125	CORRIDOR	MCT-1	RB-1	CG-1		P-1	P-1	P-1	P-1	APC-2	
125.01	COPY	MCT-1	RB-1	CG-1		P-1	P-1	P-1	P-1	APC-2	
125.02	CHARGING	MCT-1	RB-1	CG-1		P-1	P-1	P-1	P-1	APC-2	
126	IT	MCT-1	RB-1			P-1	P-1	P-1	P-1	APC-1	
127	WEAPONS CLEAN	MCT-1	RB-1			P-1	P-1	P-1	P-1	APC-1	
128	EQUIPMENT BAGS	MCT-1	RB-1			VWP-2	P-1	VWP-2	VWP-2	APC-1	VWP-2 FULL HEIGHT, EXCLUDE SOUTH WALL.
129	FILE STORAGE	MCT-1	RB-1			P-1	P-1	P-1	P-1	APC-1	
130	BREAK ROOM	MCT-1	RB-1			P-1	P-1	P-1	P-1	APC-1	
131	TLT	PT-1	PTWB-1			PTW-1	EP-1	PTW-1	EP-1	APC-1	REFER TO INTERIOR ELEVATIONS FOR LOCATIONS AND EXTENT OF MATERIALS
132	TLT	PT-1	PTWB-1			PTW-1	EP-1	EP-1	PTW-1	APC-1	REFER TO INTERIOR ELEVATIONS FOR LOCATIONS AND EXTENT OF MATERIALS
133	TLT/SHWR	PT-1	PTWB-1			PTW-1	EP-1	EP-1	PTW-1	GYB/EP-1	REFER TO INTERIOR ELEVATIONS FOR LOCATIONS AND EXTENT OF MATERIALS
134	CHANGE 1	PT-1	PTWB-1			P-1	P-1	P-1	P-1	APC-1	
135	CHANGE 2	PT-1	PTWB-1			P-1	P-1	P-1	P-1	APC-1	
136	ACCESSIBLE CHANGE 2	PT-1	PTWB-1			P-1	P-1	P-1	P-1	APC-1	
137	ACCESSIBLE CHANGE 1	PT-1	PTWB-1			P-1	P-1	P-1	P-1	APC-1	
138	PERSONAL GEAR	PT-1	PTWB-1	CG-1		P-1	P-1	P-1	P-1	APC-1	
139	PERSONAL GEAR CHANGING ROOM	PT-1	PTWB-1	CG-1		P-1	P-1	P-1	P-1	APC-1	
140	CORRIDOR	MCT-1	RB-1	CG-1		P-1	P-1	P-1	P-1	APC-1	

ROOM FINISH SCHEDULE REMARKS	
No.	REMARK
1.	

A

B

C

D

E

F

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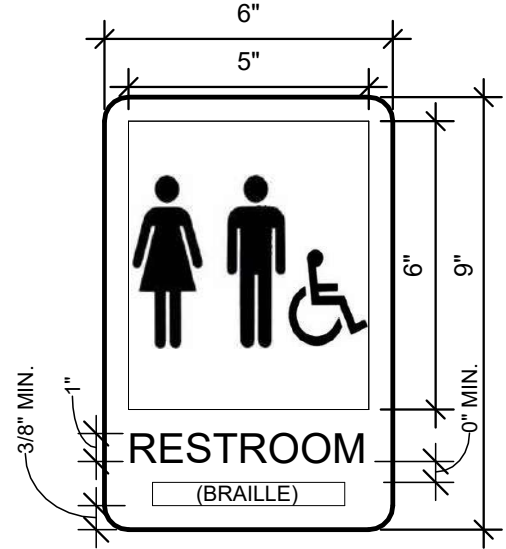
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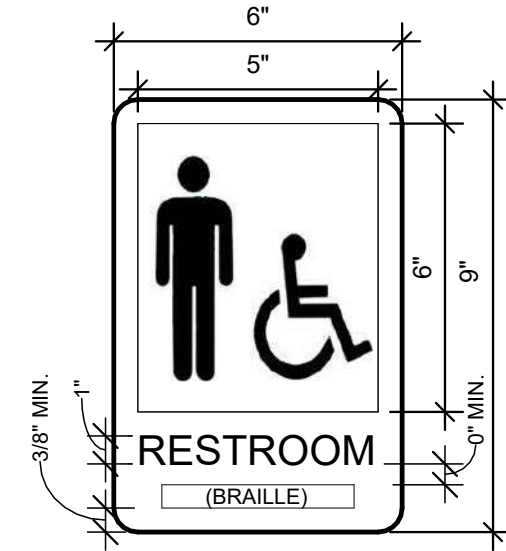


SIGNAGE LEGEND




UNISEX RESTROOM - TYPE 1

3" = 1'-0"




MEN'S RESTROOM - TYPE 2

3" = 1'-0"

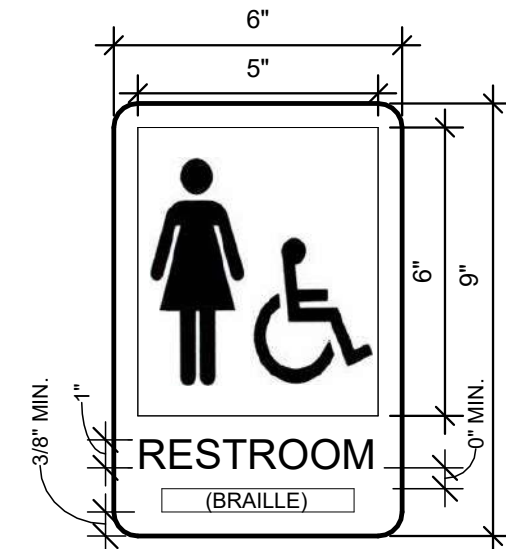

WOMEN'S RESTROOM - TYPE 3

3" = 1'-0"

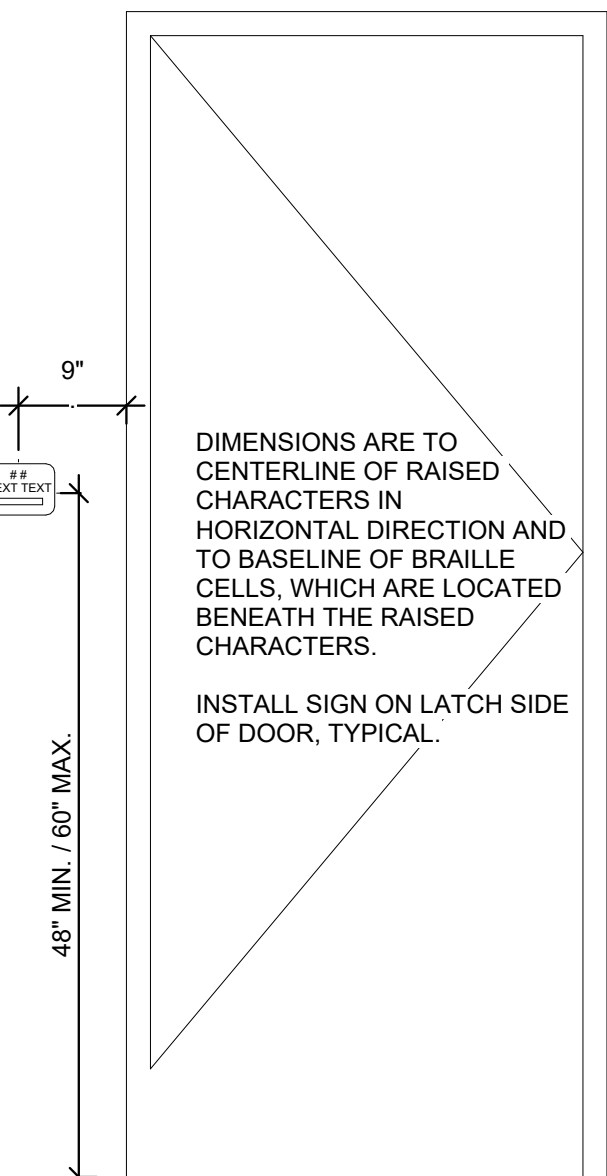

SIGNAGE LOCATION


3/4" = 1'-0"

SIGN NOTES

- A. ALL SIGNS SHALL HAVE BRAILLE LETTERING BENEATH TEXT, TYPICAL.
- B. SIGNS MOUNTED ON GLASS AT DOOR NEED TO BE MOUNTED WITH ADHESIVE AND MATCHING BACKER PLATE FOR OTHER SIDE OF GLASS.
- C. TEXT AND GRAPHICS TO BE NON-GLARE COLOR IN HIGH CONTRAST WITH BACKGROUND. SELECTED BY ARCHITECT FROM MANUFACTURER'S STANDARD COLORS.
- D. BACKGROUND TO BE NON-GLARE COLOR IN HIGH CONTRAST WITH TEXT AND GRAPHICS. SELECTED BY ARCHITECT FROM MANUFACTURER'S STANDARD COLORS.
- E. 1/2" RADIUS CORNERS.
- F. ALL TEXT ON SIGNS LOCATED NEXT TO INTERIOR DOORS WILL BE 1/32" RAISED CHARACTERS, UPPERCASE, AND VIEWABLE AT LESS THAN 6 FEET.


TORNADO SHELTER - TYPE 5

3" = 1'-0"

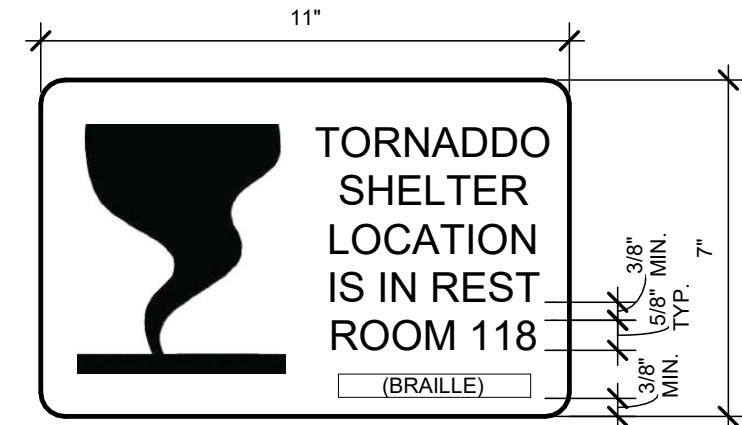


TORNADO SHELTER - TYPE 6

3" = 1'-0"

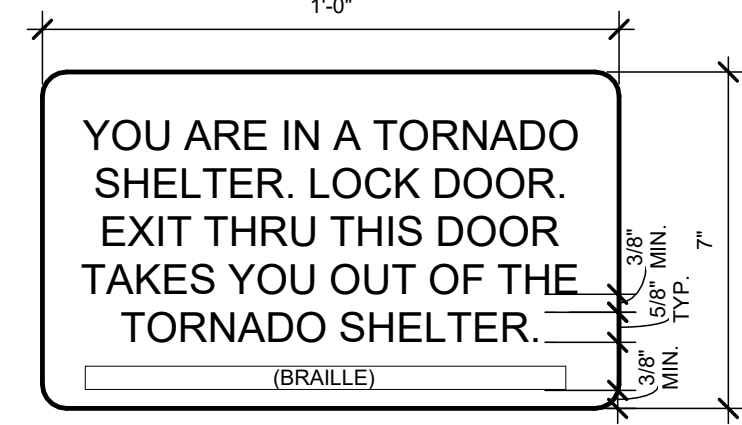


TORNADO SHELTER - TYPE 7A

3" = 1'-0"

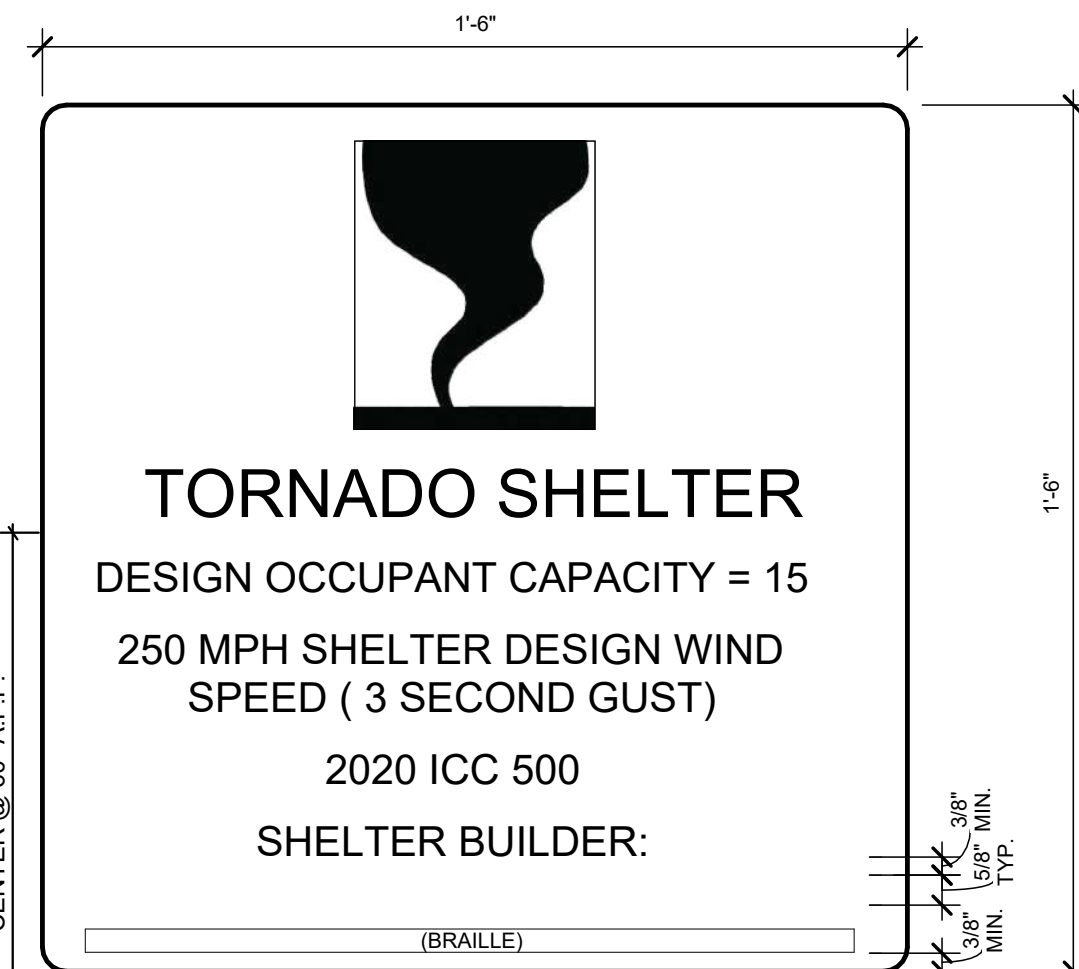

TORNADO SHELTER - TYPE 7

3" = 1'-0"

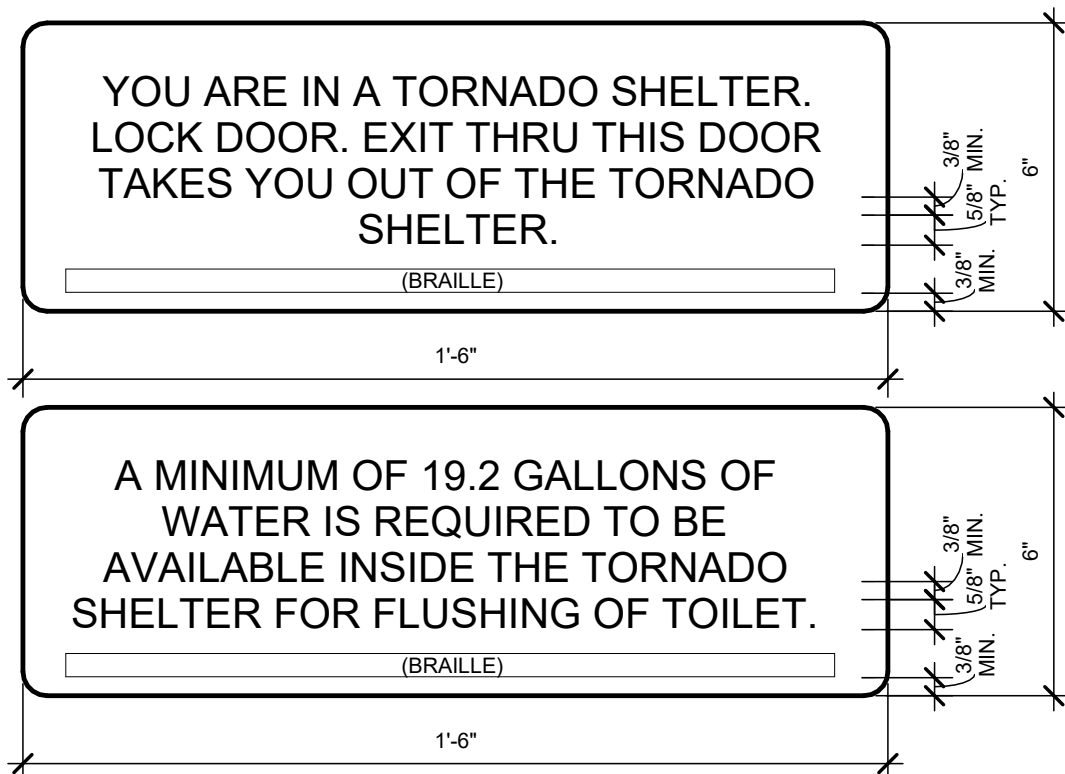

DOOR AND FRAME SCHEDULE

DOOR No.	ROOM NAME	HDW. SET	DOOR								FRAME					FIRE RTG.		REMARKS	
			SIZE			MAT.	TYPE	FIN.	U/C	MAT.	TYPE	FIN.	DETAILS						
			W	H	T								HEAD	JAMB	SILL				
101A	VESTIBULE	3.0	3'-0"	7'-0"	2"	EX.	AL1			ALUM.M				D5/A0.6	D3/A0.6	E3/A0.7		1.	
101B	VESTIBULE	10.0	3'-0"	7'-0"	1 3/4"	HM	NL1			HM				B4/A0.6	B1/A0.6	B2/A0.6	1 1/2 HR		
102	VESTIBULE	9.0	3'-0"	7'-0"	1 3/4"	WD	F1			HM				B4/A0.6	B1/A0.6	B2/A0.6	-		
103	OFFICE	6.0	3'-0"	7'-0"	1 3/4"	WD	F1			HM				B4/A0.6	B1/A0.6	B2/A0.6	-		
104	CAPTAIN	6.0	3'-0"	7'-0"	1 3/4"	WD	F1			HM				B4/A0.6	B1/A0.6	B2/A0.6	-		
105	SERGEANT	6.0	3'-0"	7'-0"	1 3/4"	WD	F1			HM				B4/A0.6	B1/A0.6	B2/A0.6	-		
106	SERGEANT	6.0	3'-0"	7'-0"	1 3/4"	WD	F1			HM				B4/A0.6	B1/A0.6	B2/A0.6	-		
107	CONFERENCE/ROLL CALL	4.0	3'-0"	7'-0"	1 3/4"	WD	F1			HM				B4/A0.6	B1/A0.6	B2/A0.6	-		
108	CONFERENCE/ROLL CALL	4.0A	5'-0"	7'-0"	1 3/4"	WD	F2			HM				B4/A0.6	B1/A0.6	B2/A0.6	-		
109	CONFERENCE/ROLL CALL	7.0	3'-0"	7'-0"	1 3/4"	WD	F1			HM				B4/A0.6	B1/A0.6	B2/A0.6	-		
110	DEPUTIES	6.0	3'-0"	7'-0"	1 3/4"	WD	F1			HM				B4/A0.6	B1/A0.6	B2/A0.6	-		
111	DETECTIVE 1	6.0	3'-0"	7'-0"	1 3/4"	WD	F1			HM				B4/A0.6	B1/A0.6	B2/A0.6	-		
112	DETECTIVE 2	6.0	3'-0"	7'-0"	1 3/4"	WD	F1			HM				B4/A0.6	B1/A0.6	B2/A0.6	-		
113	DETECTIVE 3	6.0	3'-0"	7'-0"	1 3/4"	WD	F1			HM				B4/A0.6	B1/A0.6	B2/A0.6	-		
114	DETECTIVE 4	6.0	3'-0"	7'-0"	1 3/4"	WD	F1			HM				B4/A0.6	B1/A0.6	B2/A0.6	-		
115	DETECTIVE 5	6.0	3'-0"	7'-0"	1 3/4"	WD	F1			HM				B4/A0.6	B1/A0.6	B2/A0.6	-		
116	INTERVIEW 1	6.0	3'-0"	7'-0"	1 3/4"	WD	F1			HM				B4/A0.6	B1/A0.6	B2/A0.6	-		
117	INTERVIEW 2	6.0	3'-0"	7'-0"	1 3/4"	WD	F1			HM				B4/A0.6	B1/A0.6	B2/A0.6	-		
118	STORM SHLT/TLT	1.0	3'-0"	7'-0"	1 3/4"	HM	NL1			HM				C1/A0.7	C3/A0.7	B2/A0.6	1 1/2 HR		
119	COP	6.0	3'-0"	7'-0"	1 3/4"	WD	F1			HM				B4/A0.6	B1/A0.6	B2/A0.6	-		
120	TRAFFIC	6.0	3'-0"	7'-0"	1 3/4"	WD	F1			HM				B4/A0.6	B1/A0.6	B2/A0.6	-		
121A	MECH.	4.0A	5'-0"	7'-0"	1 3/4"	WD	F2			HM				B4/A0.6	B1/A0.6	B2/A0.6	-		
121B	MECH.	4.0A	5'-0"	7'-0"	1 3/4"	WD	F2			HM				B4/A0.6	B1/A0.6	B2/A0.6	-		
122	JAN.	8.0	2'-6"	7'-0"	1 3/4"	WD	F1			HM				B4/A0.6	B1/A0.6	B2/A0.6	-		
123	BREATH		3'-0"	7'-0"	1 3/4"					HM				B4/A0.6	B1/A0.6	B2/A0.6	-		
124	TLT/SHWR	8.0	3'-0"	7'-0"	1 3/4"	WD	F1			HM				B4/A0.6	B1/A0.6	B2/A0.6	-		
125A	CORRIDOR	2.0	3'-0"	7'-0"	1 3/4"	HM	NL1			HM				E5/A0.7	C5/A0.7		1 1/2 HR	2.	
125B	CORRIDOR	2.0	3'-0"	7'-0"	1 3/4"	HM	EX.			HM								3.	
126	IT	5.0	3'-0"	7'-0"	1 3/4"	WD	F1			HM				B4/A0.6	B1/A0.6	B2/A0.6	-		
127	WEAPONS CLEAN		3'-0"	7'-0"	1 3/4"					HM				B4/A0.6	B1/A0.6	B2/A0.6	-		
128	EQUIPMENT BAGS	5.0	3'-0"	7'-0"	1 3/4"	WD	F1			HM				B4/A0.6	B1/A0.6	B2/A0.6	-		
129	FILE STORAGE	5.0	3'-0"	7'-0"	1 3/4"	WD	F1			HM				B4/A0.6	B1/A0.6	B2/A0.6	-		
130	BREAK ROOM		4'-0"	7'-0"	1 3/4"					HM				B4/A0.6	B1/A0.6	B2/A0.6	-		
131	PERSONAL GEAR CHANGING ROOM	8.0	3'-0"	7'-0"	1 3/4"	WD	F1			HM				B4/A0.6	B1/A0.6	B2/A0.6	-		
132	TLT	8.0	3'-0"	7'-0"	1 3/4"	WD	F1			HM				B4/A0.6	B1/A0.6	B2/A0.6	-		
133	PERSONAL GEAR CHANGING ROOM	8.0	3'-0"	7'-0"	1 3/4"	WD	F1			HM				B4/A0.6	B1/A0.6	B2/A0.6	-		
134	PERSONAL GEAR CHANGING ROOM	8.0	3'-0"	7'-0"	1 3/4"	WD	F1			HM				B4/A0.6	B1/A0.6	B2/A0.6	-		
135	CHANGE 2	8.0	3'-0"	7'-0"	1 3/4"	WD	F1			HM				B4/A0.6	B1/A0.6	B2/A0.6	-		
136	ACCESSIBLE CHANGE 2	8.0	3'-0"	7'-0"	1 3/4"	WD	F1			HM				B4/A0.6	B1/A0.6	B2/A0.6	-		
137	ACCESSIBLE CHANGE 1	8.0	3'-0"	7'-0"	1 3/4"	WD	F1			HM				B4/A0.6	B1/A0.6	B2/A0.6	-		
140A	CORRIDOR	10.0	3'-0"	7'-0"	1 3/4"	WD	F1			HM				B4/A0.6	B1/A0.6	B2/A0.6	-		
140B	CORRIDOR	2.0	3'-0"	7'-0"	1 3/4"	HM	F3			HM				E5/A0.7	C5/A0.7			2.	

DOOR REMARKS

No.	REMARK
1.	RELOCATED STOREFRONT DOOR AND TRANSOM.
2.	INSULATED.
3.	EXISTING.

EXIT SIGN - TYPE 4

3" = 1'-0"

OCCUPANCY SIGN - TYPE 8

3" = 1'-0"

TYPE F1  
FLUSH

TYPE F2  
FLUSH

TYPE F3  
HM FLUSH

TYPE NL1  
HM INSULATED

TYPE AL1  
ALUMINUM  
STOREFRONT

① INDICATES TEMPERED SAFETY GLAZING

DOOR ELEVATIONS

TYPE 1  
SINGLE / PAIR  
STANDARD

TYPE 2  
STORM

FRAME ELEVATIONS



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A

B

C










D

E

F

INTERIOR WALL TYPES SCHEDULE

X

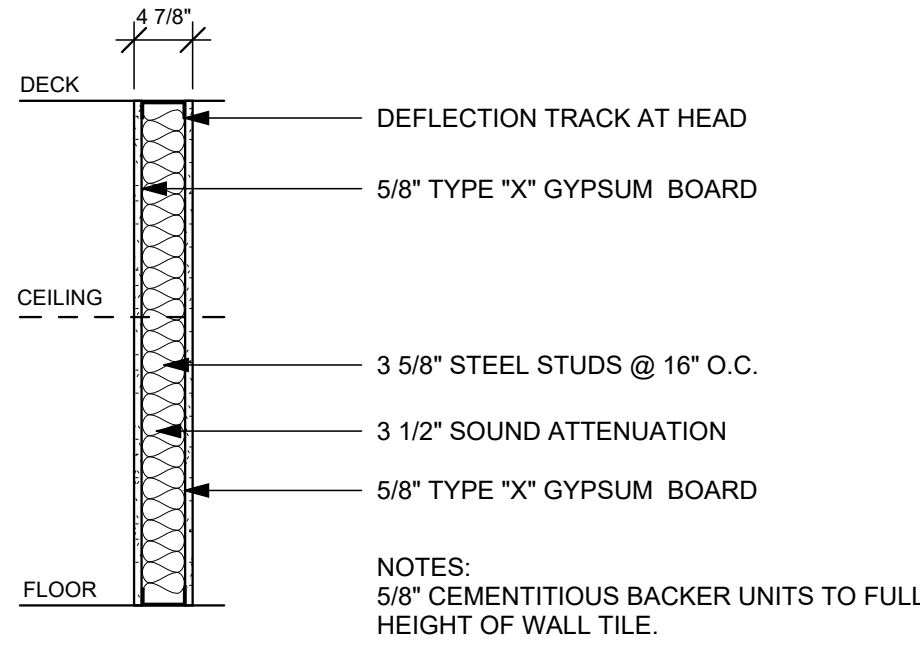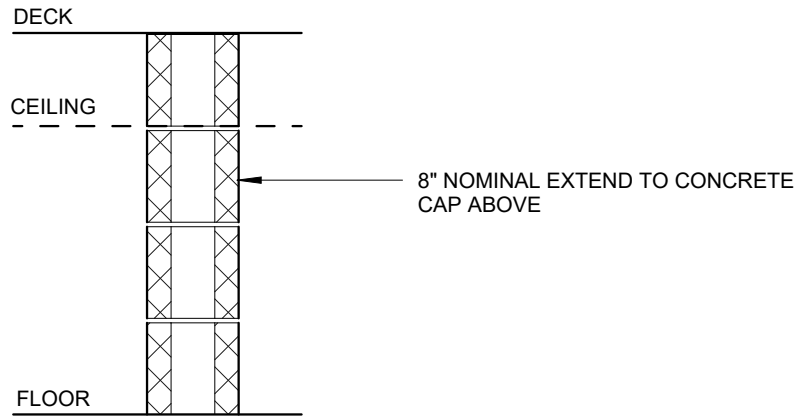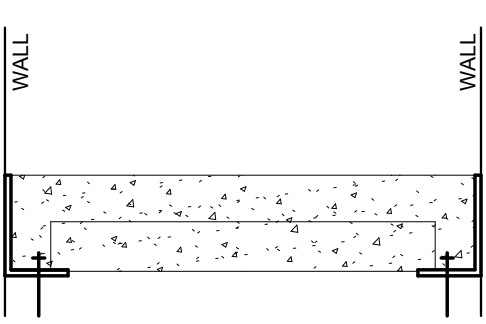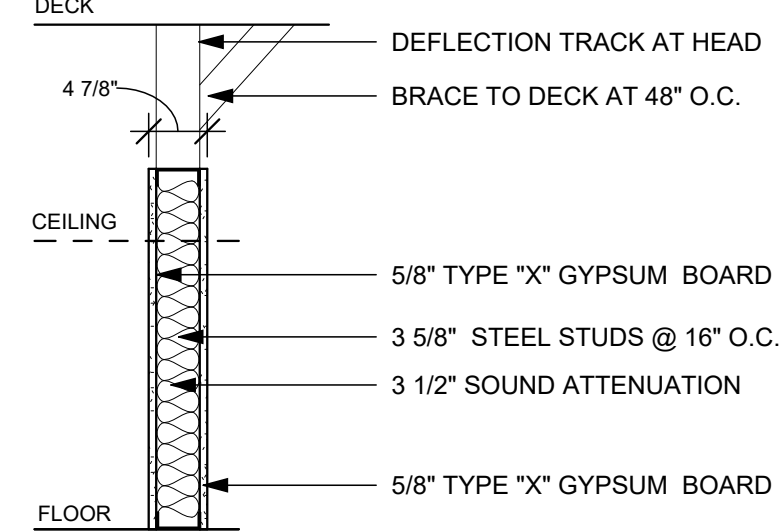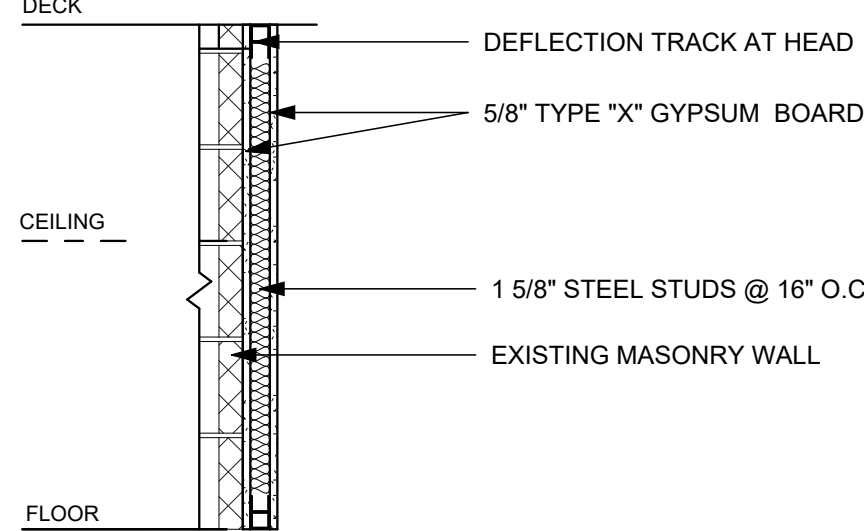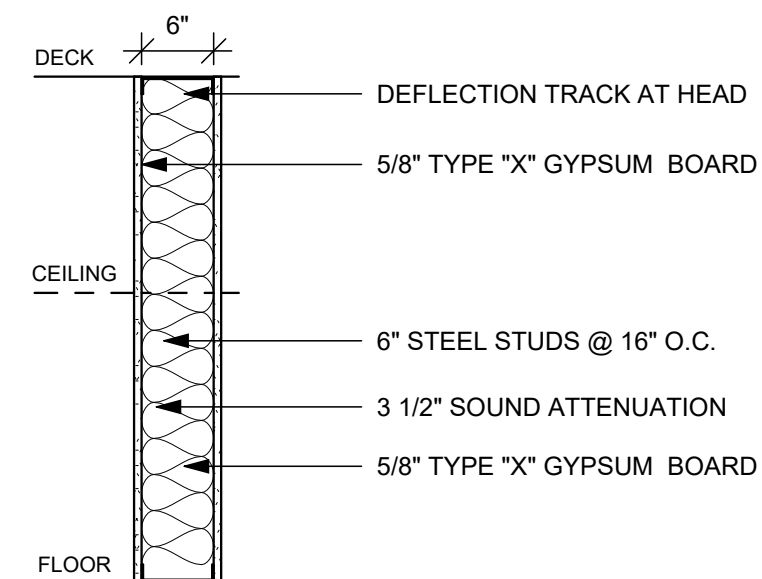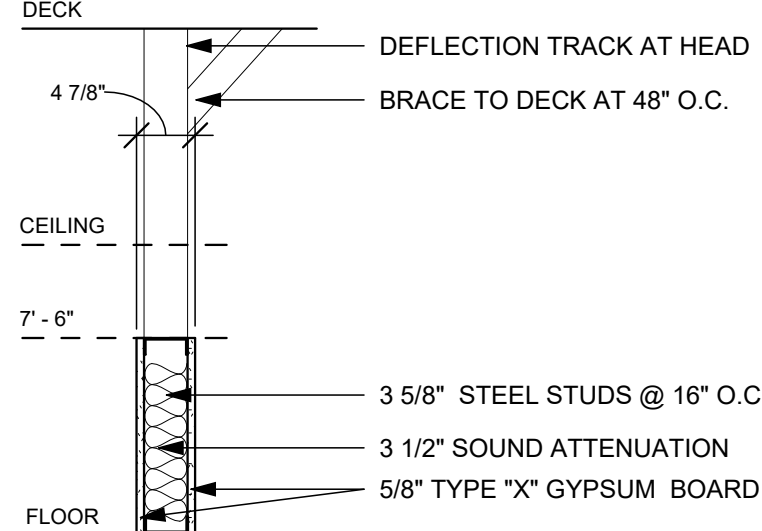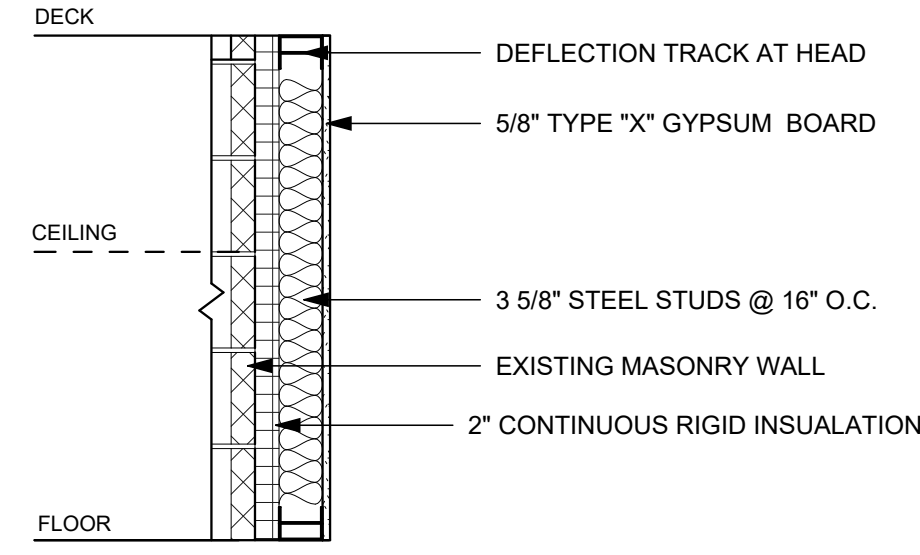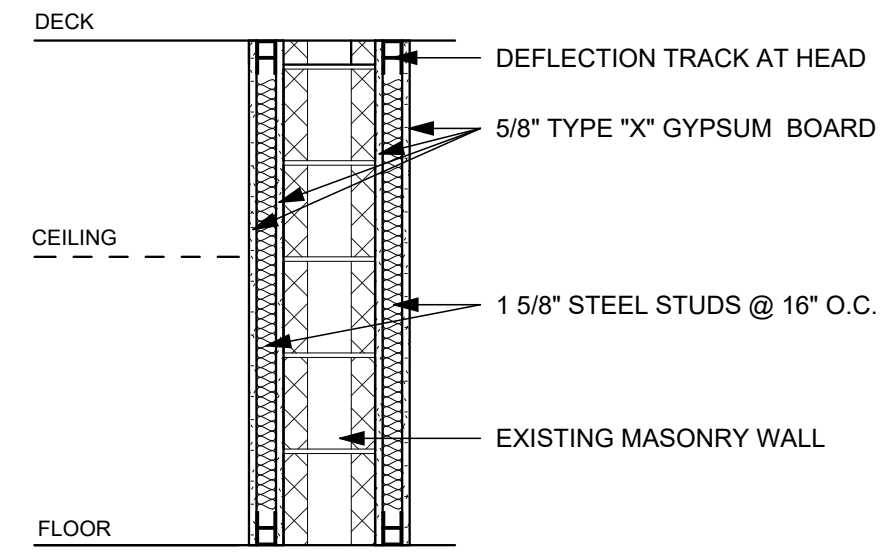TYPE	BASE WALL WIDTH	FIRE RATING TESTING AGENCY, ASSEMBLY NO.	DETAILS & NOTES	TYPE	BASE WALL WIDTH	FIRE RATING TESTING AGENCY, ASSEMBLY NO.	DETAILS & NOTES	TYPE	BASE WALL WIDTH	FIRE RATING TESTING AGENCY, ASSEMBLY NO.	DETAILS & NOTES
A1	3 5/8"	-		M1	7 5/8"	2 HR. UL: U905				2 HR. UL: D219	
A2	3 5/8"			A6	1 5/8"						
A3	6"			A7	3 5/8"						
A4	3 5/8"							<div>GENERAL NOTES</div> <div><div>A. MOISTURE/MOLD RESISTANT GYPSUM BOARD SHALL BE USED BEHIND ALL SINKS, SERVICE SINKS AND SHOWER AREAS. EXTEND MINIMUM 24" BEYOND PLUMBING FIXTURES.</div><div>B. PROVIDE &amp; INSTALL DEFLECTION TRACK AT ALL INTERIOR WALLS THAT EXTEND TO DECK.</div><div>C. UL TEST NUMBERS FOR INTERIOR PARTITIONS WILL VARY DEPENDING ON THE MANUFACTURER OF COMPONENTS ACTUALLY USED. MAINTAIN RATING AND ADVISE IF WALL THICKNESS WILL CHANGE.</div><div>D. DRYWALL CONTRACTOR TO PAINT WALL RATINGS LABELS AT MAXIMUM 12 FEET O.C. ON ALL FIRE RATED PARTITIONS. LABEL TO BE PAINTED ABOVE CEILING WITH A STENCIL MIN. OF 4 INCHES IN HEIGHT, BLACK COLOR.</div><div>E. FIRE RATED WALLS AND SMOKE PARTITIONS ARE TO BE CONSTRUCTED TIGHT TO STRUCTURE, PIPING AND OTHER PENETRATIONS. ALL PENETRATIONS AND PERIMETER OF WALLS TO BE FIRE CAULKED.</div><div>F. STEEL STUD PARTITIONS SHALL BE BRACED TO STRUCTURE ABOVE.</div><div>G. REFER TO FLOOR PLANS FOR LOCATIONS OF INTERIOR PARTITION TYPES.</div><div>H. REFER TO SHEET AX.X FOR TYPICAL INTERIOR PARTITIONS DETAILS.</div><div>I. ALL PARTITIONS SCHEDULED RECEIVE WALL TILE SHALL HAVE CEMENTITIOUS BACKER UNIT TO FULL HEIGHT OF WALL TILE.</div><div>J. ALL PENETRATIONS IN FIRE RATED PARTITIONS SHALL BE FIRESTOPPED, WHETHER THEY ARE NEW OR EXISTING. INCLUDING THOSE CREATED BY THE REMOVAL OF AN EXISTING PENETRATING ITEM. FIRESTOPPING SYSTEMS SHALL BE FM OR U.L. LABORATORY APPROVED PRODUCTS.</div><div>K. APPLY ACOUSTICAL SEALANT AT ENTIRE PERIMETER OF ALL GYPSUM BOARD PARTITIONS.</div><div>L. AT ALL STC-RATED ACOUSTICAL / SOUND CONTROL TYPE PARTITIONS APPLY ACOUSTICAL SEALANT AT PERIMETER OF PARTITION AND AROUND ELECTRICAL RECEPTACLES, PIPES AND &amp; DUCT PENETRATIONS. ACOUSTICAL SEALANT SHALL BE APPLIED TO BOTH FACES OF PARTITION.</div><div>M. EXISTING BUILDING FLOOR TO DECK HEIGHTS FOR AREAS OF WORK:<div><div>- FIRST FLOOR TO ROOF ROOMS 101-118:</div><div>F.V. VARIABLE - DECK SLOPES SOUTH TO NORTH</div></div><div><div>- FIRST FLOOR TO ROOF ROOMS 119-140:</div><div>F.V. VARIABLE - DECK SLOPES SOUTH TO NORTH</div></div></div></div>			
A5	1 5/8"										



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A


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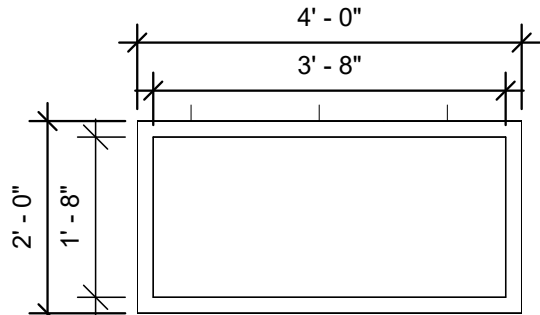
D

E

F



**B1** SF-1  
1/2" = 1'-0"

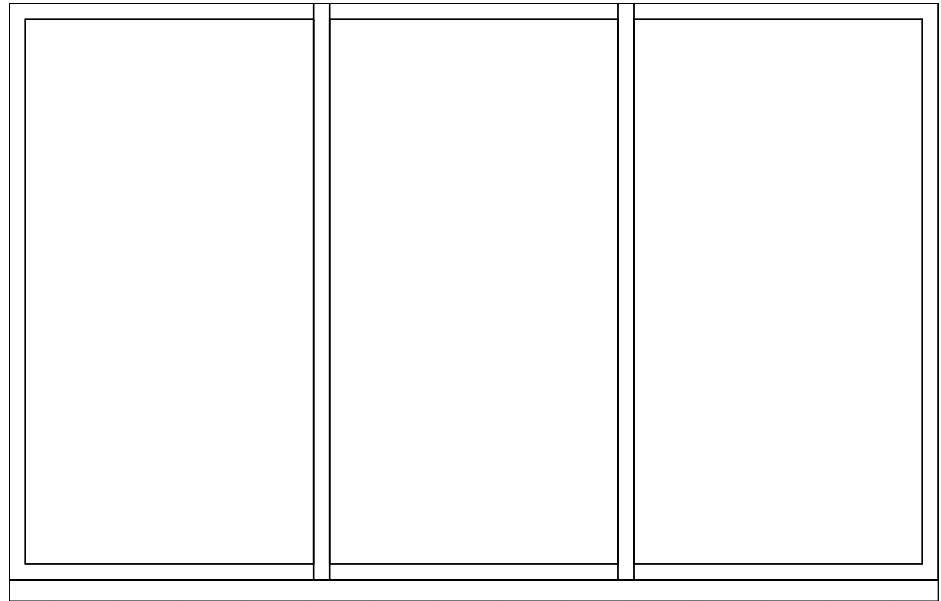

**B3** SF-3 (BID ALT)  
1/2" = 1'-0"

### WINDOW AND STOREFRONT SCHEDULE

Type	R.O.		Frame Material	Head	Jamb	Sill	Glazing		Head Height	Comments
	Width	Height					Thickness	Type		
SF-1	3' - 4"	6' - 0"	ALUM.						8' - 8"	1.
SF-2	3' - 6"	6' - 0"	ALUM.						8' - 8"	EXISTING.
SF-3	4' - 0"	2' - 0"	ALUM.	F3/A0.6 & E1/A0.7	F1/A0.6 & F1/A0.7	F5/A0.6 & F3/A0.7			7' - 4"	2.

### STOREFRONT REMARKS

No.	REMARK
1	EXISTING STOREFRONT UNIT TO BE RELOCATED. F.V. SIZE.
2	MATCH FINISHES OF EXISTING TO REMAIN.
3	FIELD VERIFY DIMENSIONS OF ALL EXISTING STOREFRONTS.

A

B

C

D


E

F




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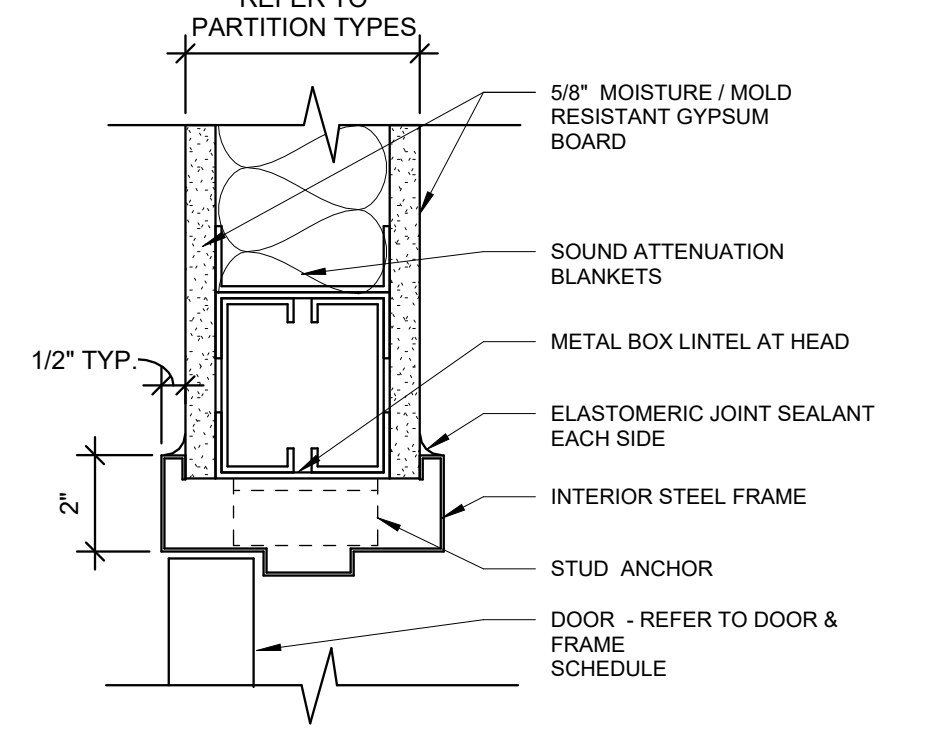
A

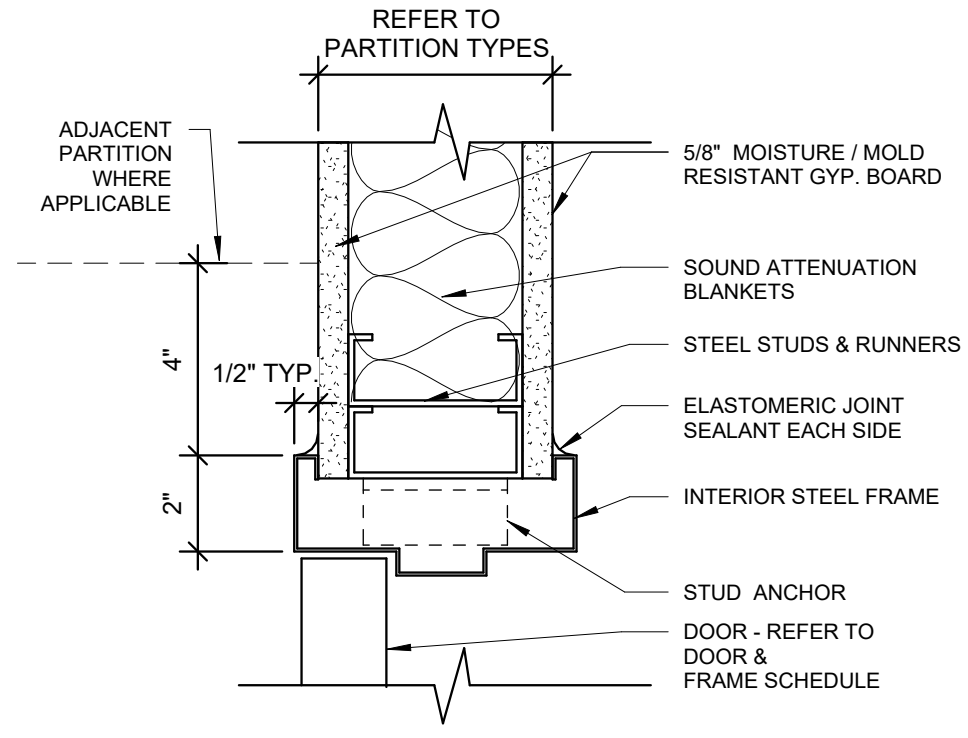


**B1** TYP. INT. DOOR JAMB DETAIL  
3" = 1'-0"

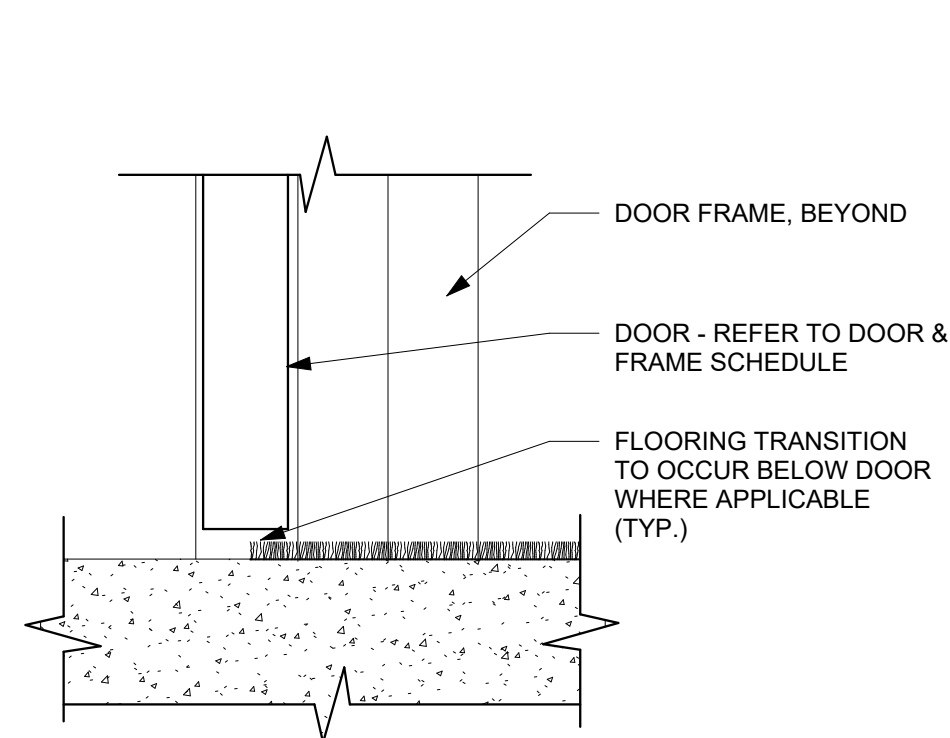

**B2** TYP. INT. DOOR SILL DETAIL  
3" = 1'-0"




**B4** TYP. INTERIOR DOOR HEAD DETAIL  
3" = 1'-0"

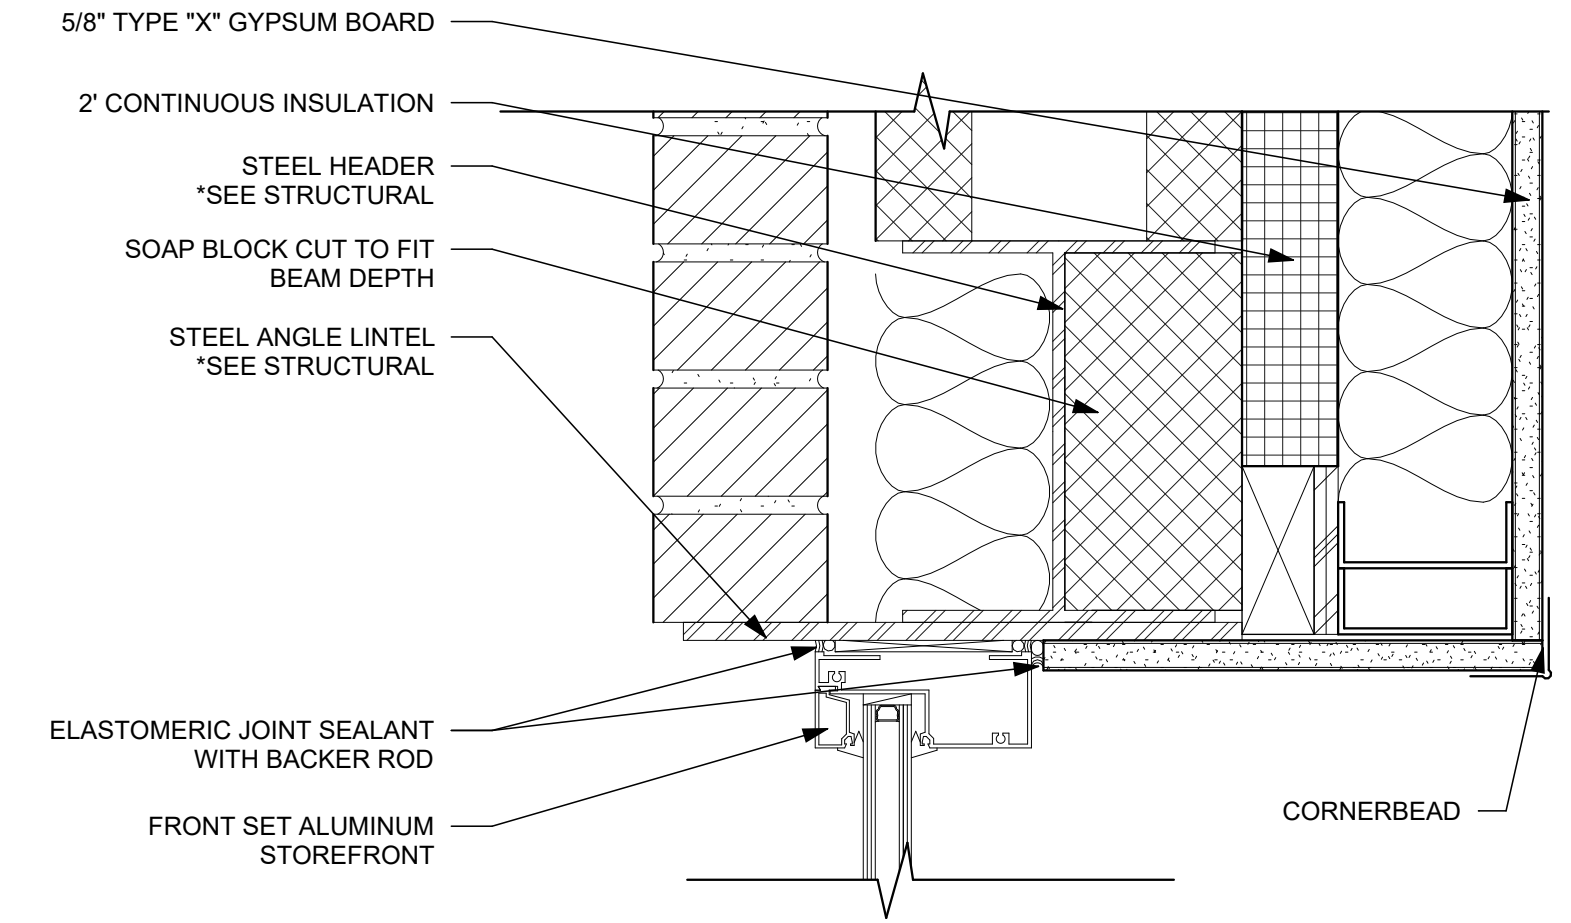


**B5** WINDOW (SF-3) HEAD DETAIL - EXISTING STOREFRONT  
3" = 1'-0"


C

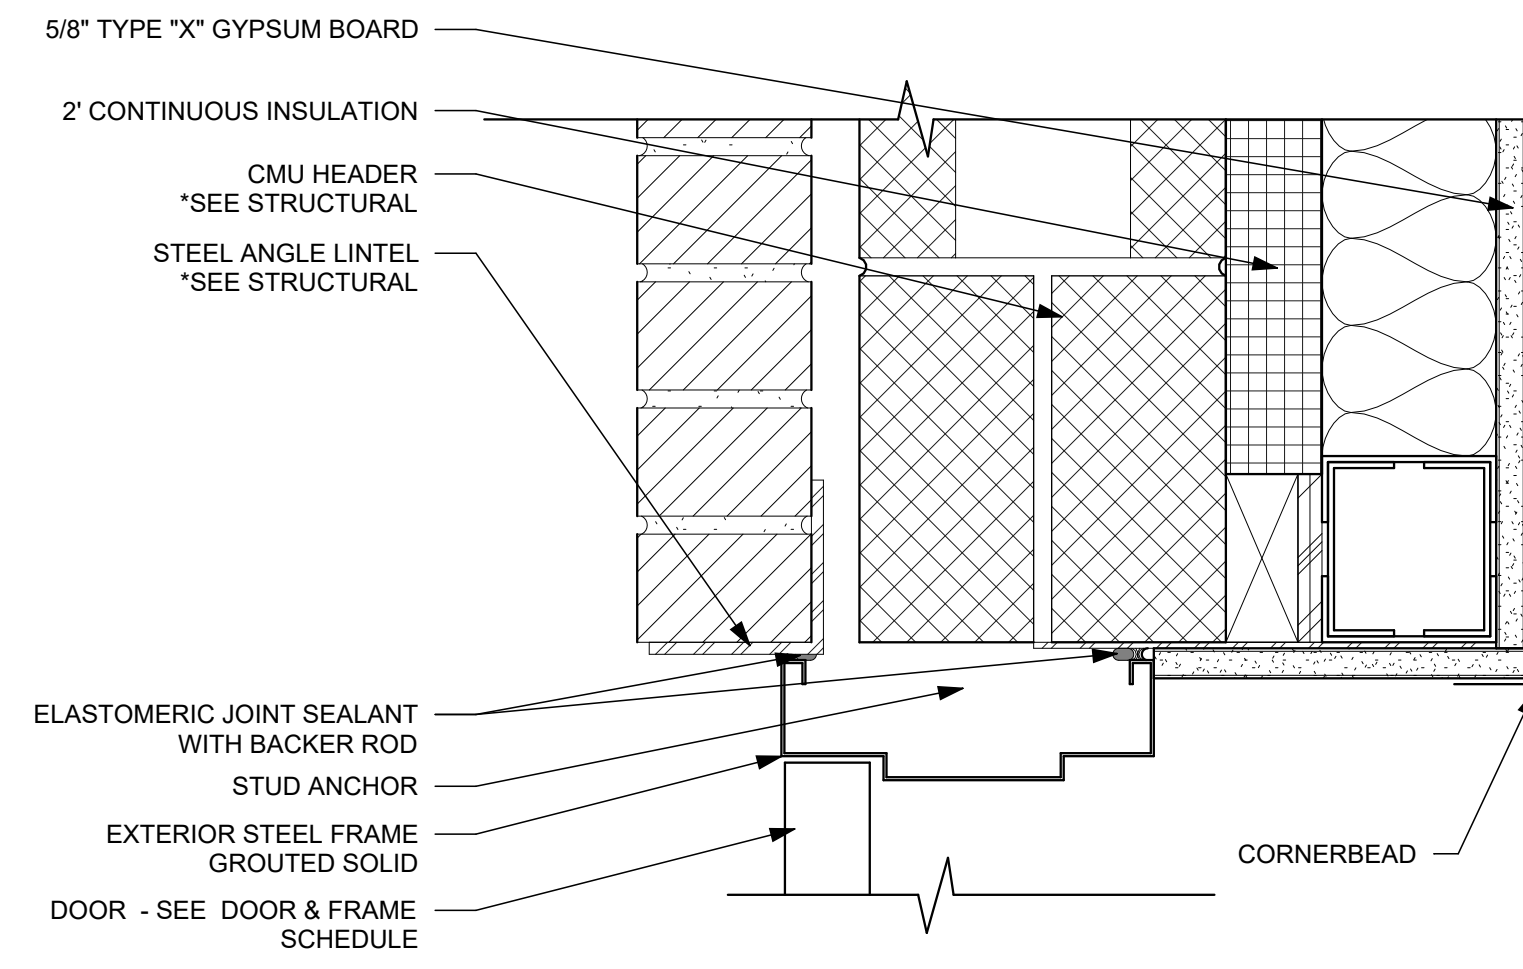

**D1** DOOR HEAD DETAIL - BRICK  
3" = 1'-0"

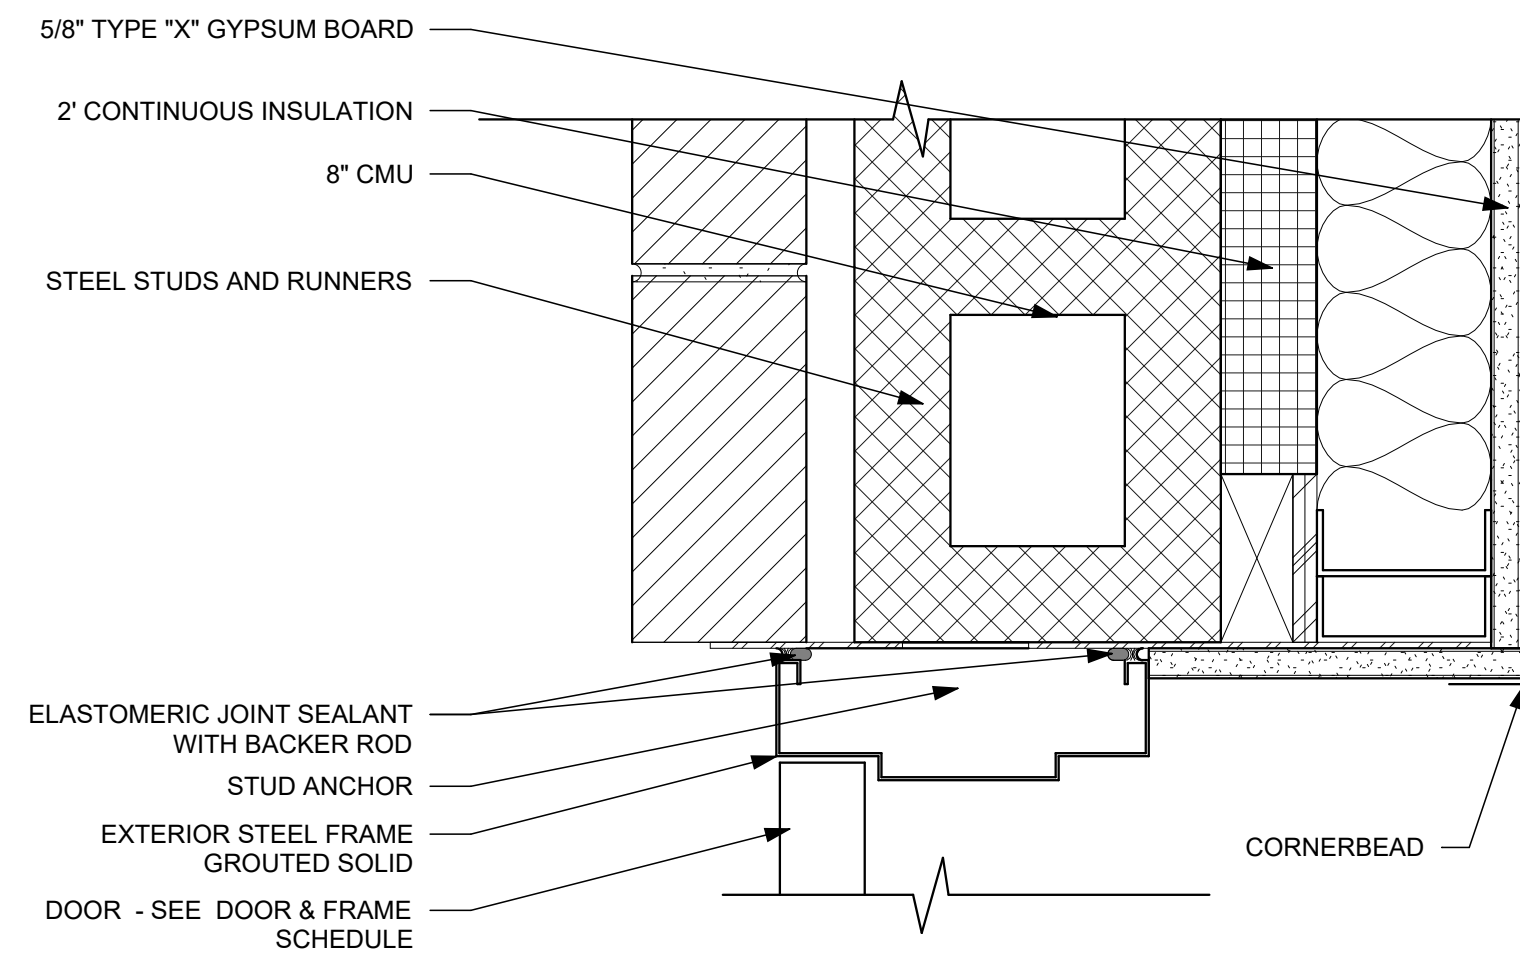


**D3** DOOR JAMB DETAIL - BRICK  
3" = 1'-0"

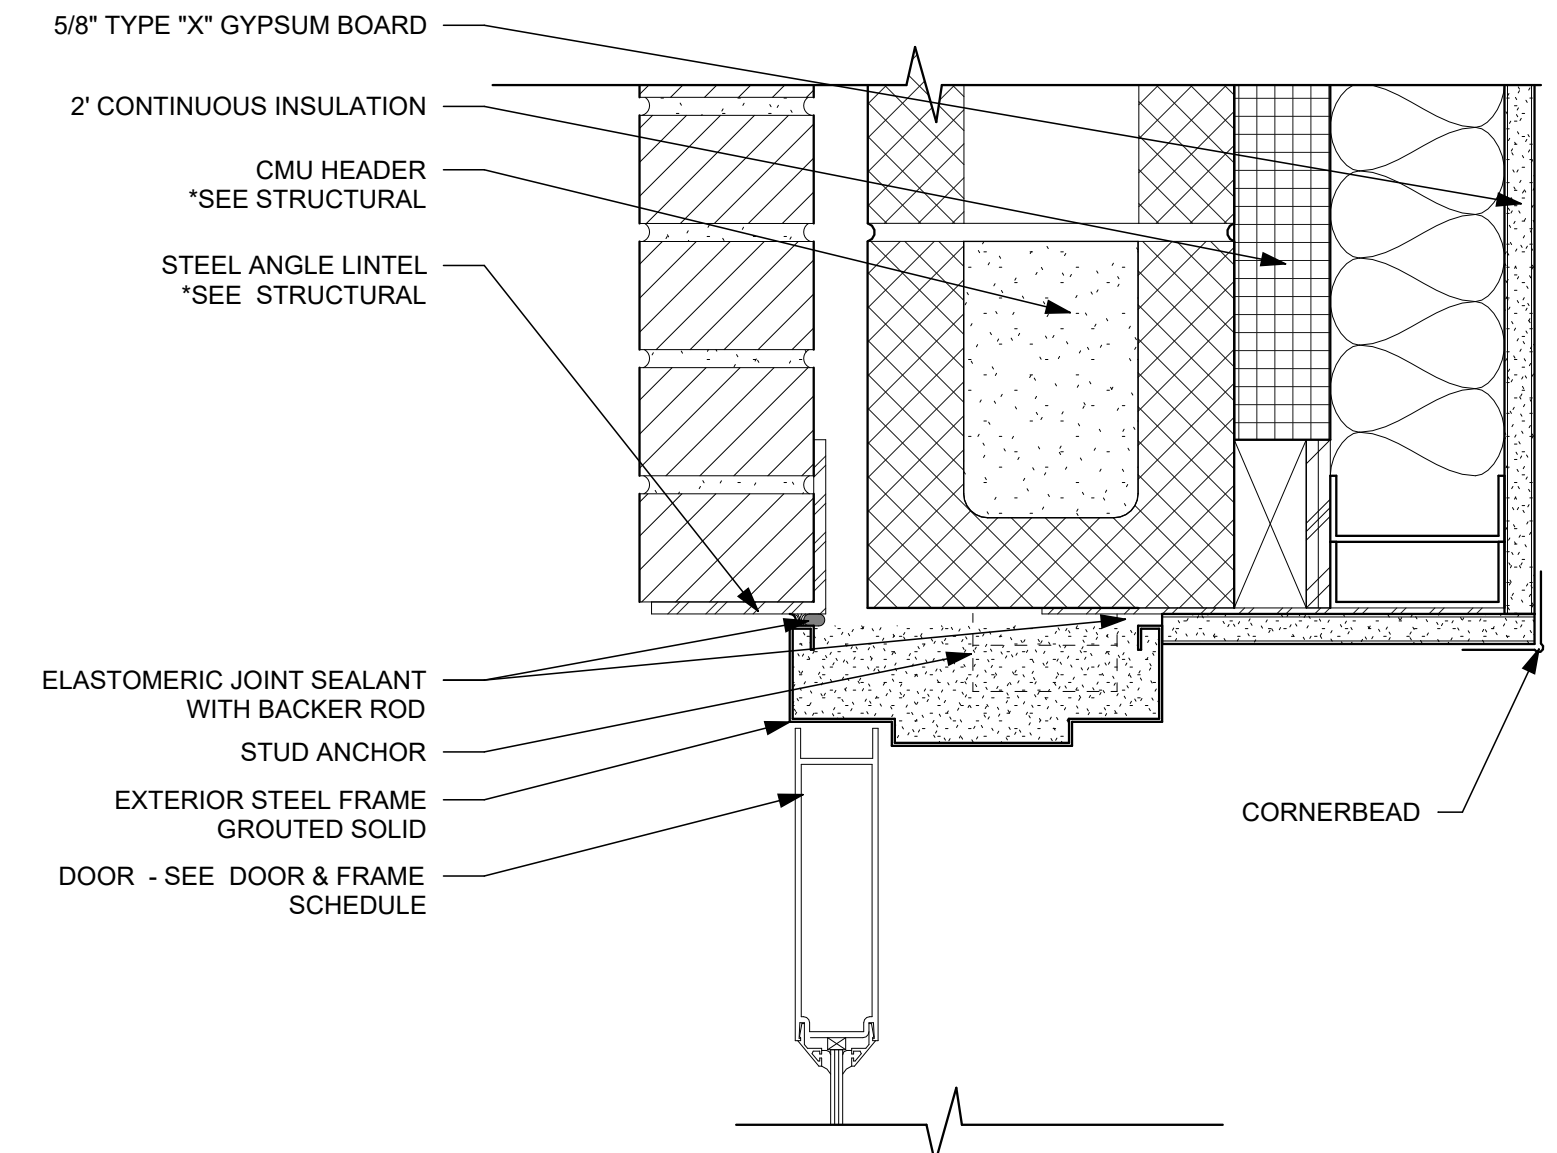


**D5** DOOR HEAD DETAIL - BRICK (STOREFRONT)  
3" = 1'-0"


E

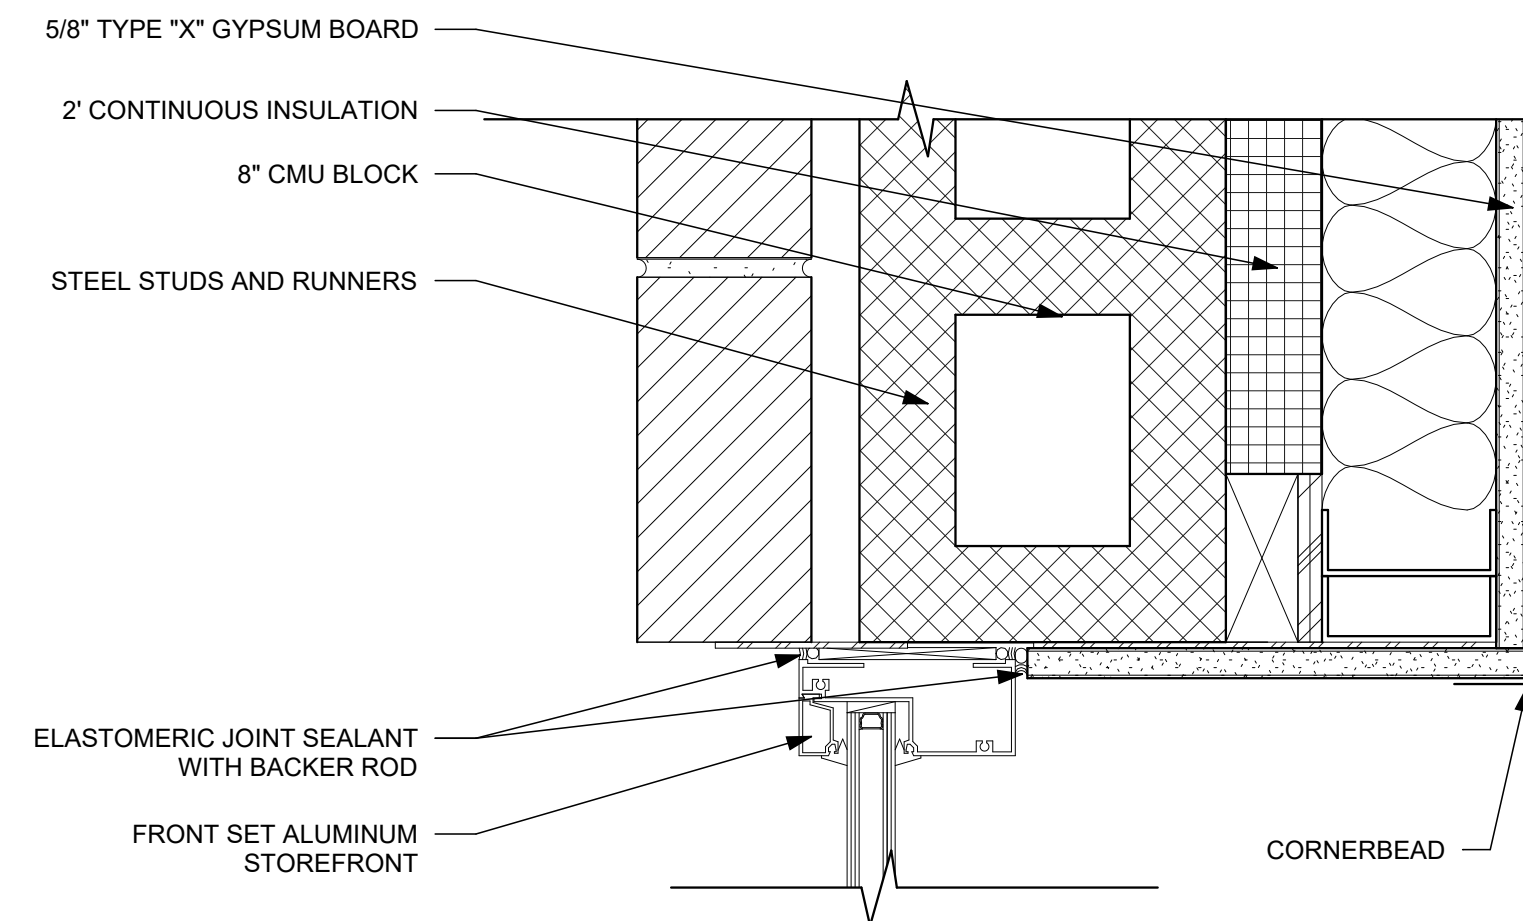

**F1** WINDOW (SF-3) JAMB DETAIL - BRICK  
3" = 1'-0"

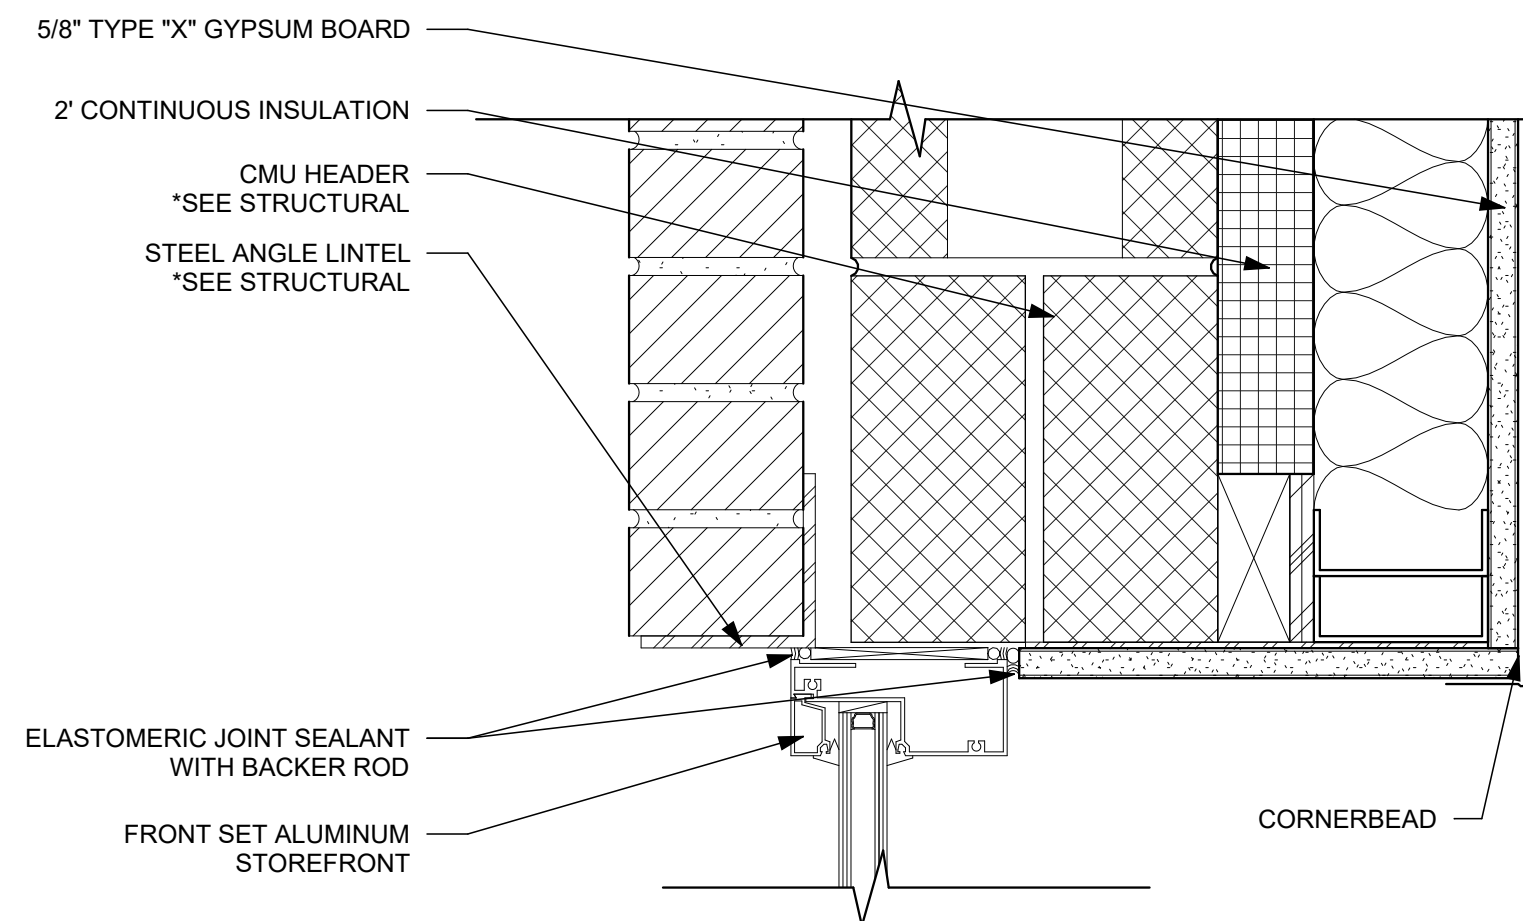

**F3** WINDOW (SF-3) HEAD DETAIL - BRICK  
3" = 1'-0"

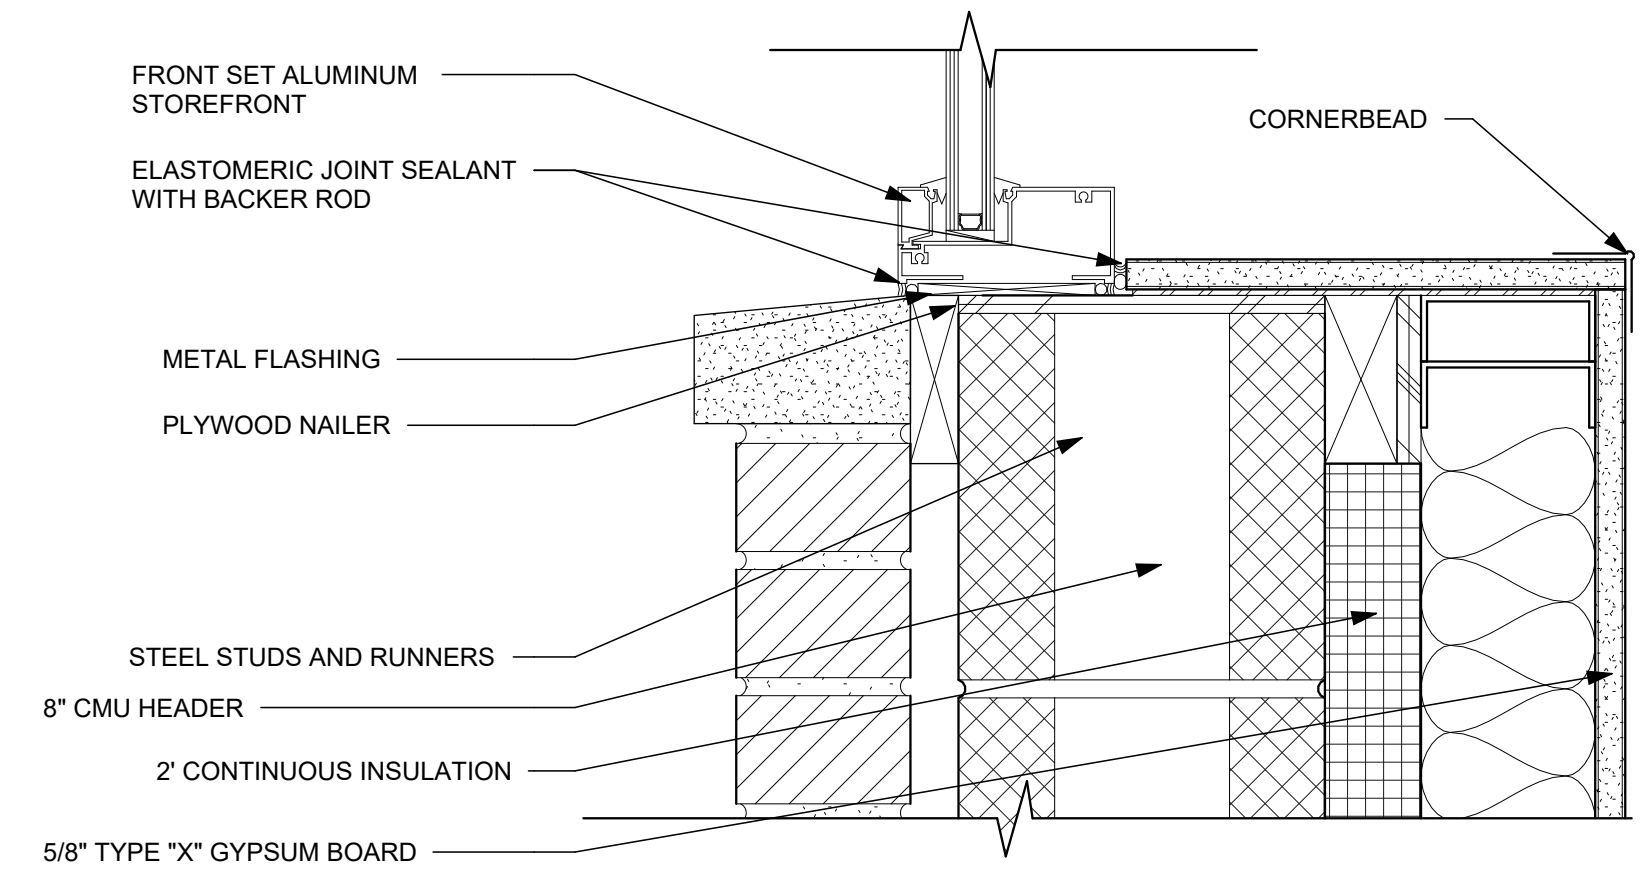

**F5** WINDOW SILL DETAIL - BRICK (STOREFRONT)  
3" = 1'-0"

A

B

C

D

E

F

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ARCHITECT  
12147  
REGISTERED  
Todd A. Gindeberger, License #12147  
Expiration Date 12/31/2027

**Harrison Township District 10  
Sheriff Substation Renovation**

6001 N Dixie Dr, Dayton, OH 45414

ISSUE		
NO.	DATE	DESCRIPTION
01/22/2026	FOR CONSTRUCTION	

DATE	01/22/2026
JOB NO.	4325.00
DRAWN	SEP
CHECKED	RFW
COPYRIGHT © 2026 - App Architecture, Inc.	
TITLE DOOR AND WINDOW DETAILS	
SHEET NO. <b>A0.6</b>	



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A


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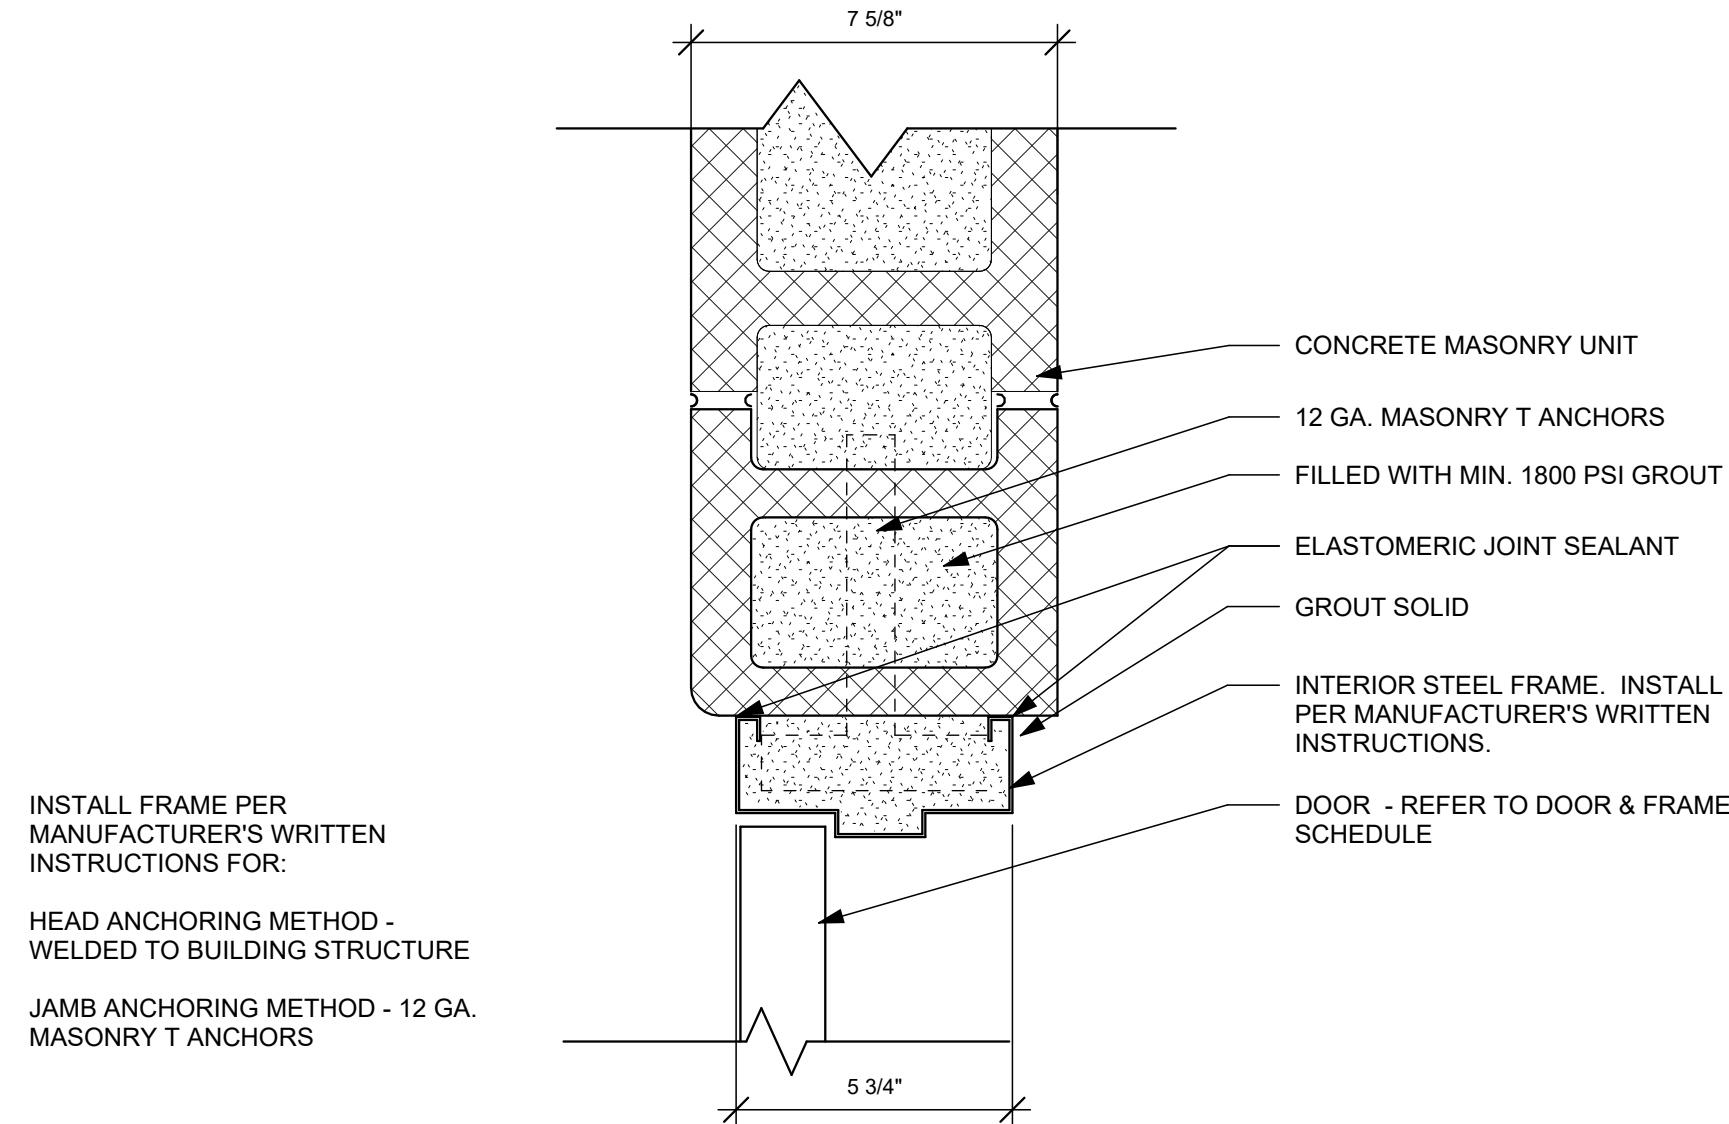
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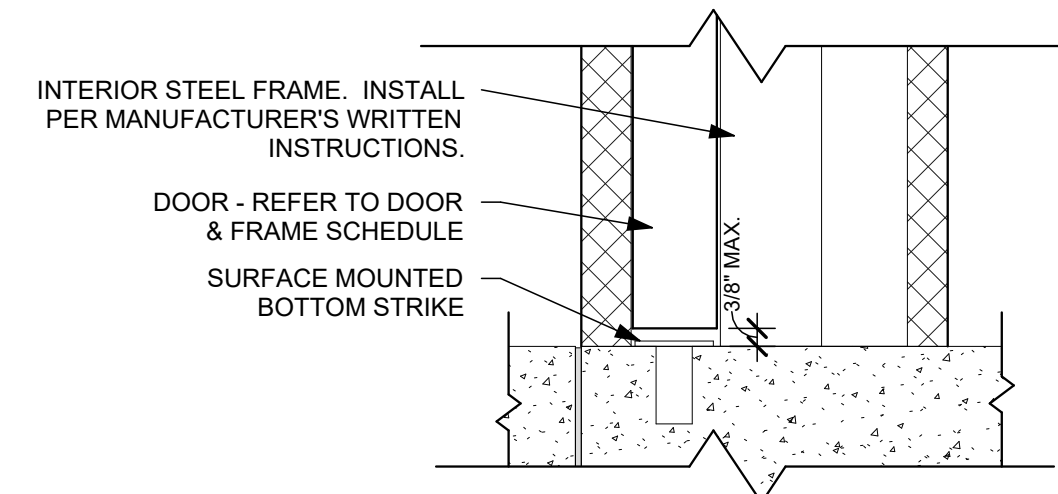


**C1 HEAD DETAIL - CMU WALL (STORM SHELTER)**  
3" = 1'-0"




**C3 JAMB DETAIL - CMU (STORM SHELTER)**  
3" = 1'-0"


INSTALL FRAME PER  
MANUFACTURER'S WRITTEN  
INSTRUCTIONS FOR:  
HEAD ANCHORING METHOD -  
WELDED TO BUILDING STRUCTURE  
JAMB ANCHORING METHOD - 12 GA.  
MASONRY T ANCHORS

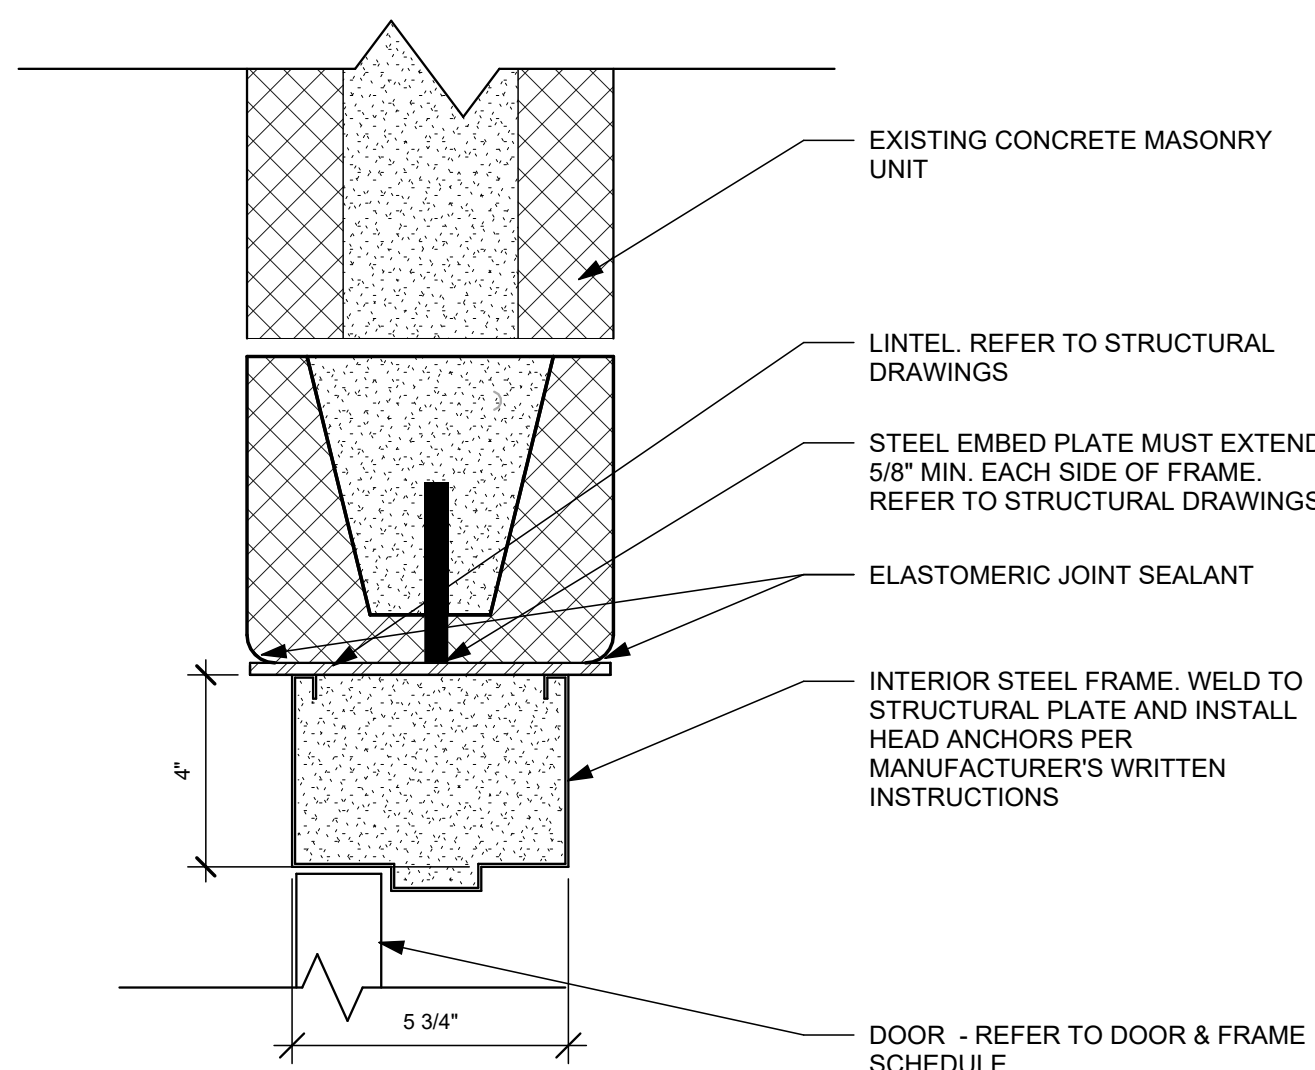


**C5 SILL DETAIL - HOLLOW METAL (STORM SHELTER)**  
3" = 1'-0"

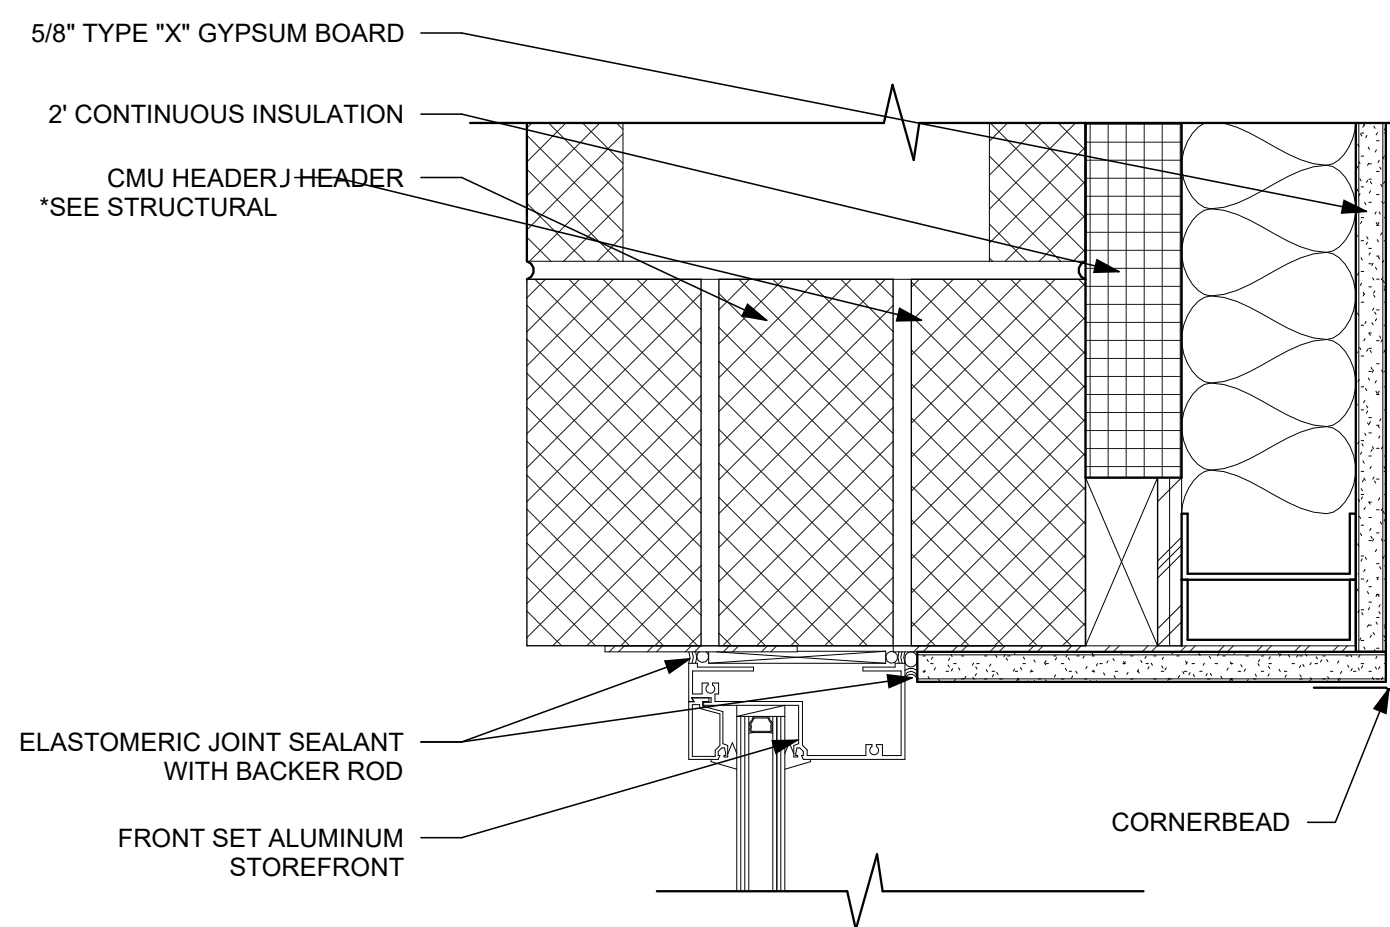


**E1 WINDOW (SF-3) HEAD DETAIL - BLOCK**  
3" = 1'-0"

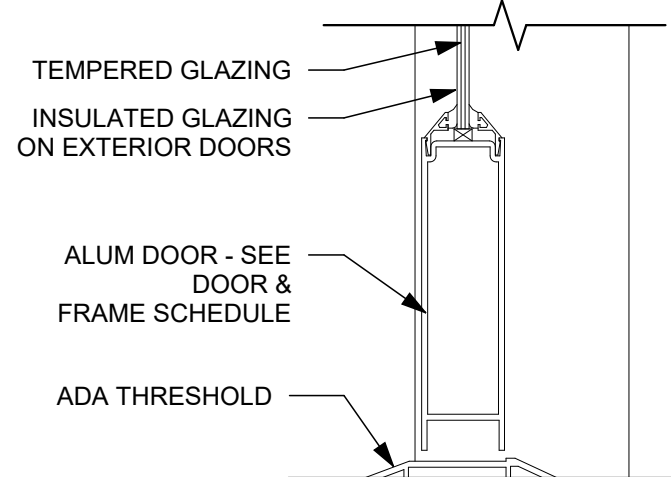


**E3 SILL DETAIL - EXISTING RELOCATED STOREFRONT**  
3" = 1'-0"

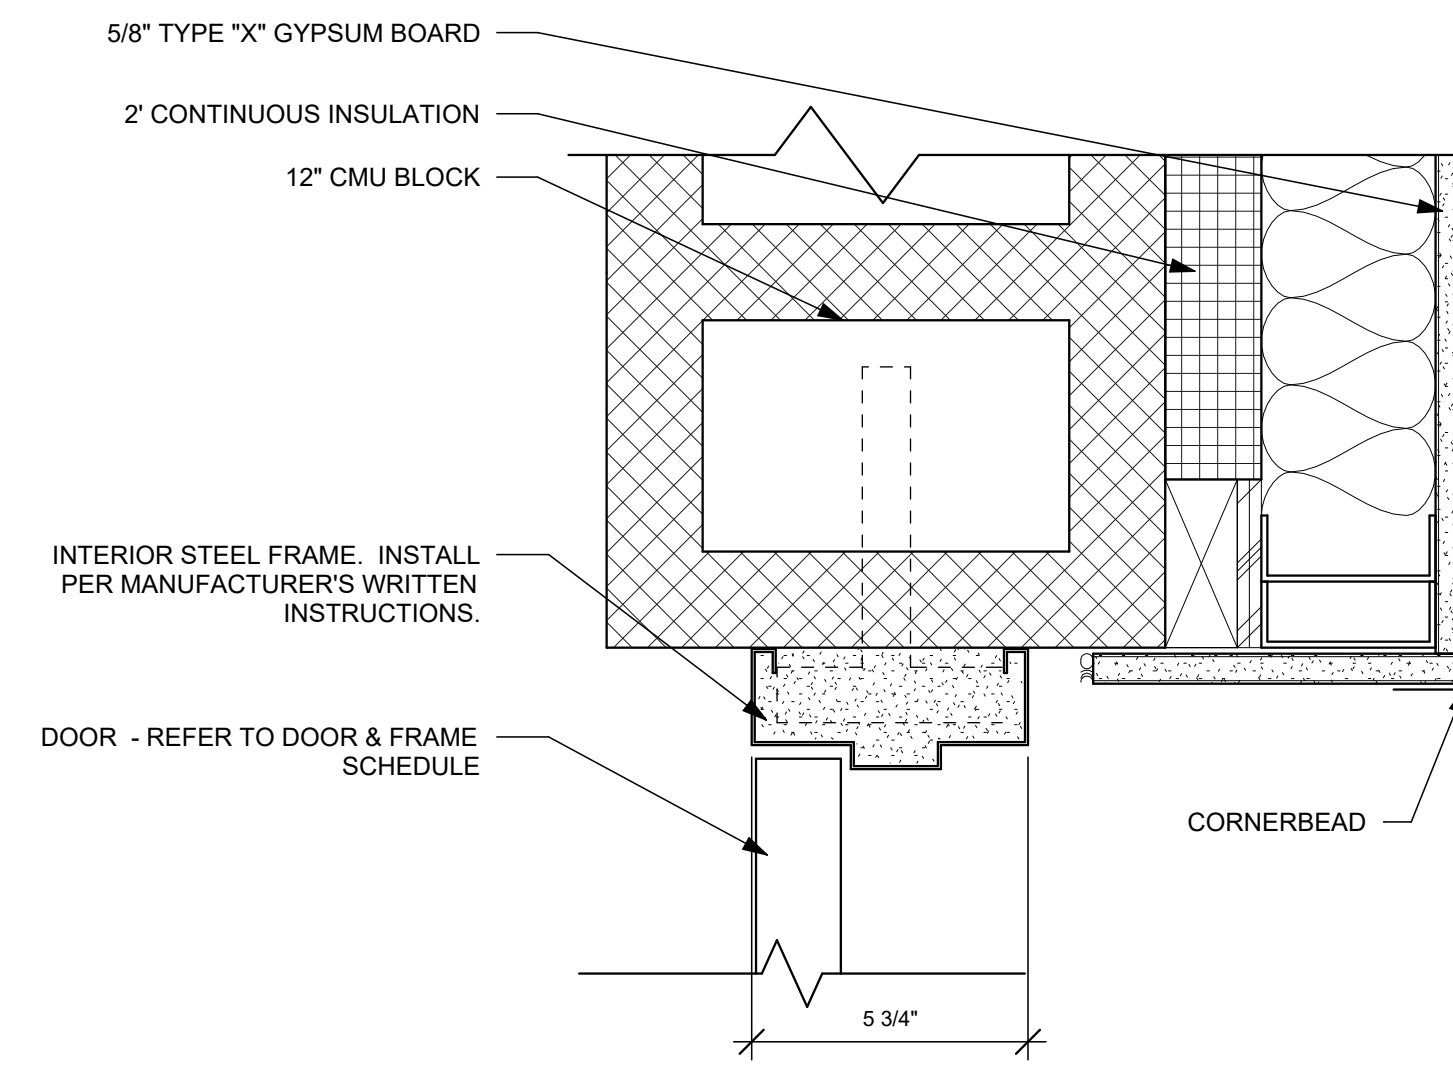


**E5 JAMB DETAIL - CMU**  
3" = 1'-0"

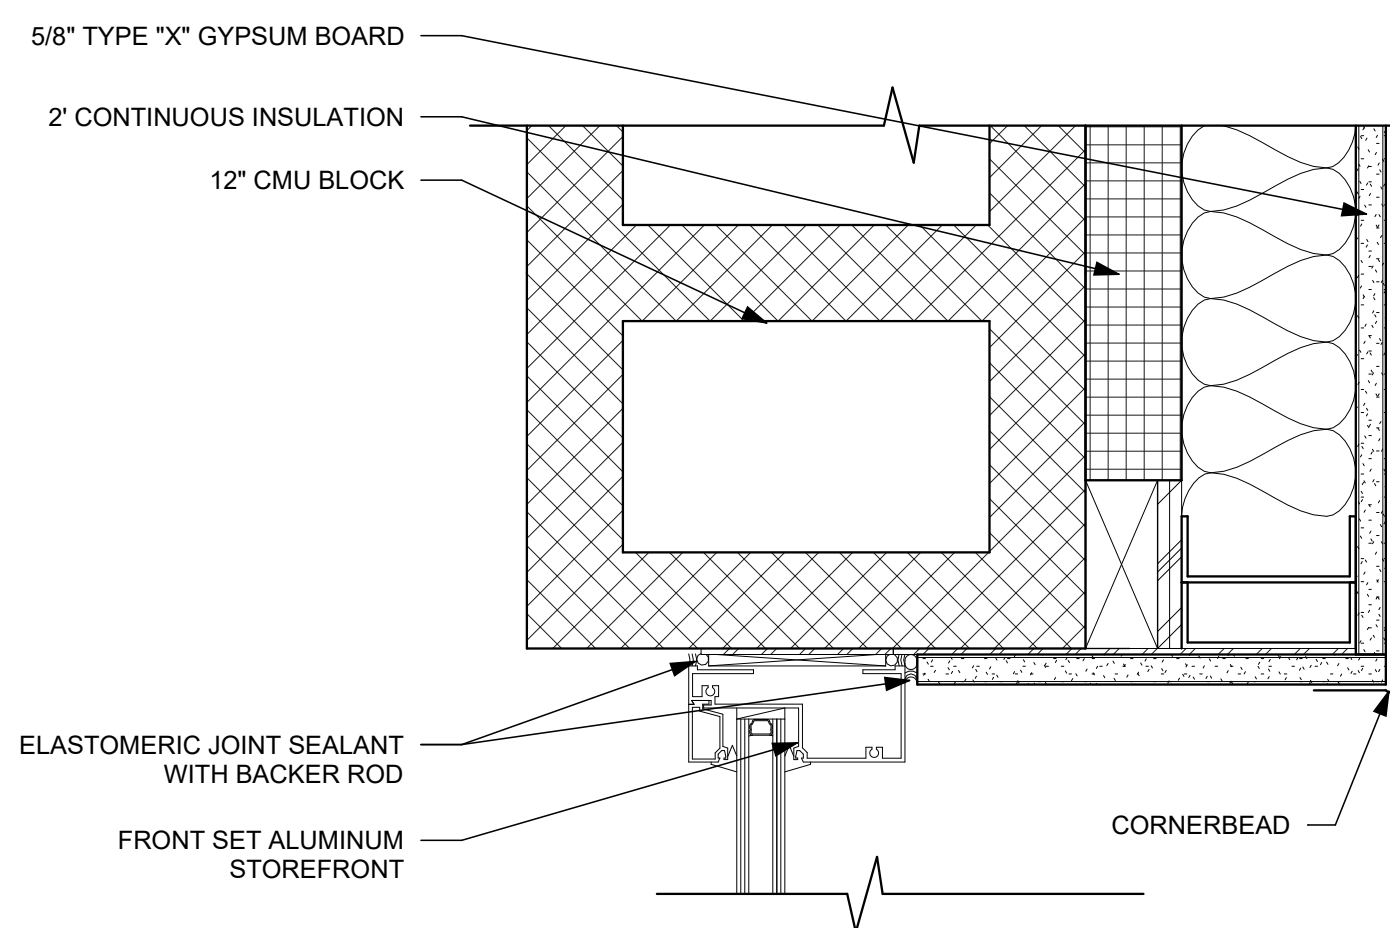

**F1 WINDOW (SF-3) JAMB DETAIL - BLOCK**  
3" = 1'-0"

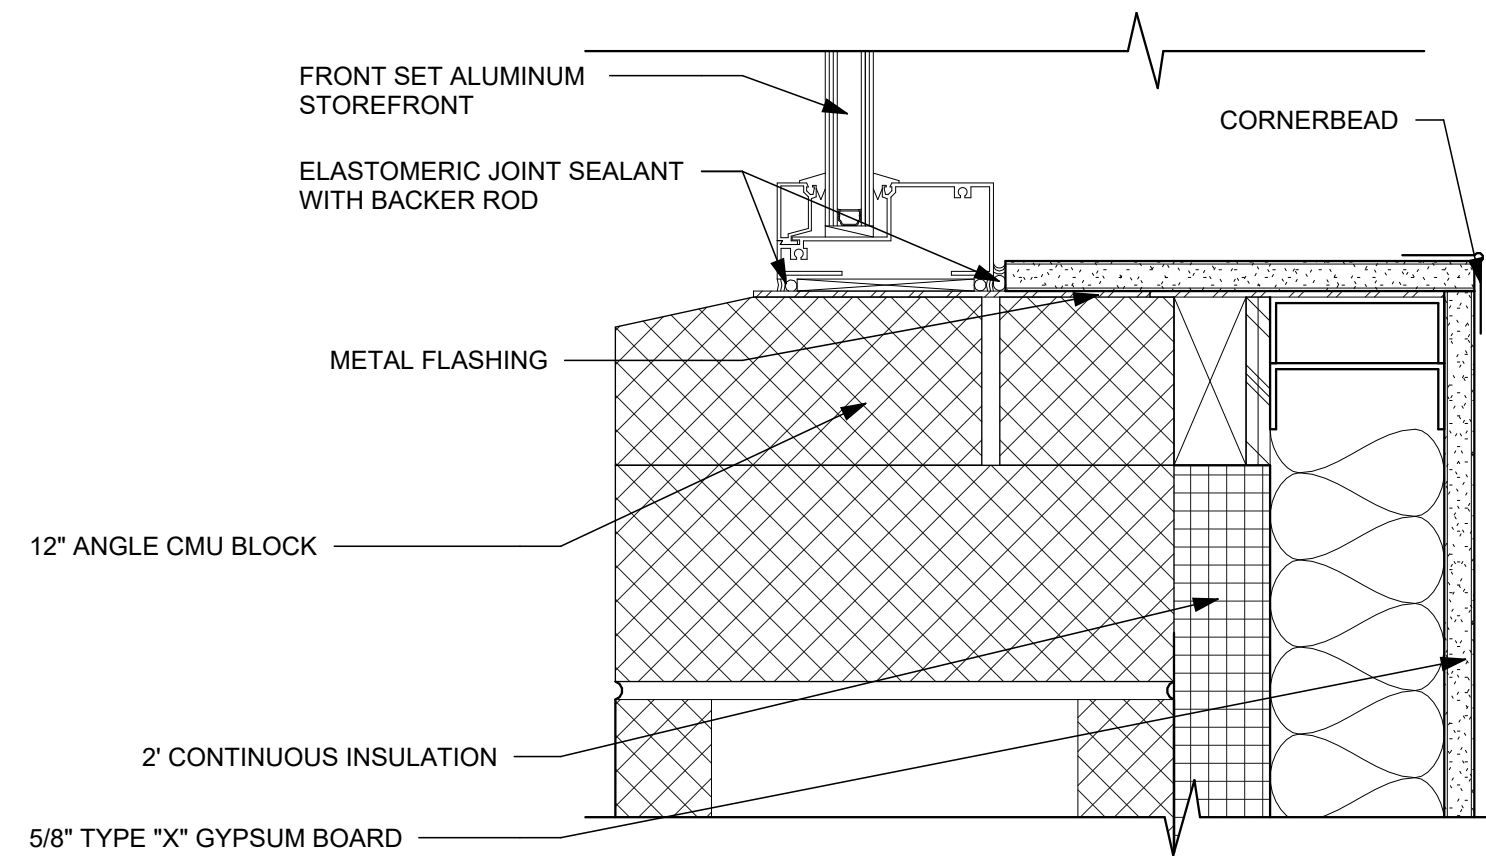

**F3 WINDOW (SF-3) SILL DETAIL - BLOCK**  
3" = 1'-0"

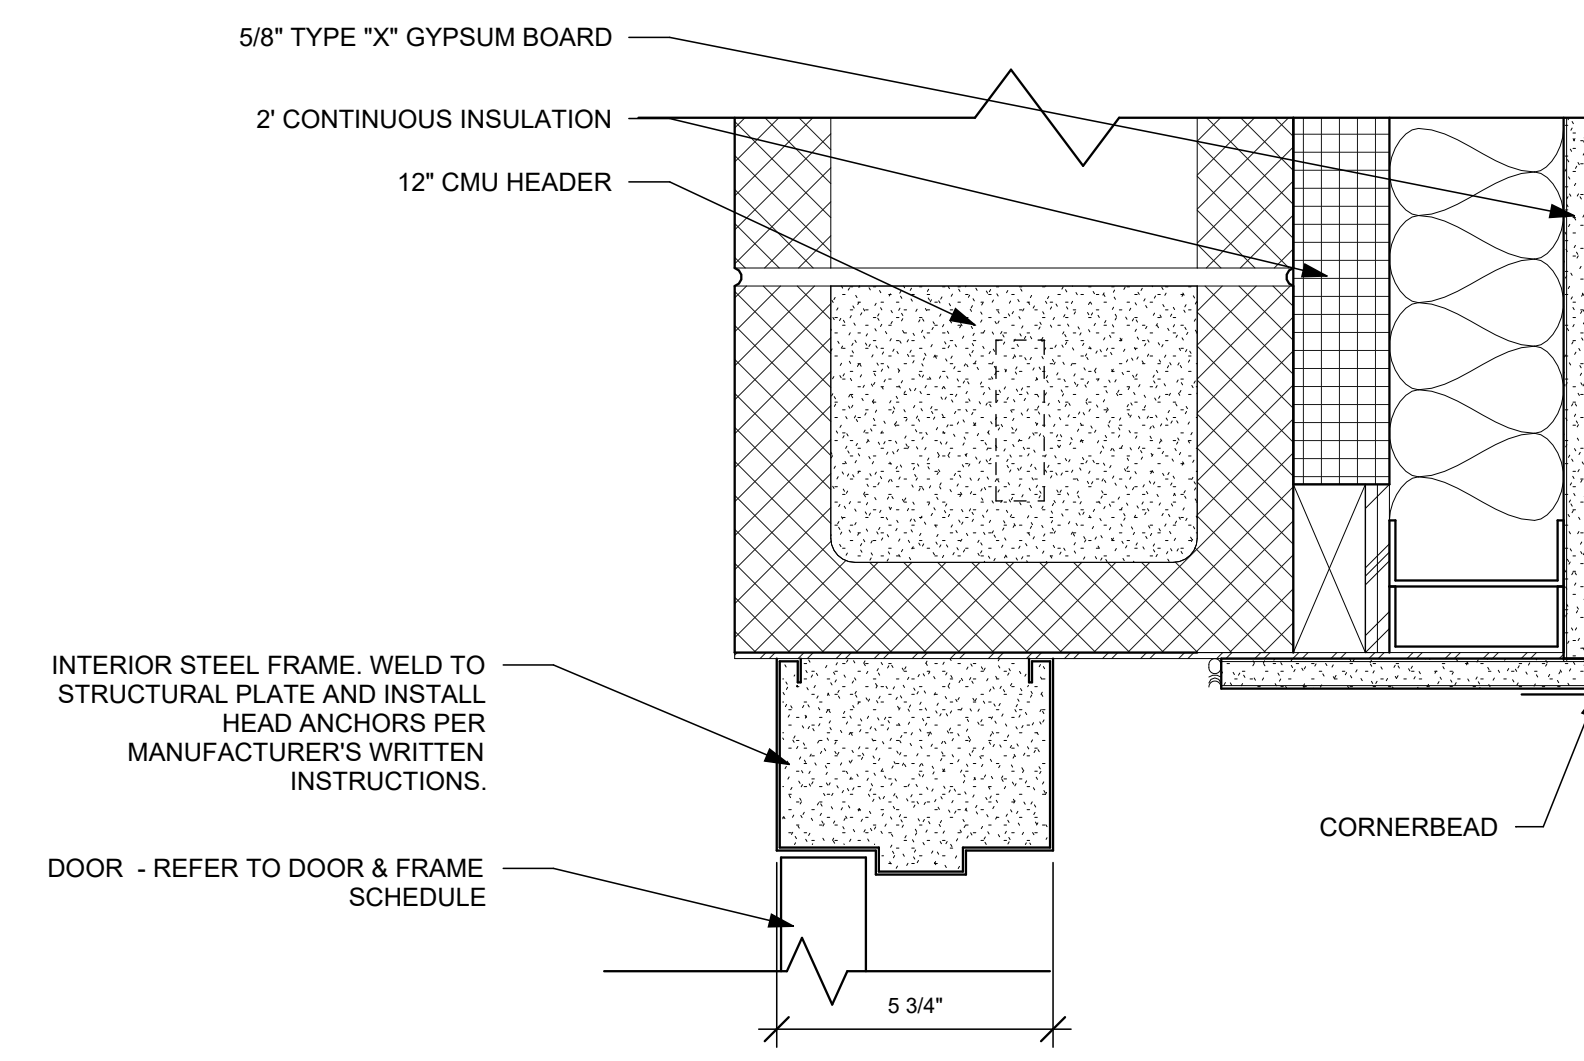

**F5 HEAD DETAIL - CMU WALL**  
3" = 1'-0"

A

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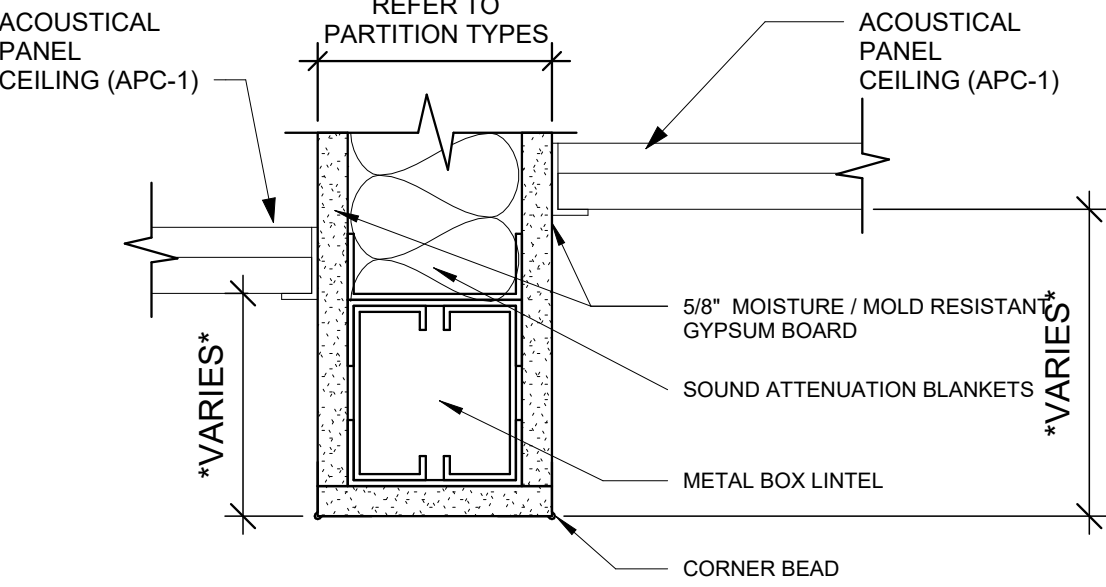
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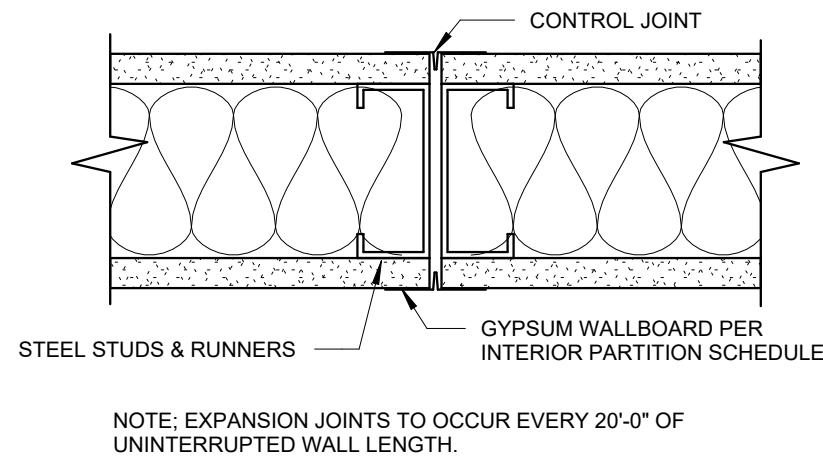
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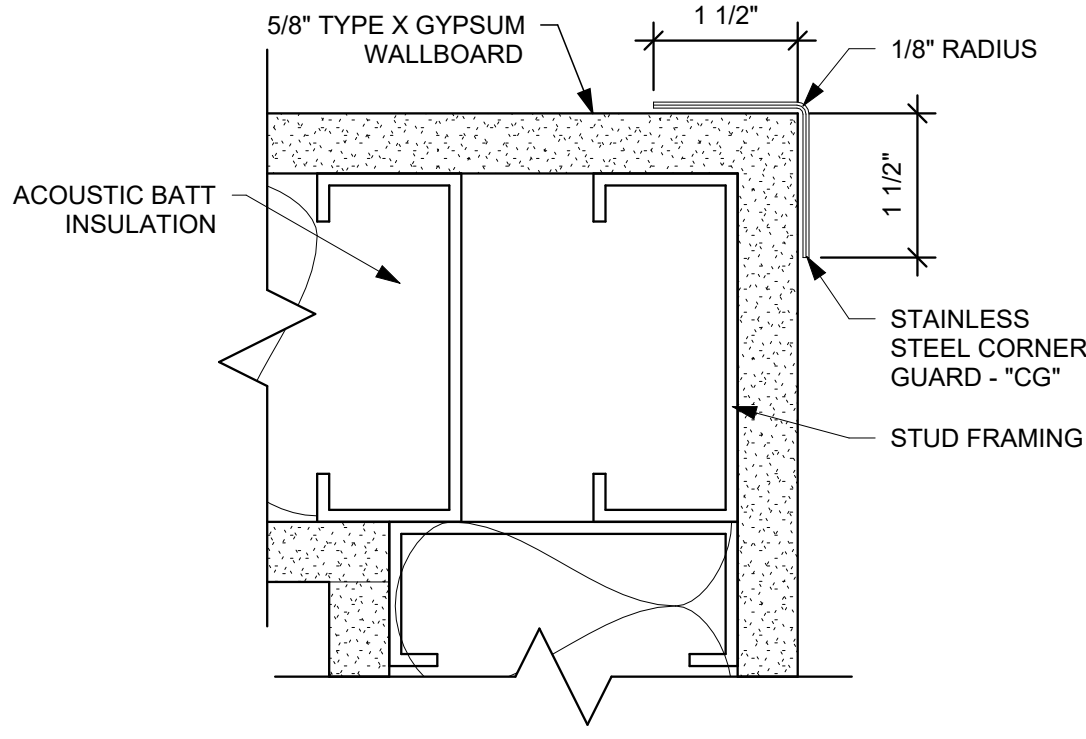
A  
B  
C  
D  
E  
F




**B1** TYP. BULKHEAD DETAIL  
3" = 1'-0"




**B3** TYP. GWB EXPANSION DETAIL  
3" = 1'-0"




**B4** CG-1 CORNER GUARD  
6" = 1'-0"

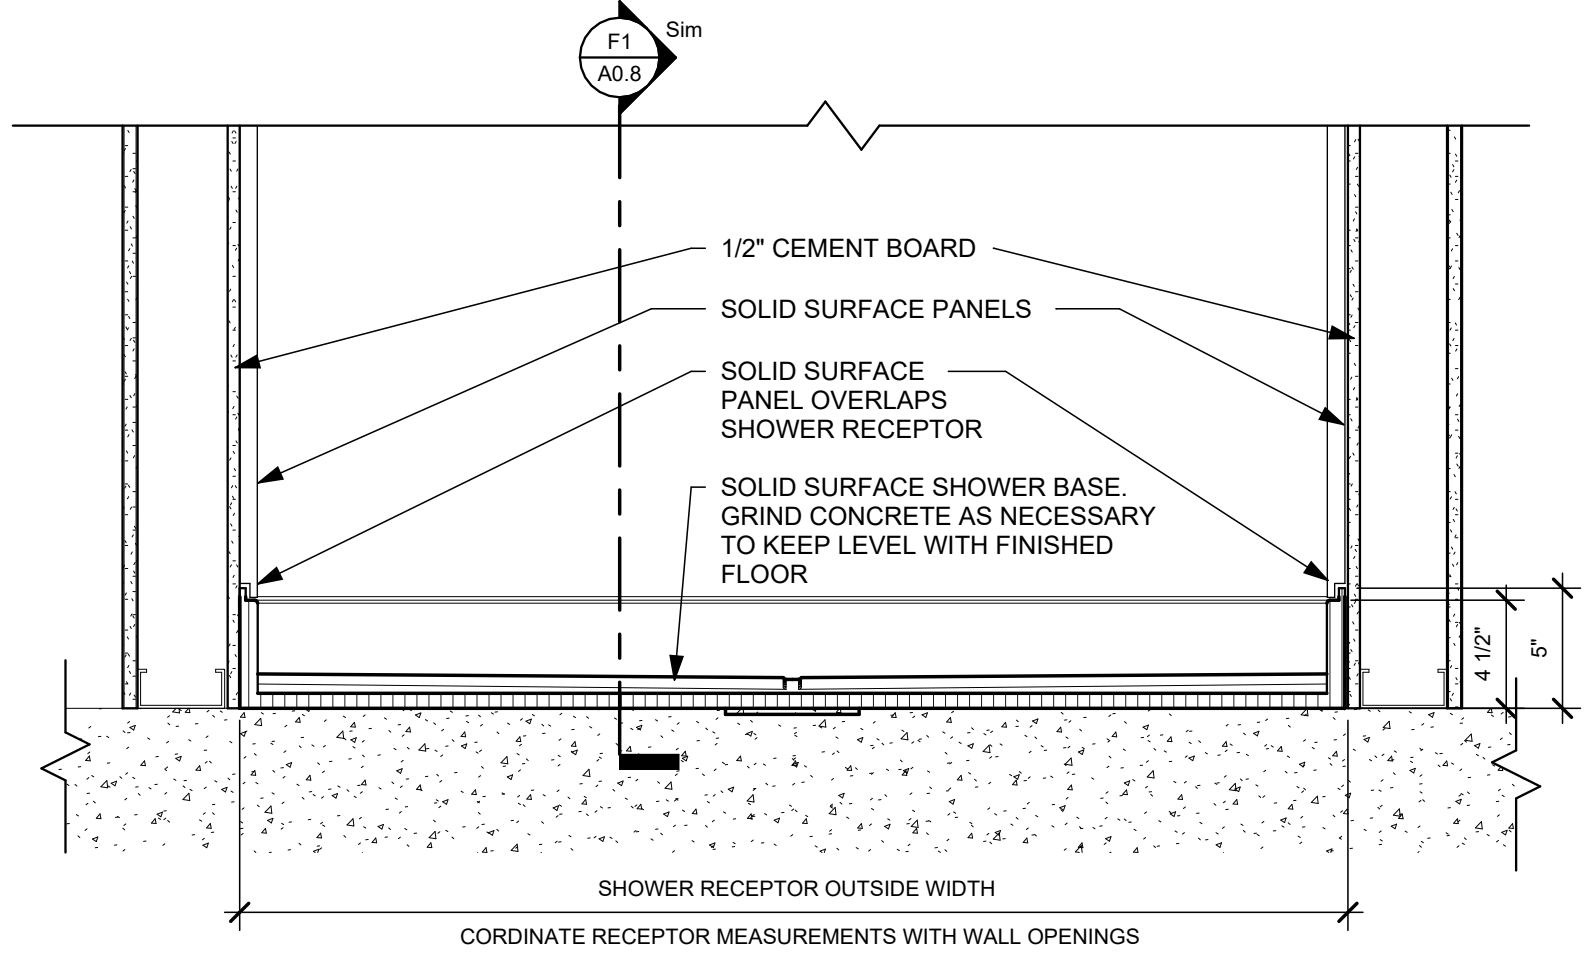

**D1** TYP. SHOWER RECEPTOR DETAIL  
1 1/2" = 1'-0"

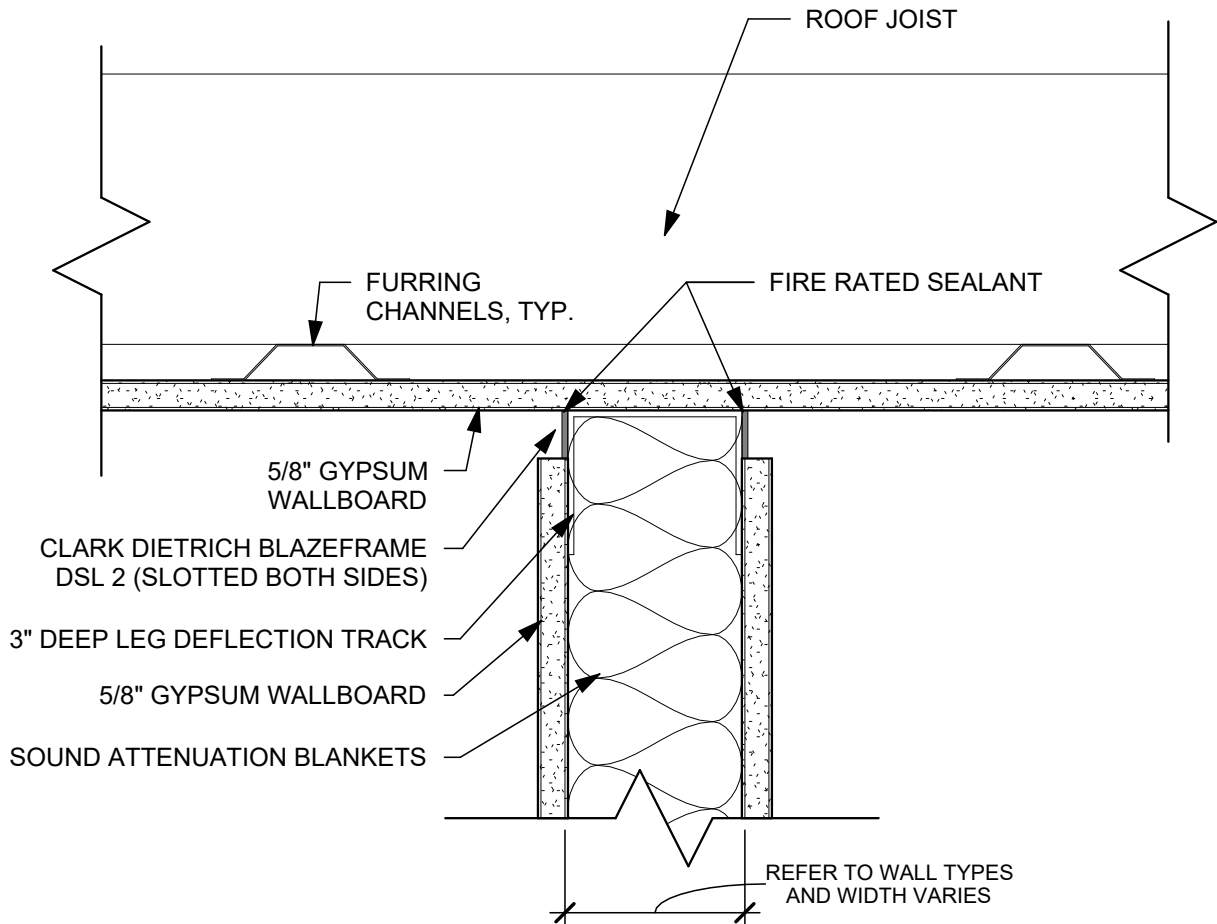

**D4** TYPICAL DEFLECTION TRACK DETAIL  
3" = 1'-0"

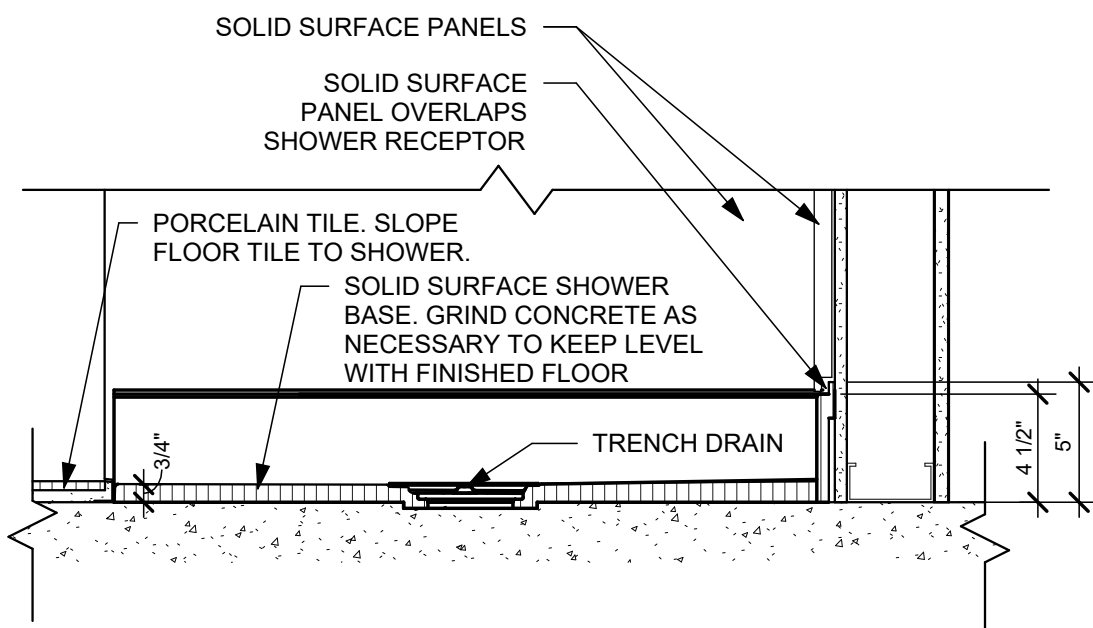

**F1** TYP. SHOWER RECEPTOR DETAIL SECTION  
1 1/2" = 1'-0"

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TODD A. GINDEBERGER  
ARCHITECT  
12147  
REGISTERED  
Expiration Date 12/31/2027

**Harrison Township District 10  
Sheriff Substation Renovation**

6001 N Dixie Dr, Dayton, OH 45414

ISSUE		
NO.	DATE	DESCRIPTION
01/22/2026 FOR CONSTRUCTION		


DATE	01/22/2026
JOB NO.	4325.00
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CHECKED	RFW

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TITLE  
**INTERIOR DETAILS**

SHEET NO.  
**A0.8**



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**E1** DEMOLITION PLAN  
1/8" = 1'-0"
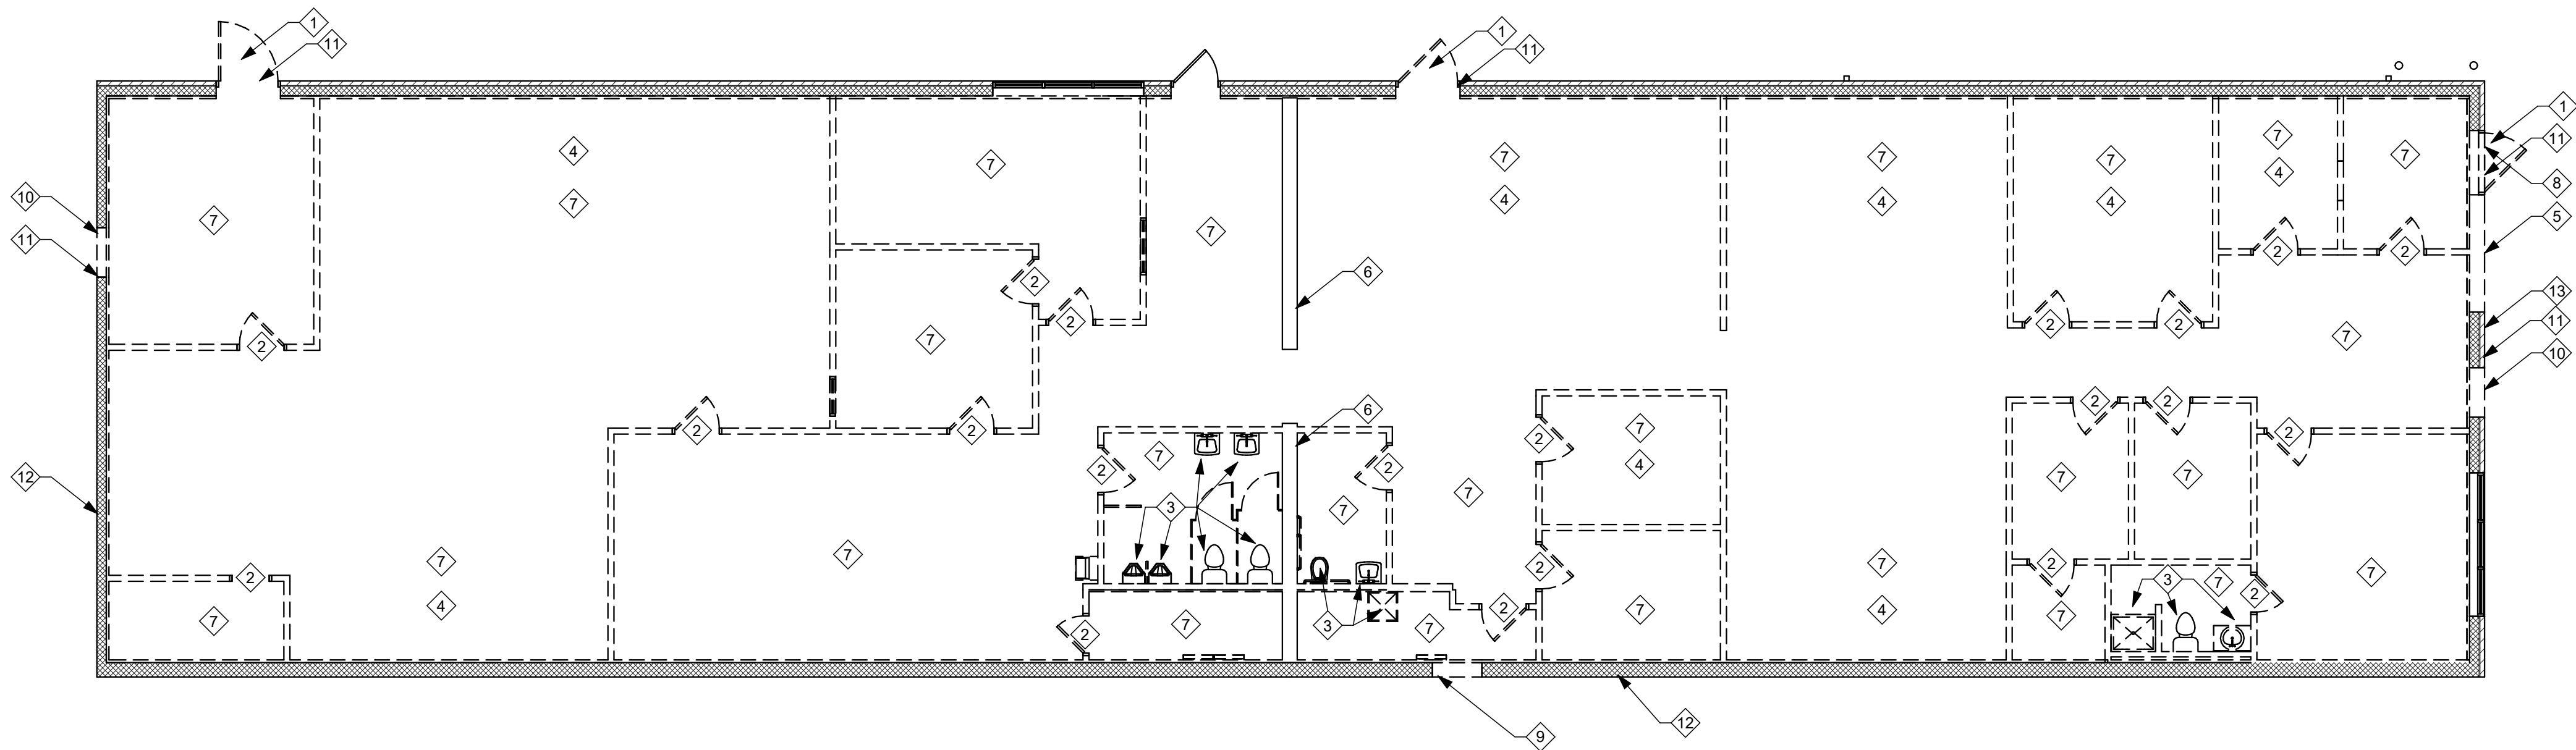
## DEMOLITION NOTES

 INDICATES DEMOLITION NOTE.

- REMOVE EXISTING DOOR AND FRAME TO RELOCATE. INFILL TO MATCH EXISTING EXTERIOR WALL TYPE AND CONSTRUCTION. REFER TO SHEET A1.1 FOR RELOCATION.
- REMOVE EXISTING DOOR AND FRAME.
- REMOVE EXISTING PLUMBING FIXTURES. REFER TO PLUMBING DRAWINGS.
- REMOVE EXISTING CASEWORK AND WALL FIXTURES.
- REMOVE PORTION OF EXISTING WALL FOR NEW STOREFRONT. REFER TO SHEET A1.1.
- PRESERVE EXISTING MASONRY WALL, REMOVE FURRING.
- REMOVE EXISTING FLOOR FINISH. CLEAN AND PREPARE SLAB BELOW FOR NEW FLOORING MATERIAL.
- REMOVE EXISTING CANOPY.
- REMOVE PORTION OF EXISTING WALL FOR NEW DOOR.
- REMOVE PORTION OF EXISTING WALL FOR DOOR RELOCATION.
- REPAIR BRICK EXTERIOR AFTER REMOVAL TO MATCH EXISTING.
- BLOCK WALLS. ALLOW FOR 200 SF OF REPAIR. PROVIDE SF ALLOWANCE FOR ADDITIONAL TUCKPOINTING AS REQUIRED.
- REMOVE EXISTING WINDOW (SF-1) AND FRAME TO RELOCATE. INFILL TO MATCH EXISTING EXTERIOR WALL TYPE AND CONSTRUCTION. REFER TO SHEET A1.1 FOR RELOCATION.

## GENERAL NOTES

- PRIOR TO DEMOLITION, FIELD INVESTIGATE EXISTING CONDITIONS AND NOTIFY ARCHITECT AND OWNER OF ANY DISCREPANCIES.
- PRIOR TO DEMOLITION, VERIFY THAT EXISTING UTILITIES HAVE BEEN DISCONNECTED AND CAPPED, AND TEMPORARY SHORING IS IN PLACE TO PREVENT MOVEMENT, SETTLEMENT, OR COLLAPSE OF CONSTRUCTION.
- REFER TO MECHANICAL, PLUMBING, ELECTRICAL AND STRUCTURAL DRAWINGS FOR ADDITIONAL DEMOLITION WORK.
- REPAIR, LEVEL, AND PREPARE EXISTING CONCRETE FLOOR SLABS TO RECEIVE NEW FLOOR FINISH. REFER TO ARCHITECTURAL ROOM FINISH SCHEDULE AND SPECIFICATIONS FOR ADDITIONAL INFORMATION.
- PRIOR TO DISPOSAL OF EXISTING EQUIPMENT AND/OR FIXTURES COORDINATE WITH OWNER.
- CONTRACTOR(S) SHALL BE RESPONSIBLE FOR REMOVING ALL CONSTRUCTION DEBRIS FROM JOB SITE IN A LEGAL AND TIMELY MANNER. LOCATION(S) OF JOBSITE DUMPSTER SHALL BE COORDINATED WITH OWNER PRIOR TO START OF CONSTRUCTION.

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## Harrison Township District 10 Sheriff Substation Renovation

6001 N Dixie Dr, Dayton, OH 45414

### ISSUE

NO.	DATE	DESCRIPTION
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01/22/2026 FOR CONSTRUCTION

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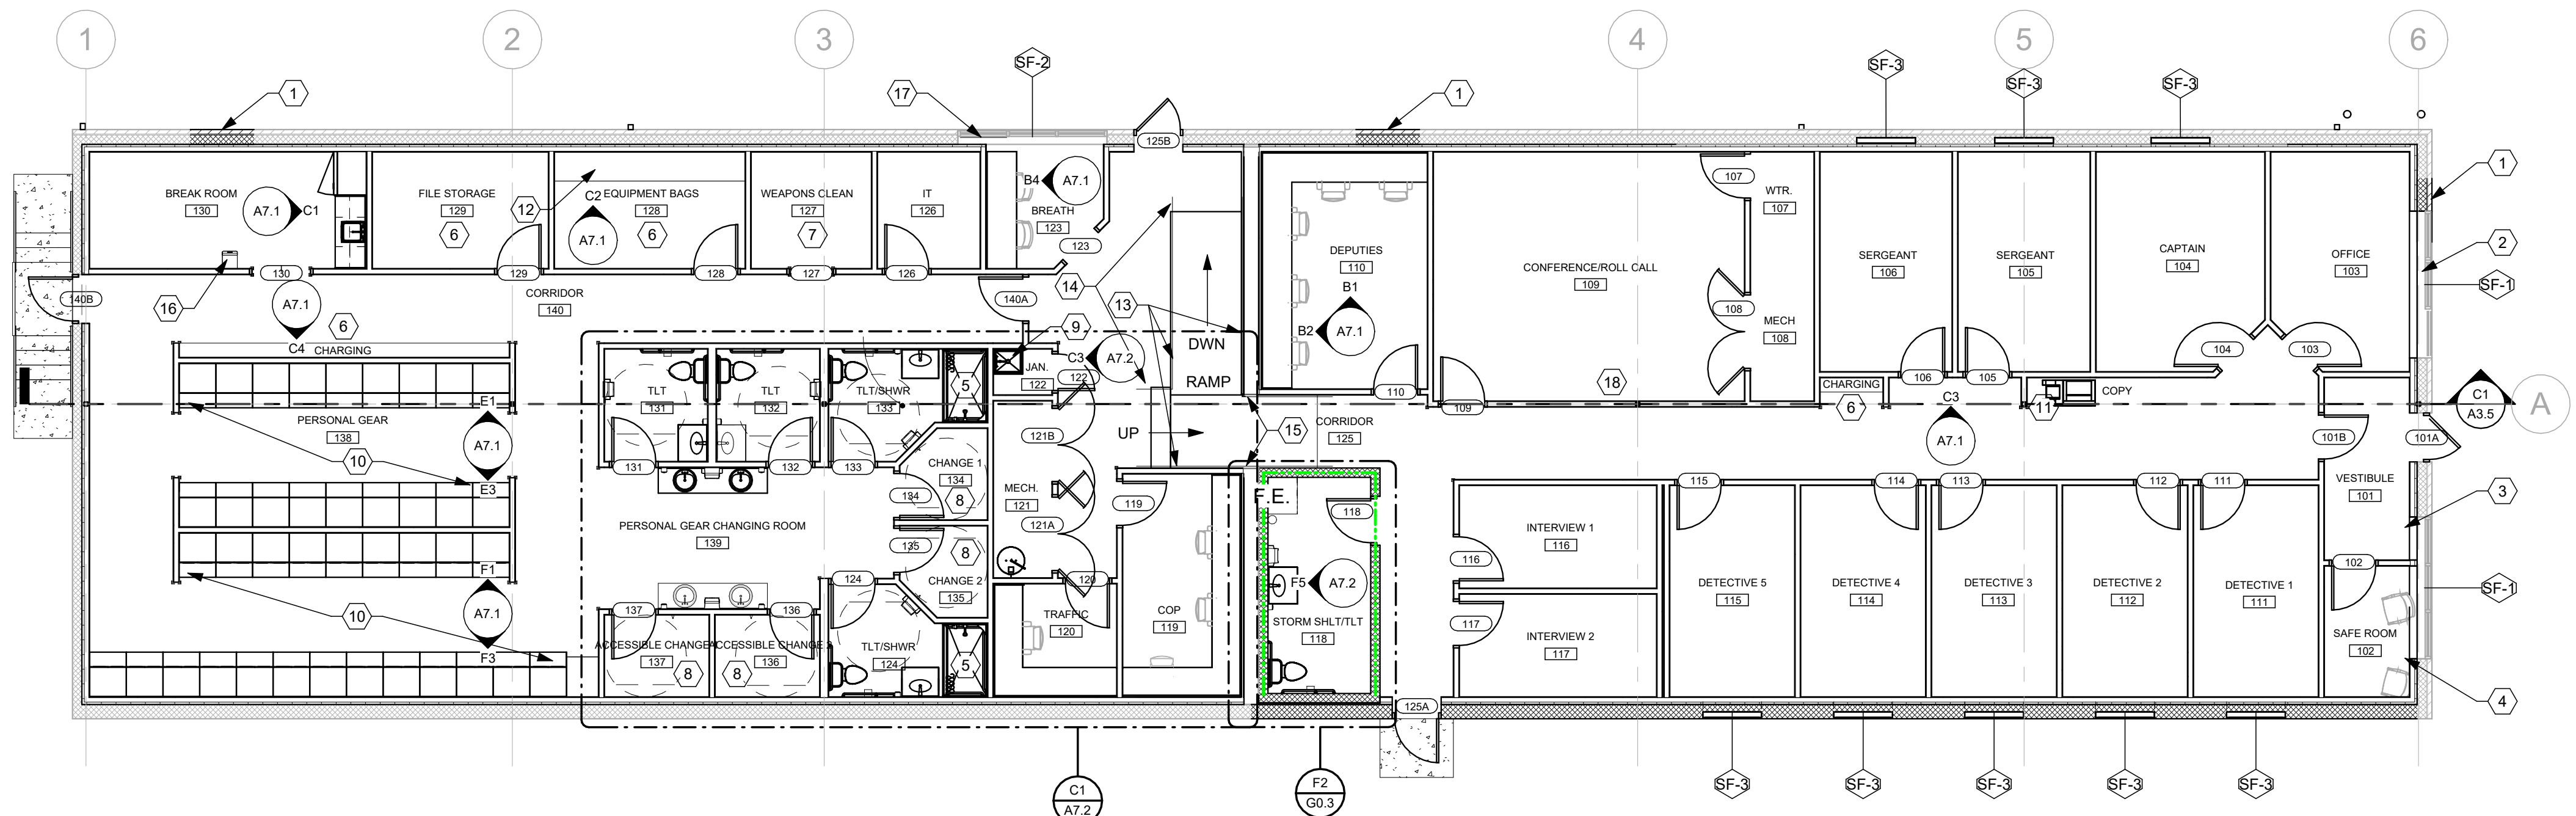
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TITLE  
**DEMOLITION PLAN**

SHEET NO.

**A1.0**





E1 REFERENCE PLAN  
1/8" = 1'-0"

## CONSTRUCTION NOTES

- 00 INDICATES CONSTRUCTION NOTE.
- EXTERIOR INFILL. REFER TO SHEET A1.0.
  - RELOCATE. REFER TO SHEET A1.0.
  - NOT USED.
  - SAFE ROOM. INSTALL EMERGENCY LOCK AND 911 CALL BOX.
  - SHOWER PAN RECESSED IN CONCRETE. SHOWER PAN ACTS AS FLOOR DRAIN FOR ROOM.
  - WALL MOUNTED SHELVES. REFER TO CASEWORK DETAILS ON A8.2.
  - WALL MOUNTED SECURE FIREARM RACK. REFER TO INTERIOR ELEVATIONS FOR DETAILS.
  - ADA CHANGING BENCH 20" x 42". 17 1/2" HEIGHT.
  - MOP SINK WITH MOP HOLDERS ABOVE. REFER TO PLUMBING DRAWINGS.
  - GEAR LOCKERS WITH POWER HOOKUPS. COORDINATE WITH ELECTRICAL DRAWINGS.
  - ALCOVE FOR COPIER.
  - HEAVY DUTY TACTICAL GEAR SHELF. REFER T CASEWORK DETAILS ON SHEET A8.1.
  - EXISTING FLOOR MOUNTED HANDRAILS TO BE RETAINED AND PAINTED P-1. PROVIDE 1 1/2" SPACING BETWEEN RAILS AND WALLS TO BE BUILT.
  - EXISTING FLOOR MOUNTED HANDRAIL RETAIN AND PAINT. ADD EXTENSION ALONG LENGTH OF STEPS. MATCH EXISTING.
  - REMOVE EXISTING WALL MOUNT HANDRAIL AND RE-INSTALL TO NEW WALLS. EXTEND ALONG STEPS. PAINT TO MATCH EXISTING CONDITIONS.
  - DRINKING WATER DISPENSER.
  - APPLY OPAQUE 3M FILM TO INSIDE FACE OF GLAZING PANE.
  - RELOCATED EXISTING MAILBOXES. COORDINATE WITH OWNER.

## GENERAL NOTES

- ALL INTERIOR PARTITIONS ARE TYPE A1 U.N.O. UNLESS OTHERWISE NOTED.
- ALL PARTITIONS ARE TO BE BRACED TO STRUCTURE ABOVE U.N.O.
- PROVIDE FIRE RETARDANT WOOD BLOCKING BEHIND ALL WALL HUNG ACCESSORIES, CABINETS, FURNISHINGS, HANDRAILS U.N.O.
- REFER TO INTERIOR ELEVATIONS FOR TOILET ROOM ACCESSORY CALLOUTS.
- FOR EXTERIOR PAD REFER TO SHEET G0.2.
- REFER TO FINISHED FLOOR PLAN FOR CORNER GUARD AND END WALL GUARD LOCATIONS.
- ALL EXPOSED STRUCTURAL STEEL TO BE EPOXY PAINTED.
- DIMENSIONS ARE FROM FINISHED FACE TO FINISHED FACE U.N.O.
- FURNITURE AND EQUIPMENT SHOWN FOR REFERENCE ONLY.
- HINGE SIDE OF DOORS ARE 6" FROM ADJACENT WALL U.N.O.

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# Harrison Township District 10 Sheriff Substation Renovation

6001 N Dixie Dr, Dayton, OH 45414

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TITLE	
REFERENCE PLAN	

SHEET NO.


# A1.1





- 1 ALIGN.
- 2 CONCRETE BOLLARD. REFER TO SHEET A5.1 FOR  
DETAILS.
- 3 REPAIR EXISTING FOUNDATION TO MATCH EXISTING  
EXTERIOR WALL TYPE. REFER TO STRUCTURAL  
DRAWINGS.
- 4 CENTER WALL ON MULLION.
- 5 PROVIDE 1/2" PLYWOOD BACKUP BEHIND GYP. BD. THIS  
WALL. SEE ALSO SHEET A8.1 F6.
- 6 HIGH ABUSE GYPSUM WALL BOARD THIS ROOM. SEE  
ALSO ROOM FINISH SCHEDULE.
- 7 PROVIDE BLINDS IN ROOM 102. COORDINATE WITH  
OWENR.

- A. ALL INTERIOR PARTITIONS ARE TYPE A1 U.N.O. UNLESS OTHERWISE NOTED.
- B. ALL PARTITIONS ARE TO BE BRACED TO STRUCTURE ABOVE U.N.O.
- C. PROVIDE FIRE RETARDANT WOOD BLOCKING BEHIND ALL HUNG ACCESSORIES, CABINETS, FURNISHINGS, HANDRAILS U.N.O.
- D. REFER TO INTERIOR ELEVATIONS FOR TOILET ROOM ACCESSORY CALLOUTS.
- E. FOR SIDEWALKS AND EXTERIOR PADS REFER TO CIVIL SITE AND LANDSCAPE PLANS.
- F. REFER TO FINISHED FLOOR PLAN FOR CORNER GUARD AND END WALL GUARD LOCATIONS.
- G. ALL EXPOSED STRUCTURAL STEEL TO BE EPOXY PAINTED.
- H. DIMENSIONS ARE FROM FINISHED FACE TO FINISHED FACE U.N.O.
- I. FURNITURE AND EQUIPMENT SHOWN FOR REFERENCE ONLY.
- J. HINGE SIDE OF DOORS ARE 6" FROM ADJACENT WALL U.N.O.

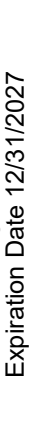

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22/2026 FOR CONSTRUCTION

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## 5. DIMENSION PLAN

ET NO.

## A1.2



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A

B

C

D

E

F

1

2


3

4

5

6

7

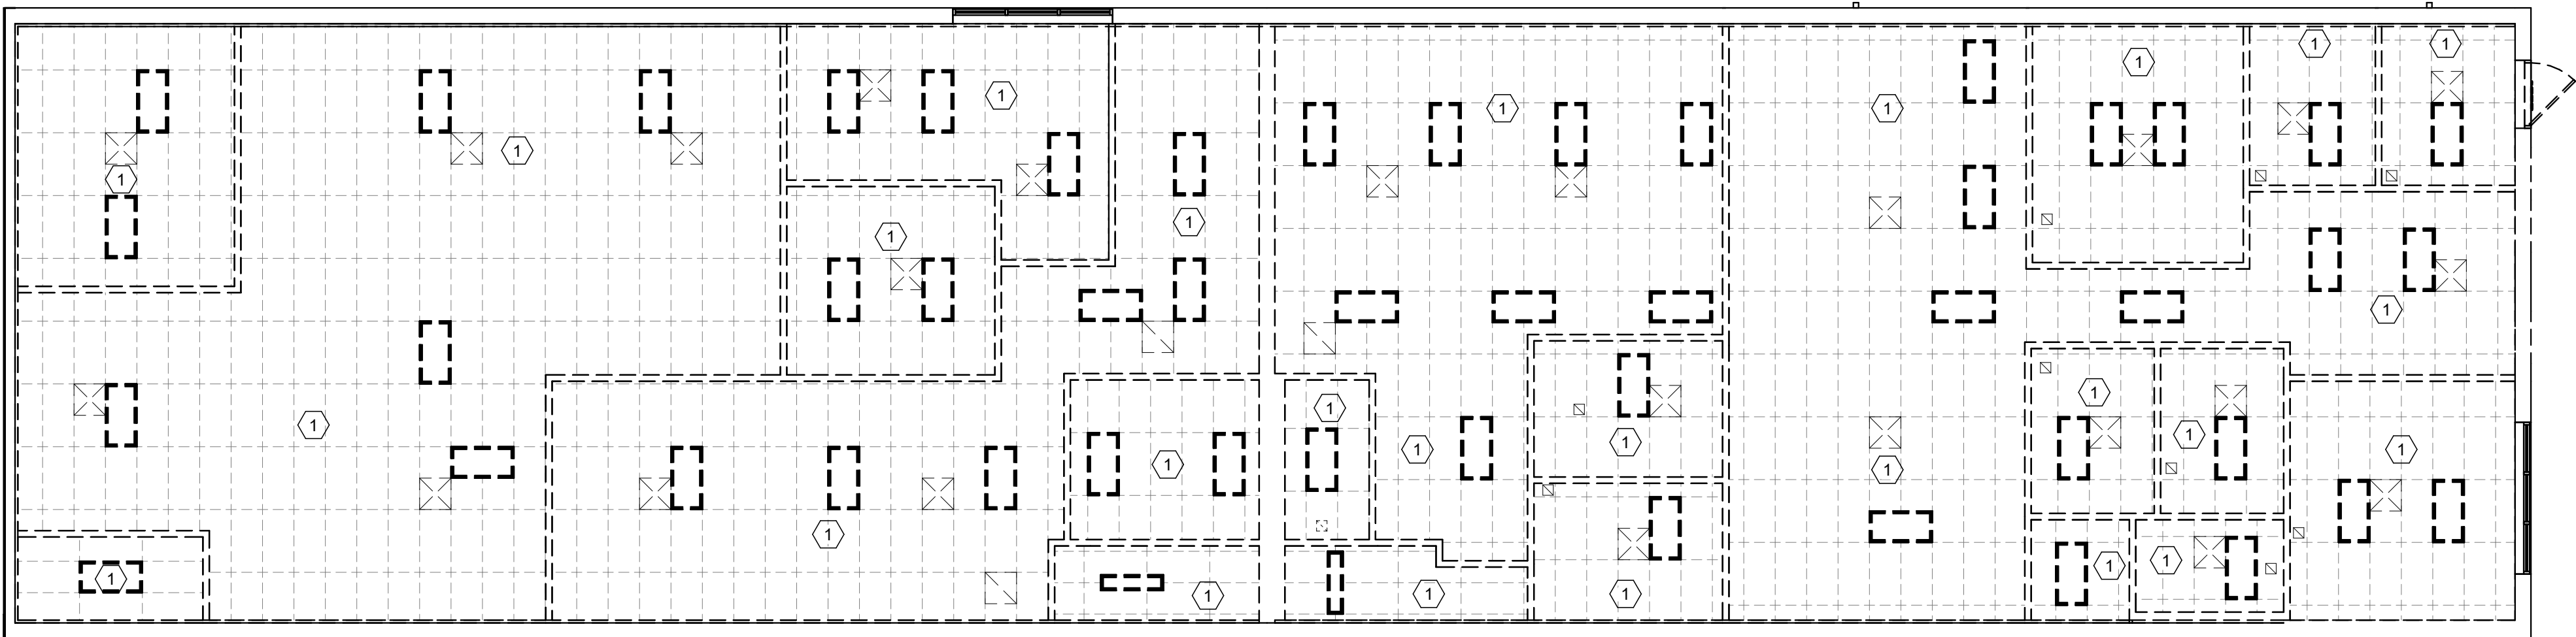

E1

DEMOLITION CEILING PLAN  
1/8" = 1'-0"

## DEMOLITION NOTES

⬢ INDICATES DEMOLITION NOTE.

- 1 REMOVE EXISTING CEILING AND GRID.

## GENERAL NOTES

- A. PRIOR TO DEMOLITION, FIELD INVESTIGATE EXISTING CONDITIONS AND NOTIFY ARCHITECT AND OWNER OF ANY DISCREPANCIES.
- B. PRIOR TO DEMOLITION, VERIFY THAT EXISTING UTILITIES HAVE BEEN DISCONNECTED AND CAPPED, AND TEMPORARY SHORING IS IN PLACE TO PREVENT MOVEMENT, SETTLEMENT, OR COLLAPSE OF CONSTRUCTION.
- C. REFER TO MECHANICAL, PLUMBING, ELECTRICAL AND STRUCTURAL DRAWINGS FOR ADDITIONAL DEMOLITION WORK.
- D. PRIOR TO DISPOSAL OF EXISTING EQUIPMENT AND/OR FIXTURES COORDINATE WITH OWNER.
- E. CONTRACTOR(S) SHALL BE RESPONSIBLE FOR REMOVING ALL CONSTRUCTION DEBRIS FROM JOB SITE IN A LEGAL AND TIMELY MANNER. LOCATION(S) OF JOBSITE DUMPSTER SHALL BE COORDINATED WITH OWNER PRIOR TO START OF CONSTRUCTION.

A

B

C


D

E

F

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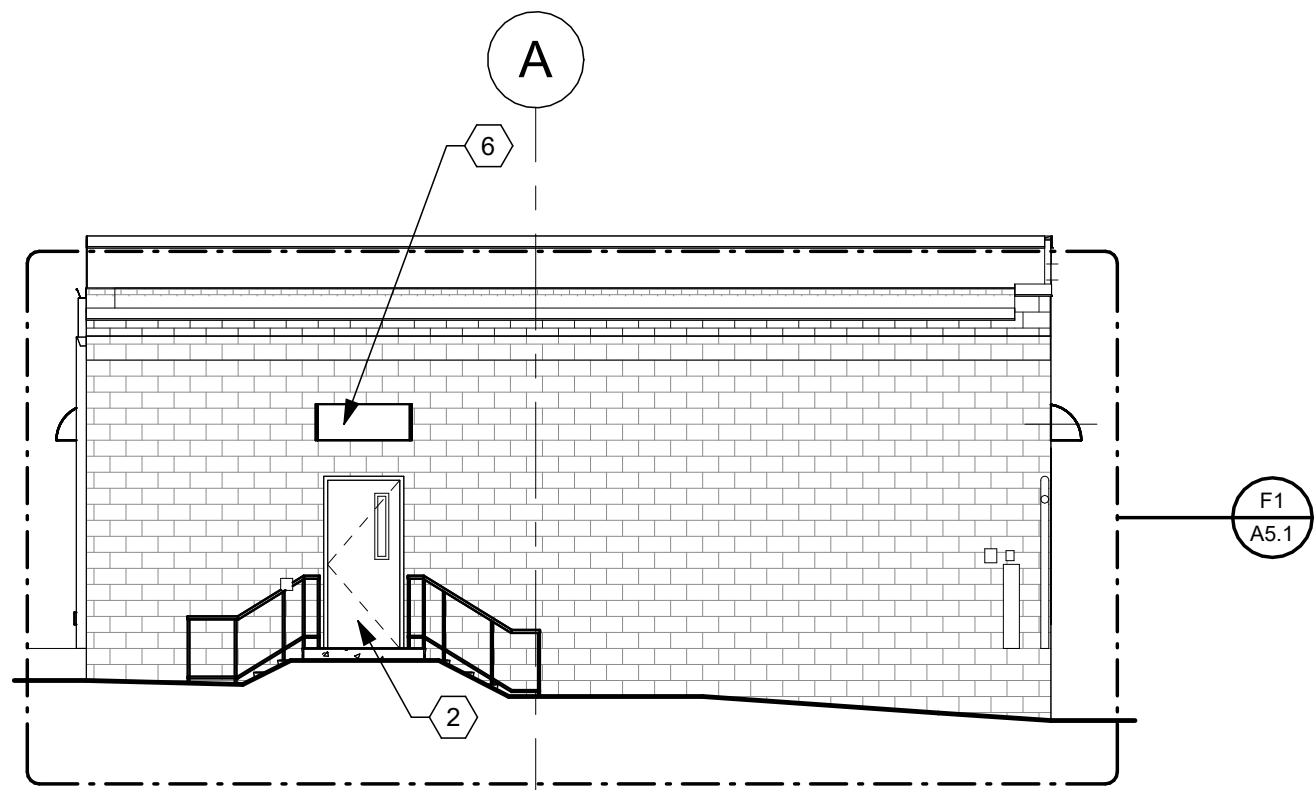
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TITLE  
**DEMOLITION REFLECTED  
CEILING PLAN**


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**A2.1**

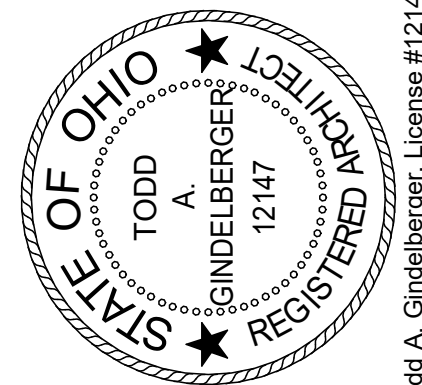





**B1** EXTERIOR ELEVATION - WEST  
1/8" = 1'-0"

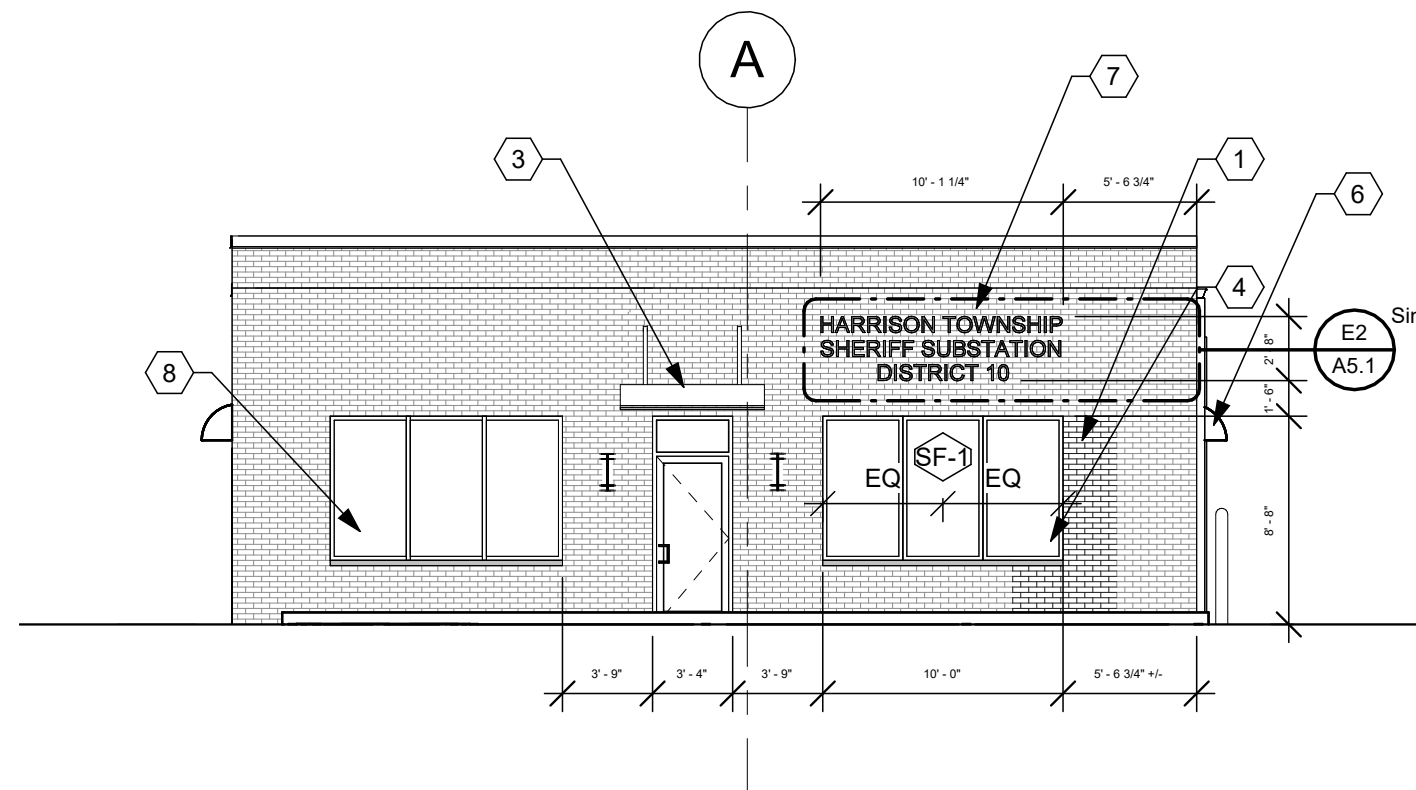

**B4** EXTERIOR ELEVATION - EAST  
1/8" = 1'-0"

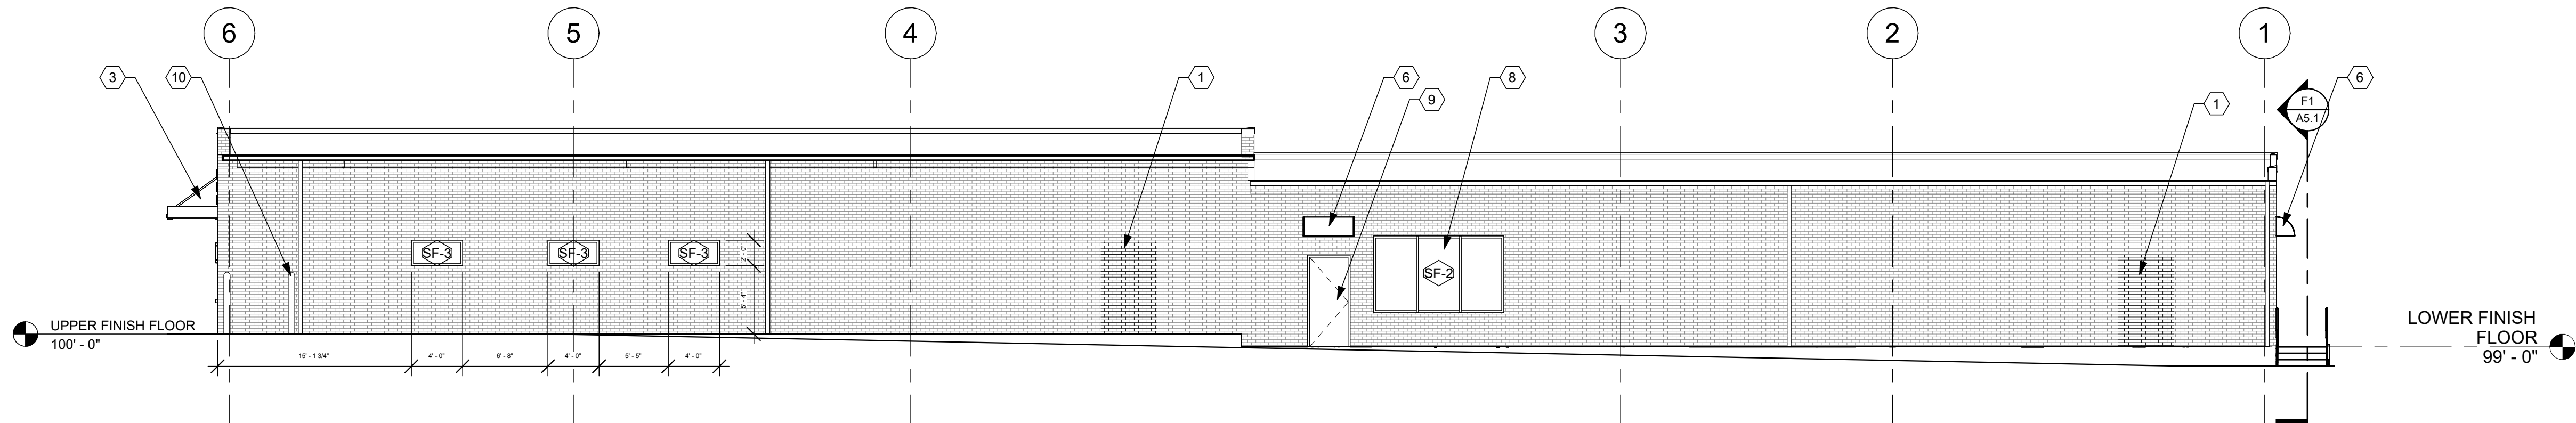

**D1** EXTERIOR ELEVATION - NORTH  
1/8" = 1'-0"

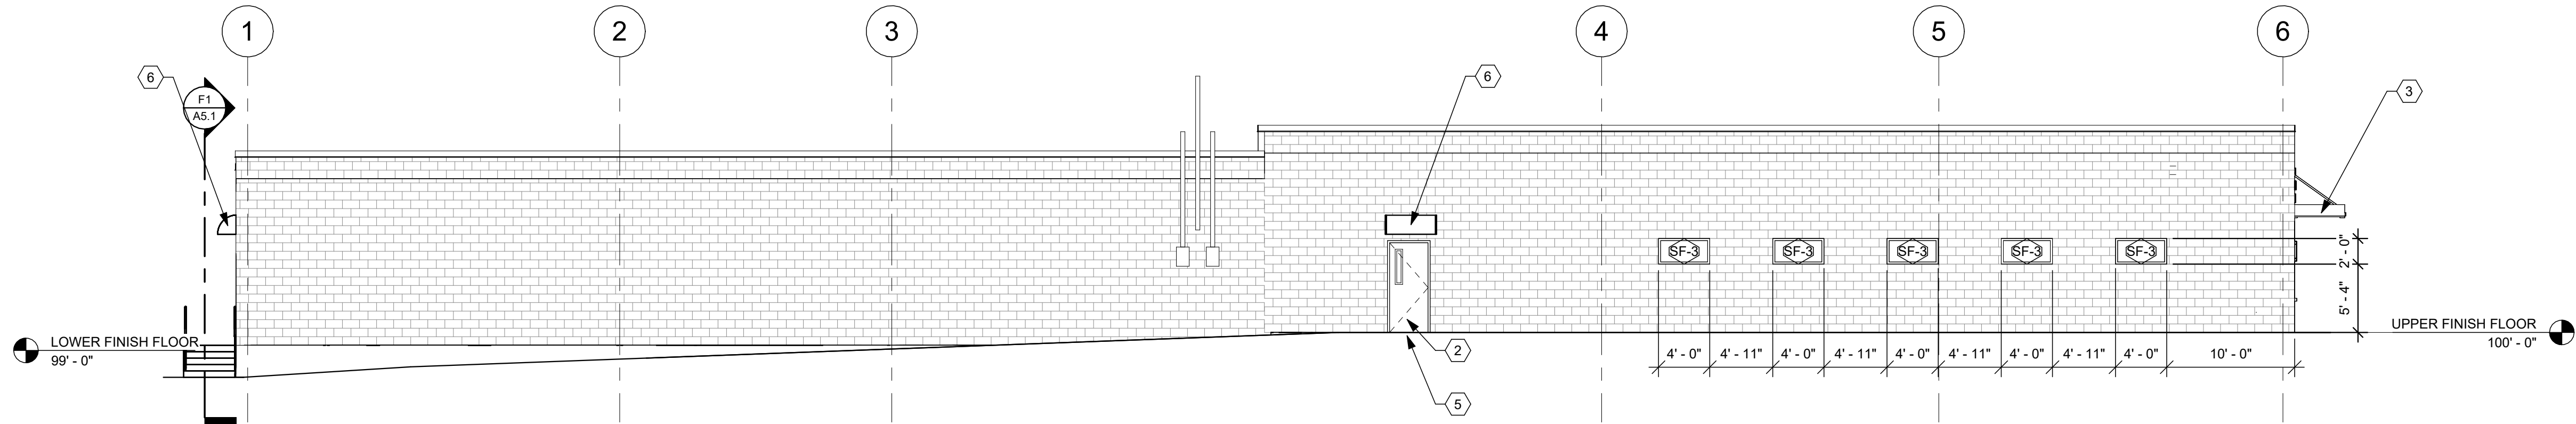

**F1** EXTERIOR ELEVATION - SOUTH  
1/8" = 1'-0"


## CONSTRUCTION NOTES

- 00 INDICATES CONSTRUCTION NOTE.
- MASONRY INFILL AFTER DOOR REMOVAL. MATCH EXISTING.
  - NEW INSULATED HOLLOW METAL DOOR.
  - SUSPENDED CABLE ALUMINUM CANOPY. REFER TO SHEET A5.1 AND STRUCTURAL DRAWINGS FOR DETAILS.
  - MATCH EXISTING RELOCATED WINDOW HEIGHT.
  - TOP OF PAD ALIGNS WITH FINISH FLOOR.
  - EXISTING CANOPY - RETAIN.
  - SIGNAGE BY ELLET DESIGN COMPANY OR EQUAL. CENTER OVER WINDOW.
  - EXISTING WINDOW TO REMAIN. RECAULK EXTERIOR.
  - EXISTING DOOR TO REMAIN. RECAULK EXTERIOR.
  - PATCH AND REPAIR FOUNDATION, MASONRY, AND PAVING AT THIS LOCATION.

## GENERAL NOTES

- EXISTING GUTTERS AND DOWNSPOUTS TO REMAIN. REPAIR AS NEEDED. MAINTAIN OUTLETS TO FLOW AWAY FROM BUILDING.
- CAULK ALL NEW AND EXISTING WINDOWS, DOORS, PENETRATIONS, AND EXPANSION JOINTS.



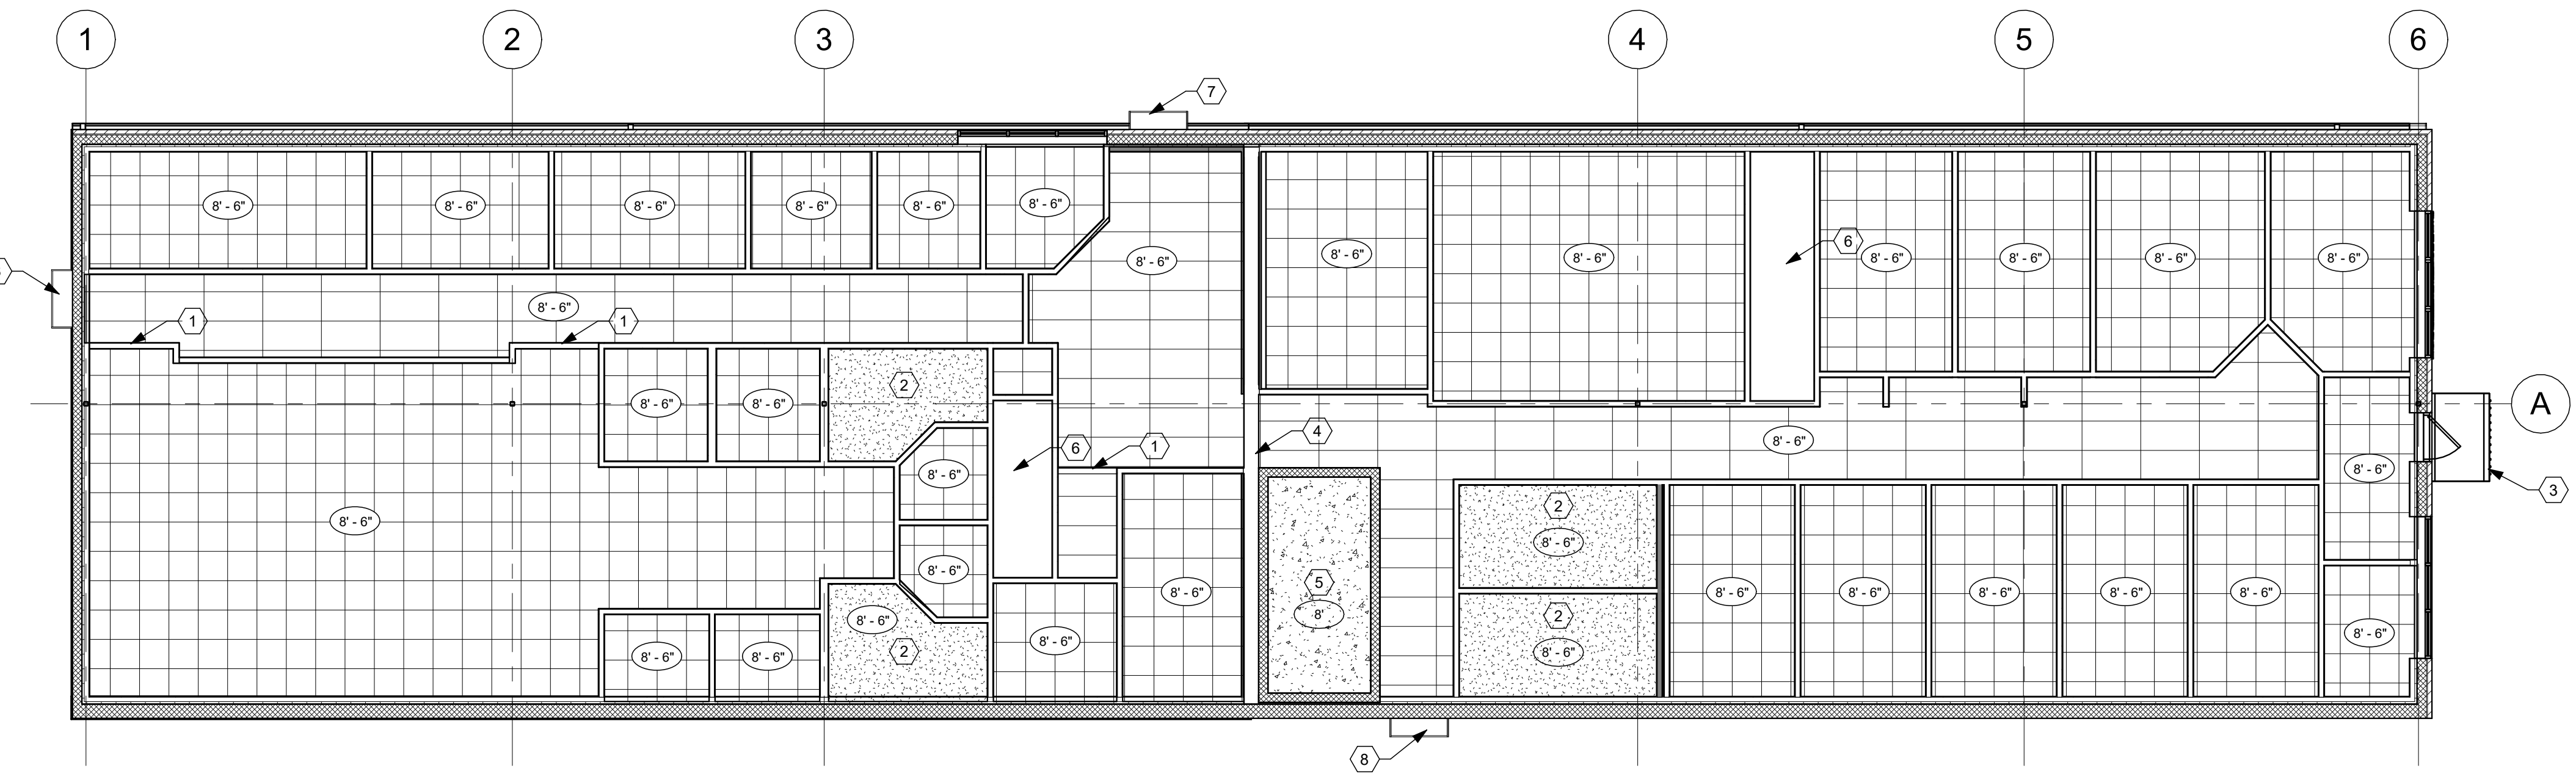

E1 REFLECTED CEILING PLAN  
1/8" = 1'-0"

## CONSTRUCTION NOTES

- 00 INDICATES CONSTRUCTION NOTE.
- 1 FRAMED BULKHEAD AT 8'-6" AFF.
  - 2 FRAMED GYPSUM CEILING.
  - 3 SUSPENDED CABLE ALUMINUM CANOPY. REFER TO SHEET A5.1 AND STRUCTURAL DRAWINGS FOR DETAILS.
  - 4 KEEP EXISTING FRAMED OPENING.
  - 5 CONCRETE LID OF STORM SHELTER IS INDEPENDENT OF SURROUNDING WALL STRUCTURES. REFER TO STRUCTURAL DRAWINGS FOR DETAILS.
  - 6 LEAVE EXPOSED.
  - 7 EXISTING CANOPY - RETAIN.
  - 8 MATCH EXISTING CANOPY AT EGRESS DOOR 125B.

## GENERAL NOTES

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TITLE REFLECTED CEILING PLAN	
SHEET NO. <b>A2.2</b>	



A

B

C

D

E

F

1

2


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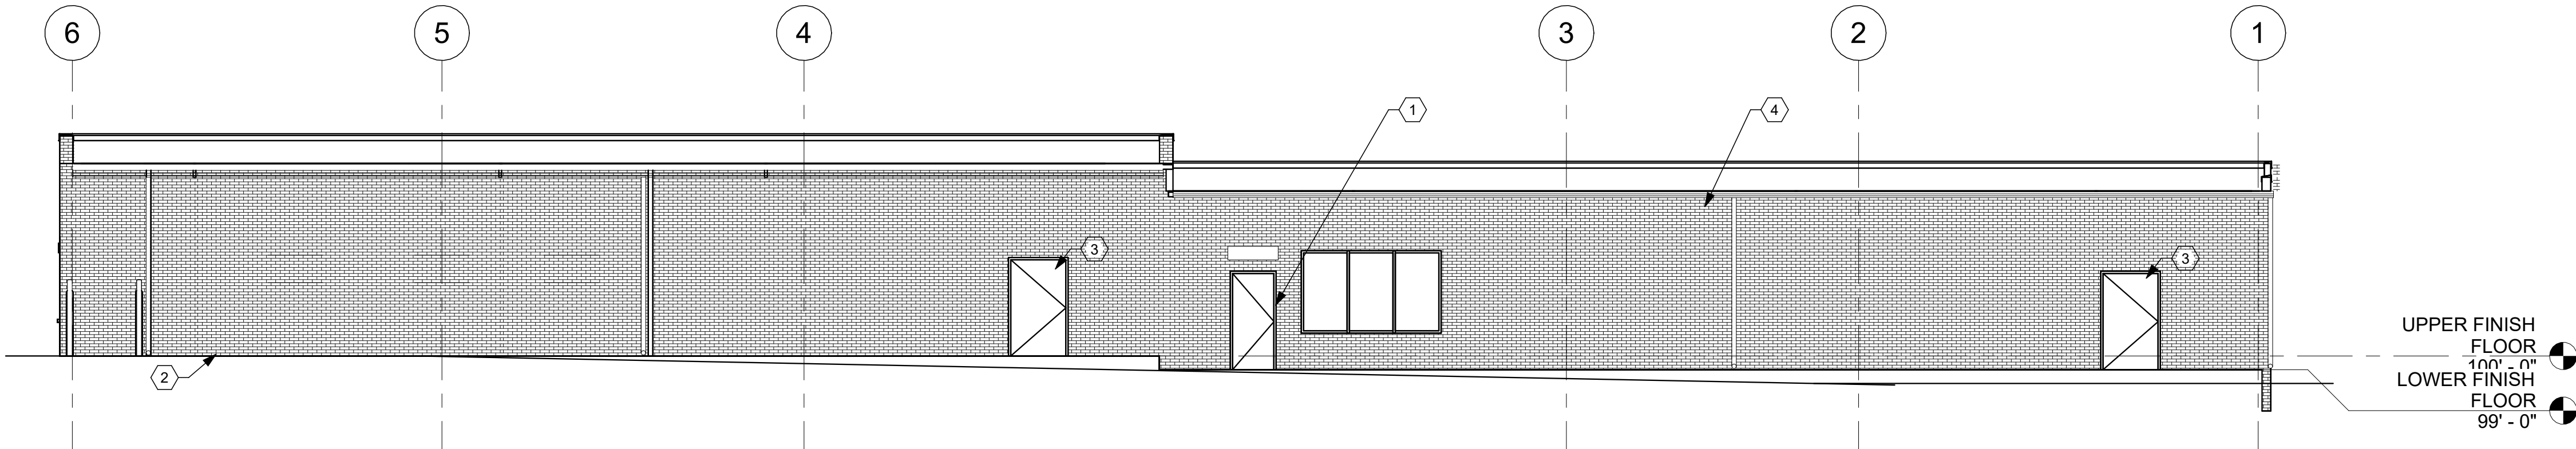
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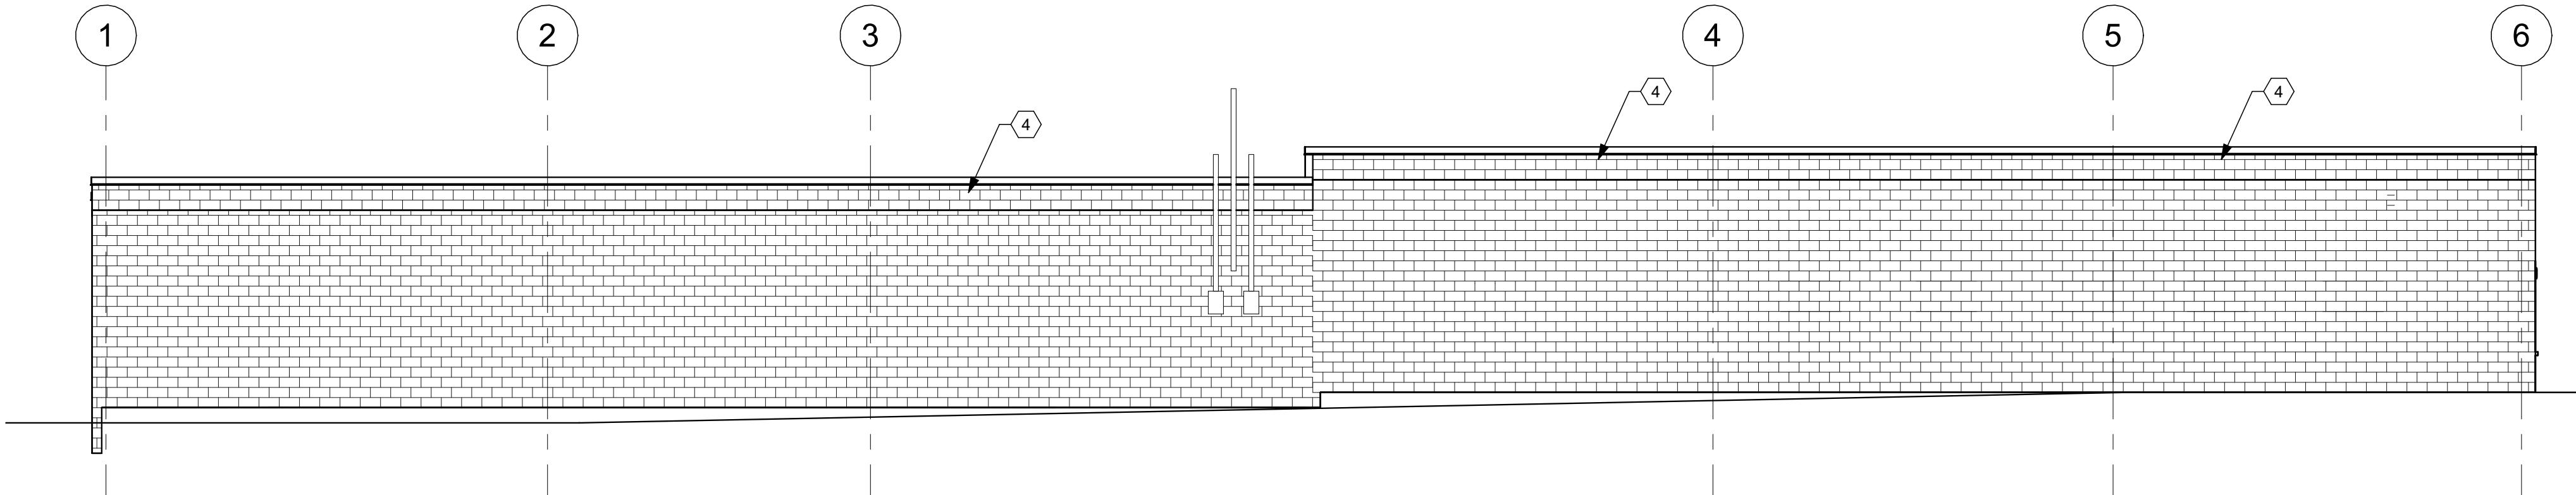


C1 EXTERIOR ELEVATION - WEST REPAIR  
1/4" = 1'-0"

C4 WEST ELEVATION EXISTING  
12" = 1'-0"



D1 EXTERIOR ELEVATION - NORTH REPAIR  
1/8" = 1'-0"

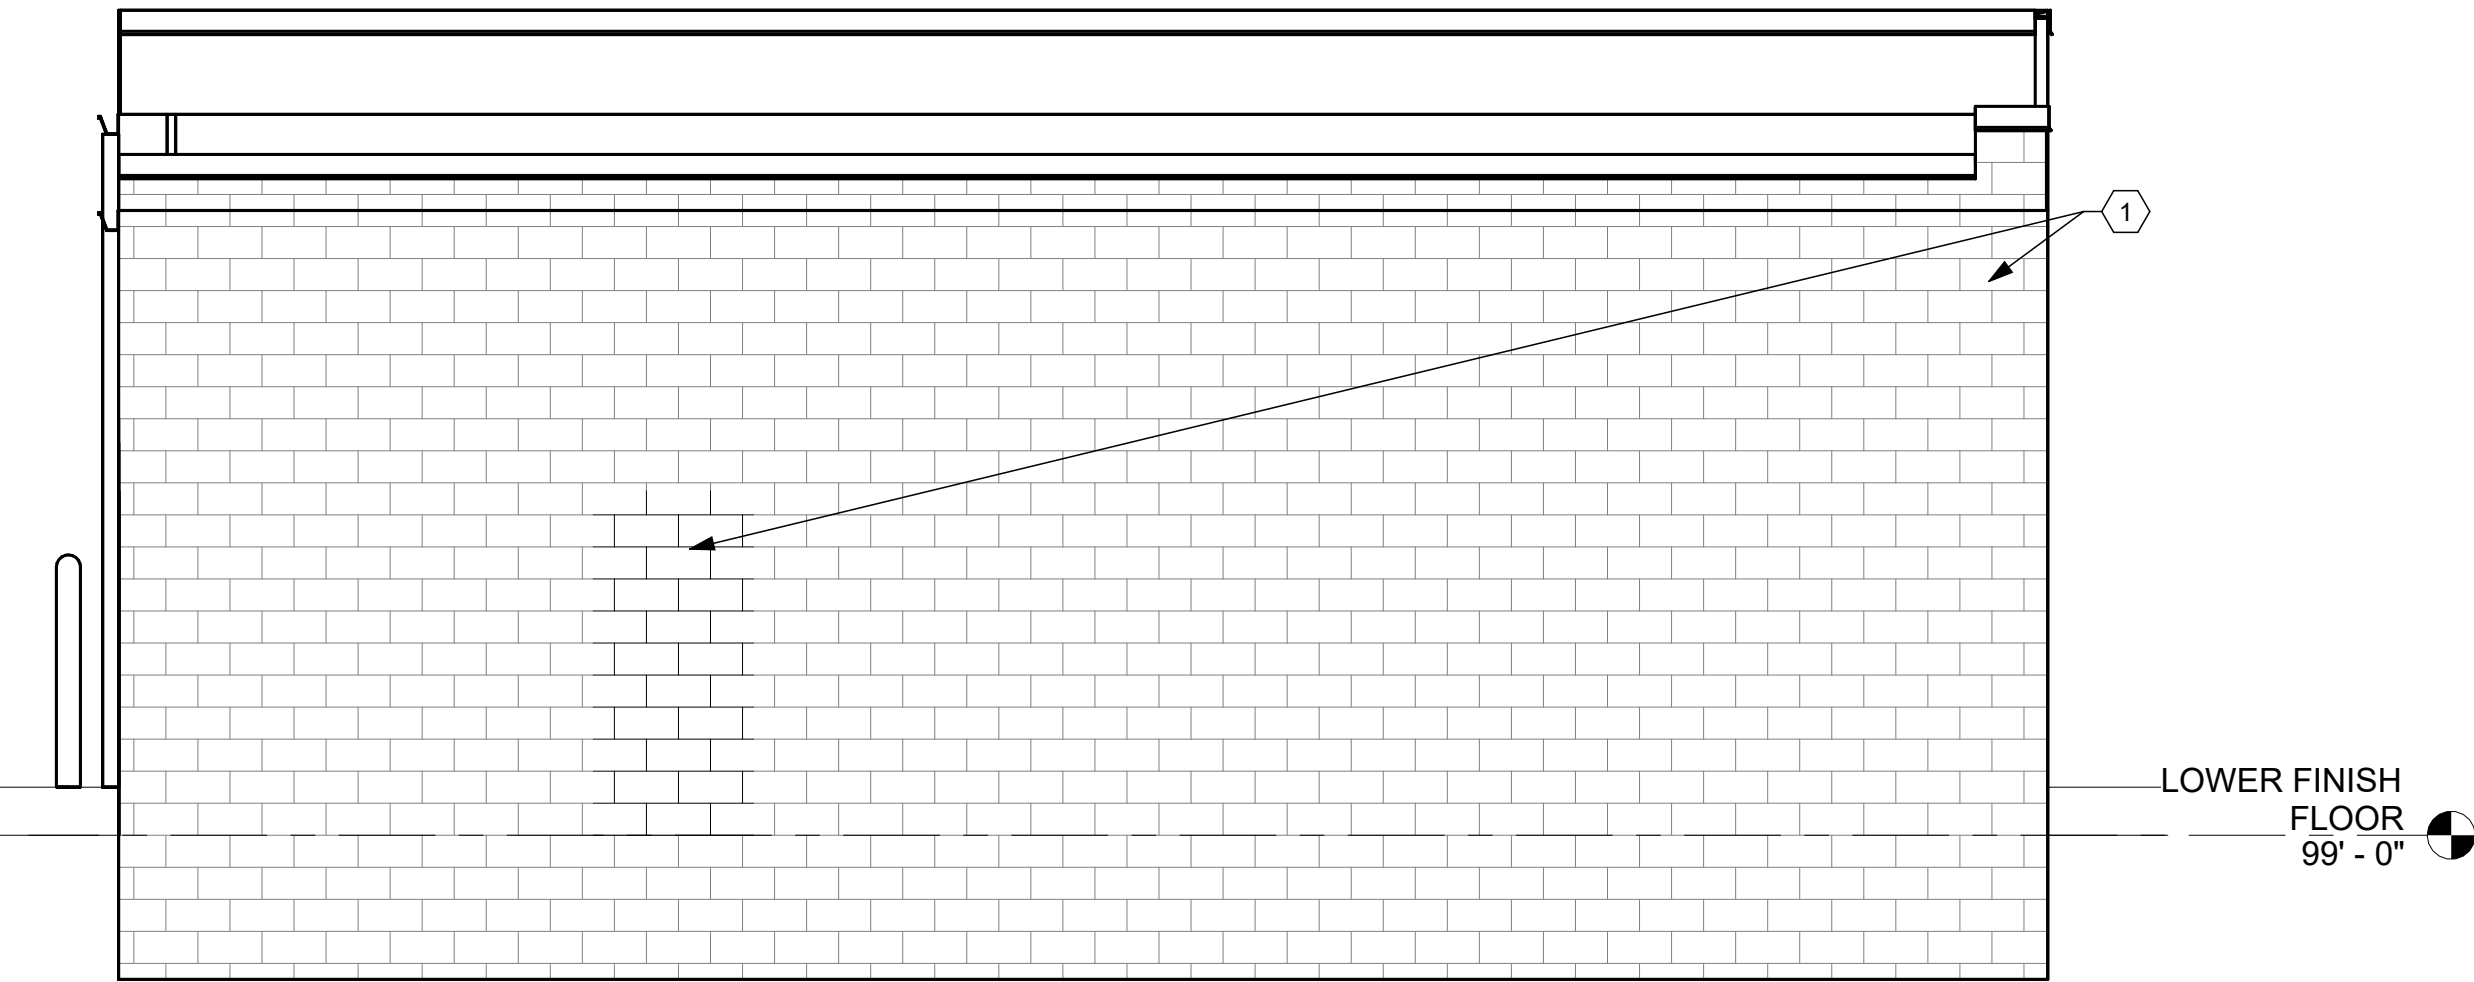

F1 EXTERIOR ELEVATION - SOUTH REPAIR  
1/8" = 1'-0"

## CONSTRUCTION NOTES

00 INDICATES CONSTRUCTION NOTE.

- 1 TUCKPOINT AND REPAINT ENTIRE EXISTING WALL AFTER DOOR INSTALLATION.
- 2 REPAIR EXISTING FOUNDATION TO MATCH EXISTING EXTERIOR WALL TYPE. REFER TO STRUCTURAL DRAWINGS.
- 3 REMOVE EXISTING DOOR AND INFILL TO MATCH EXISTING EXTERIOR WALL TYPE.
- 4 TUCKPOINT EXISTING WALL. PROVIDE ALLOWANCE FOR 200 SF. REPAINT ENTIRE WALL.

## GENERAL NOTES

- A. EXISTING GUTTERS AND DOWNSPOUTS TO REMAIN REPAIR AS NEEDED. MAINTAIN OUTLETS TO FLOW AWAY FROM BUILDING.
- B. CAULK ALL NEW AND EXISTING WINDOWS, DOORS, PENETRATIONS, AND EXPANSION JOINTS.

A

B

C


D

E


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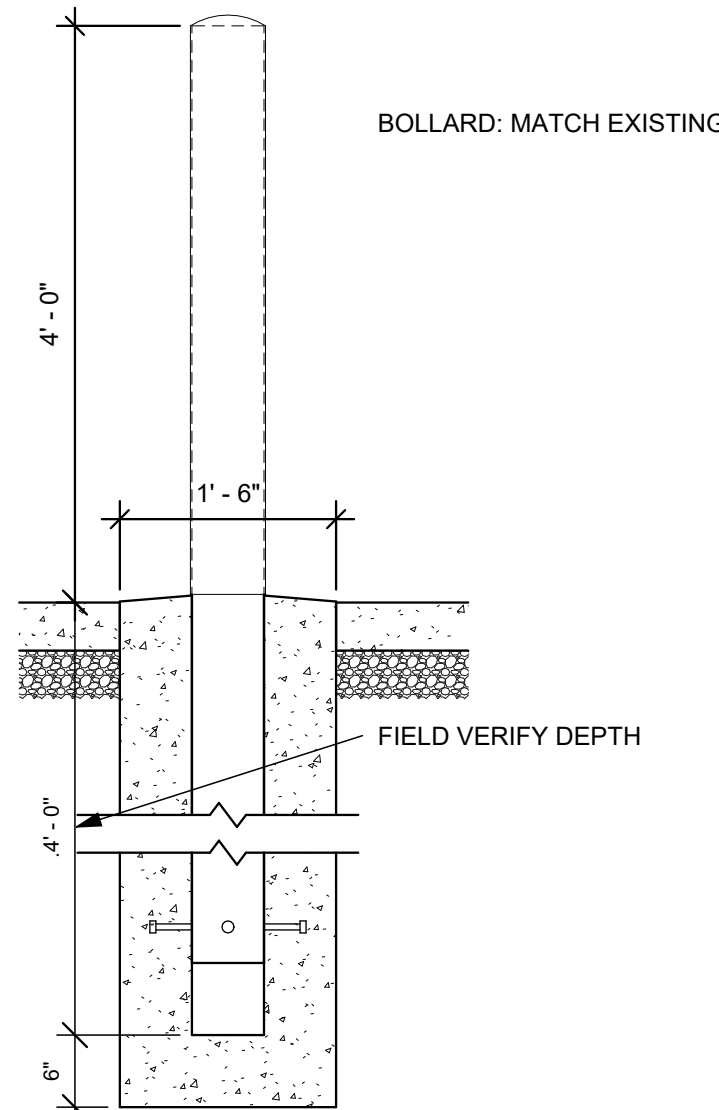
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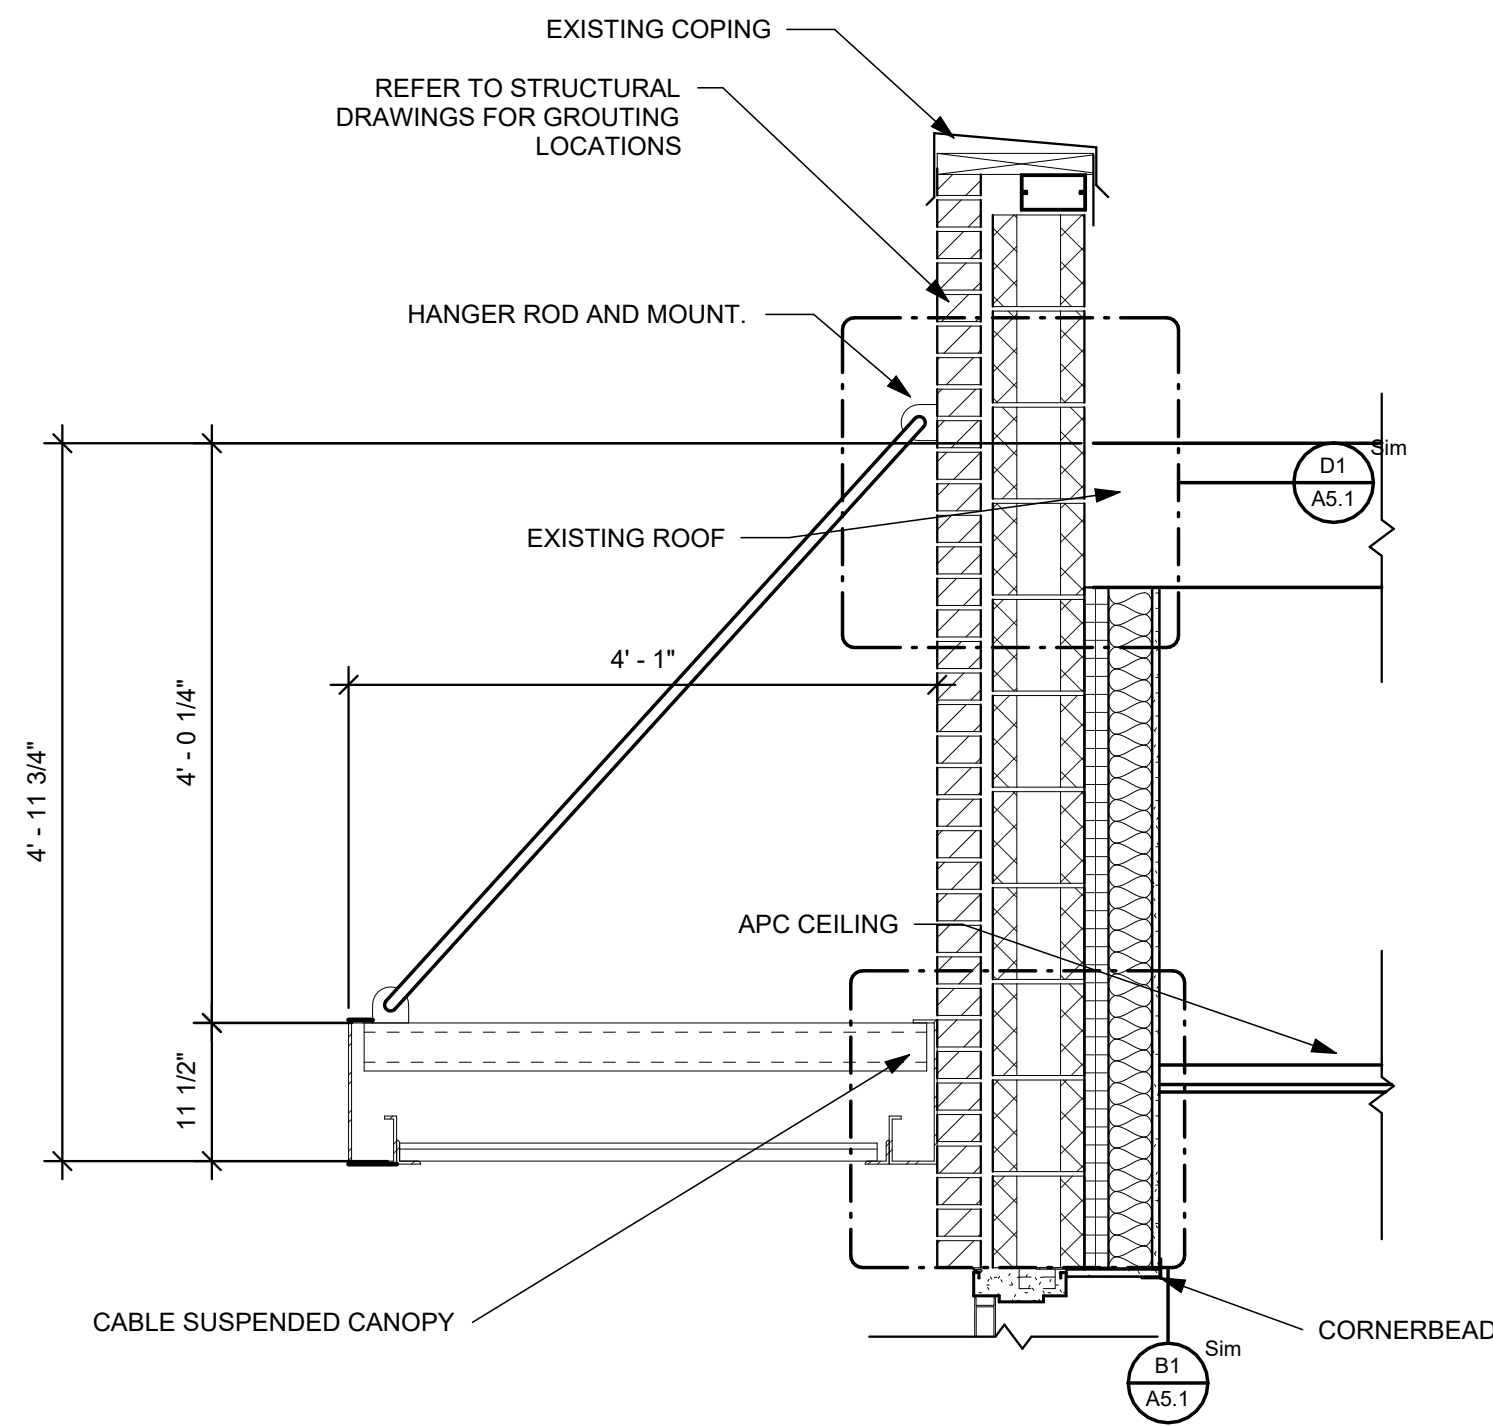
**B1** CANOPY CONNECTION DETAIL 2  
1 1/2" = 1'-0"




**D1** CANOPY CONNECTION DETAIL 1  
1 1/2" = 1'-0"

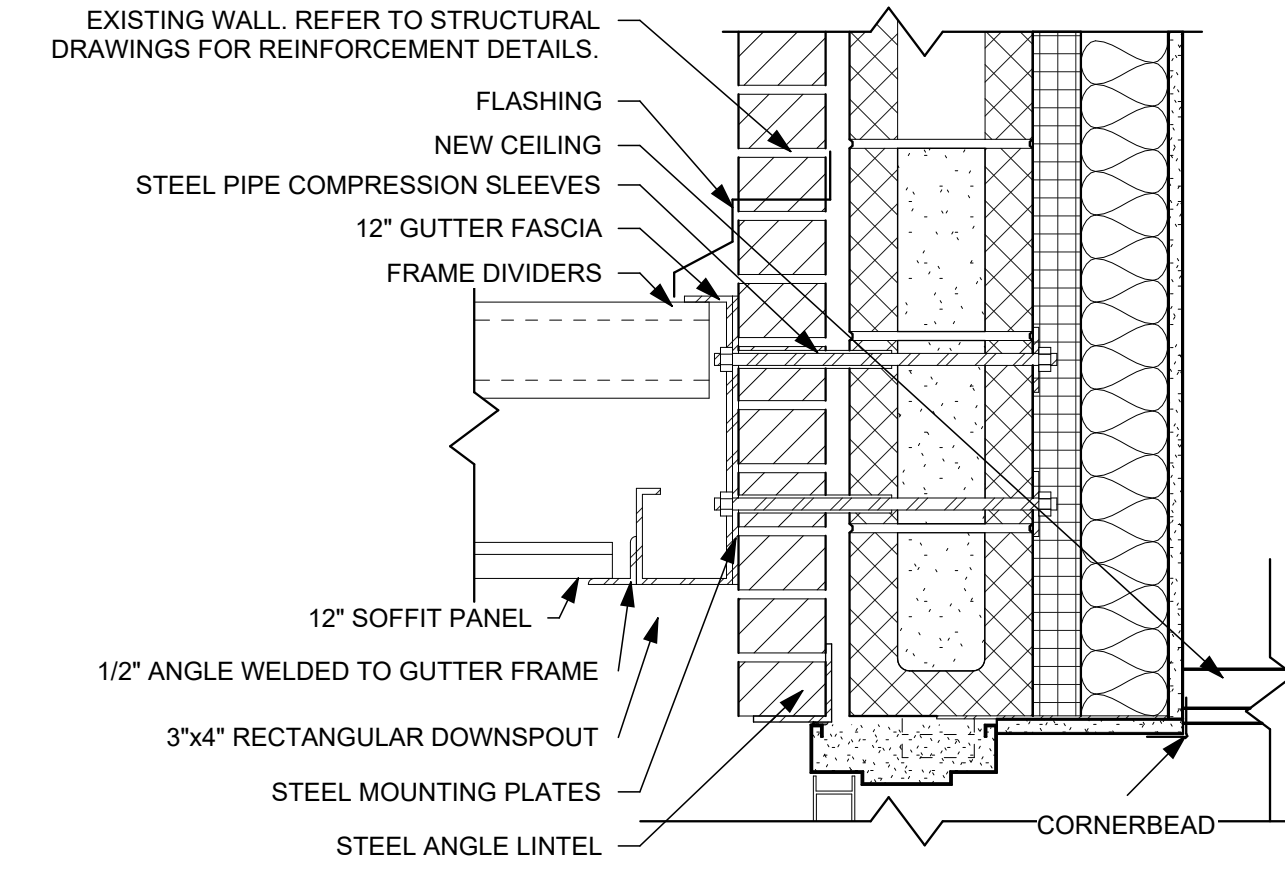


**C2** PIPE BOLLARD DETAIL  
3/4" = 1'-0"

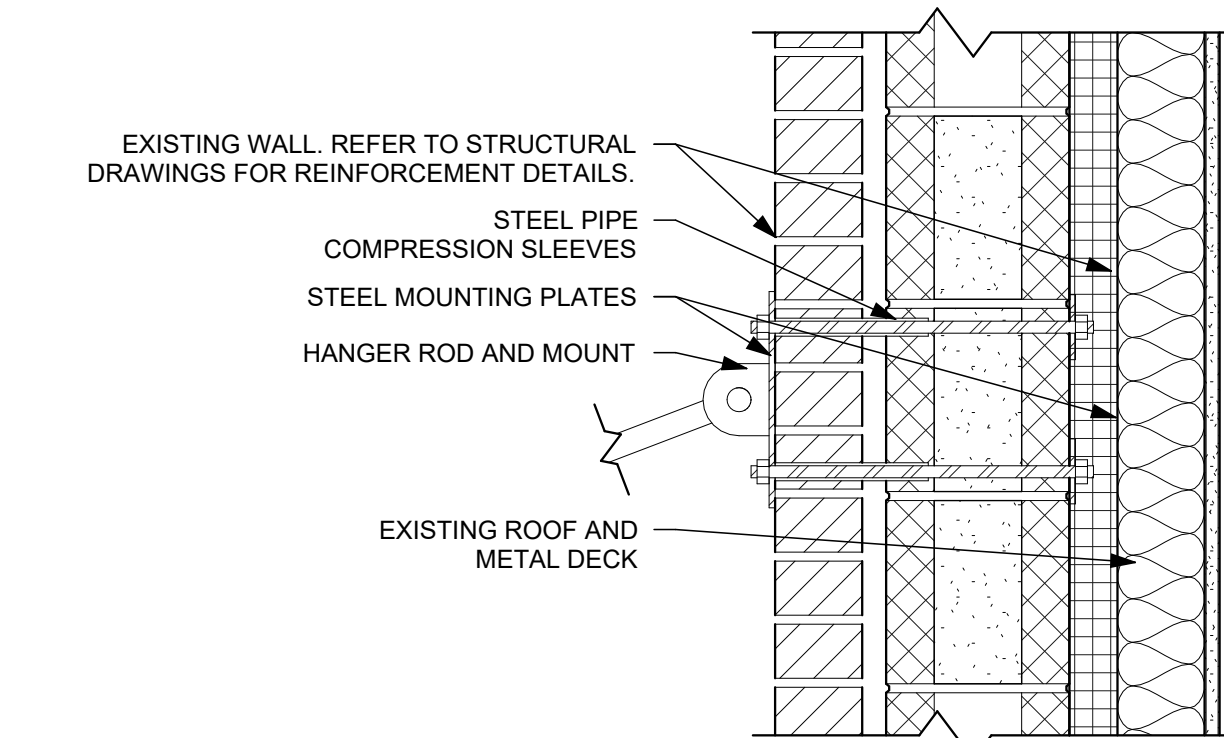


**C3** CANOPY DETAIL  
3/4" = 1'-0"

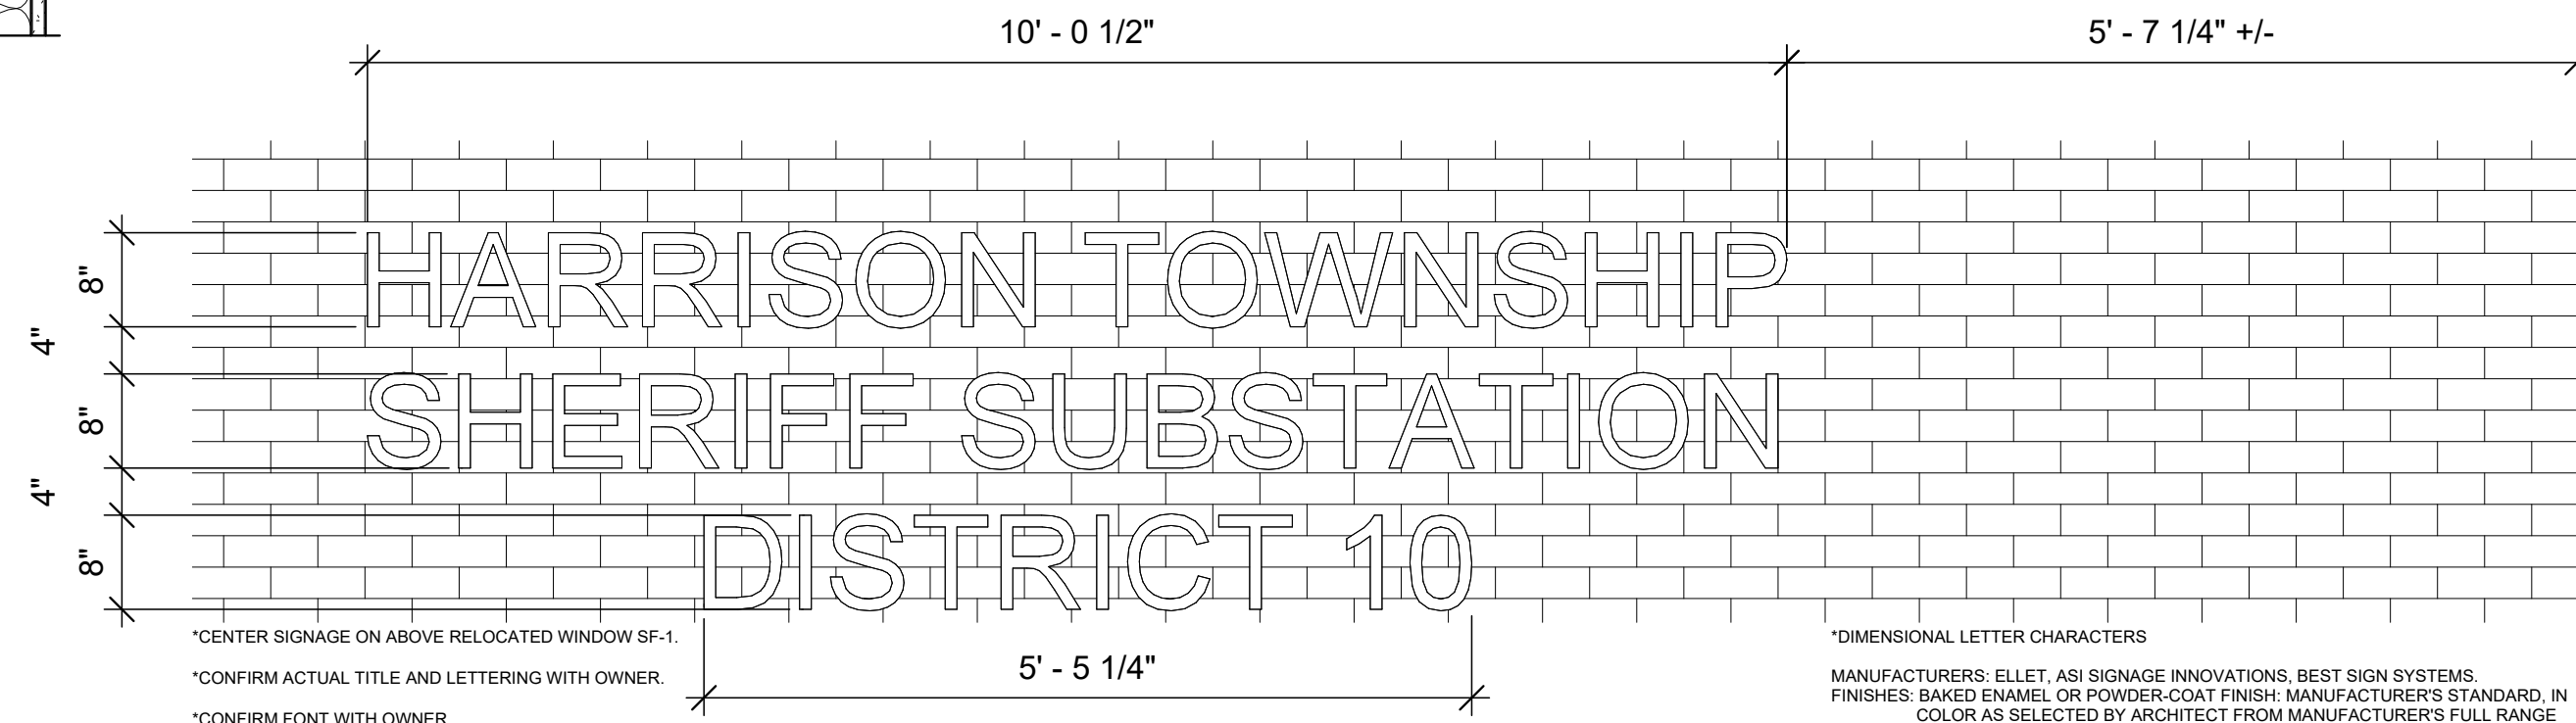

**E2** SIGNAGE DETAIL  
3/4" = 1'-0"

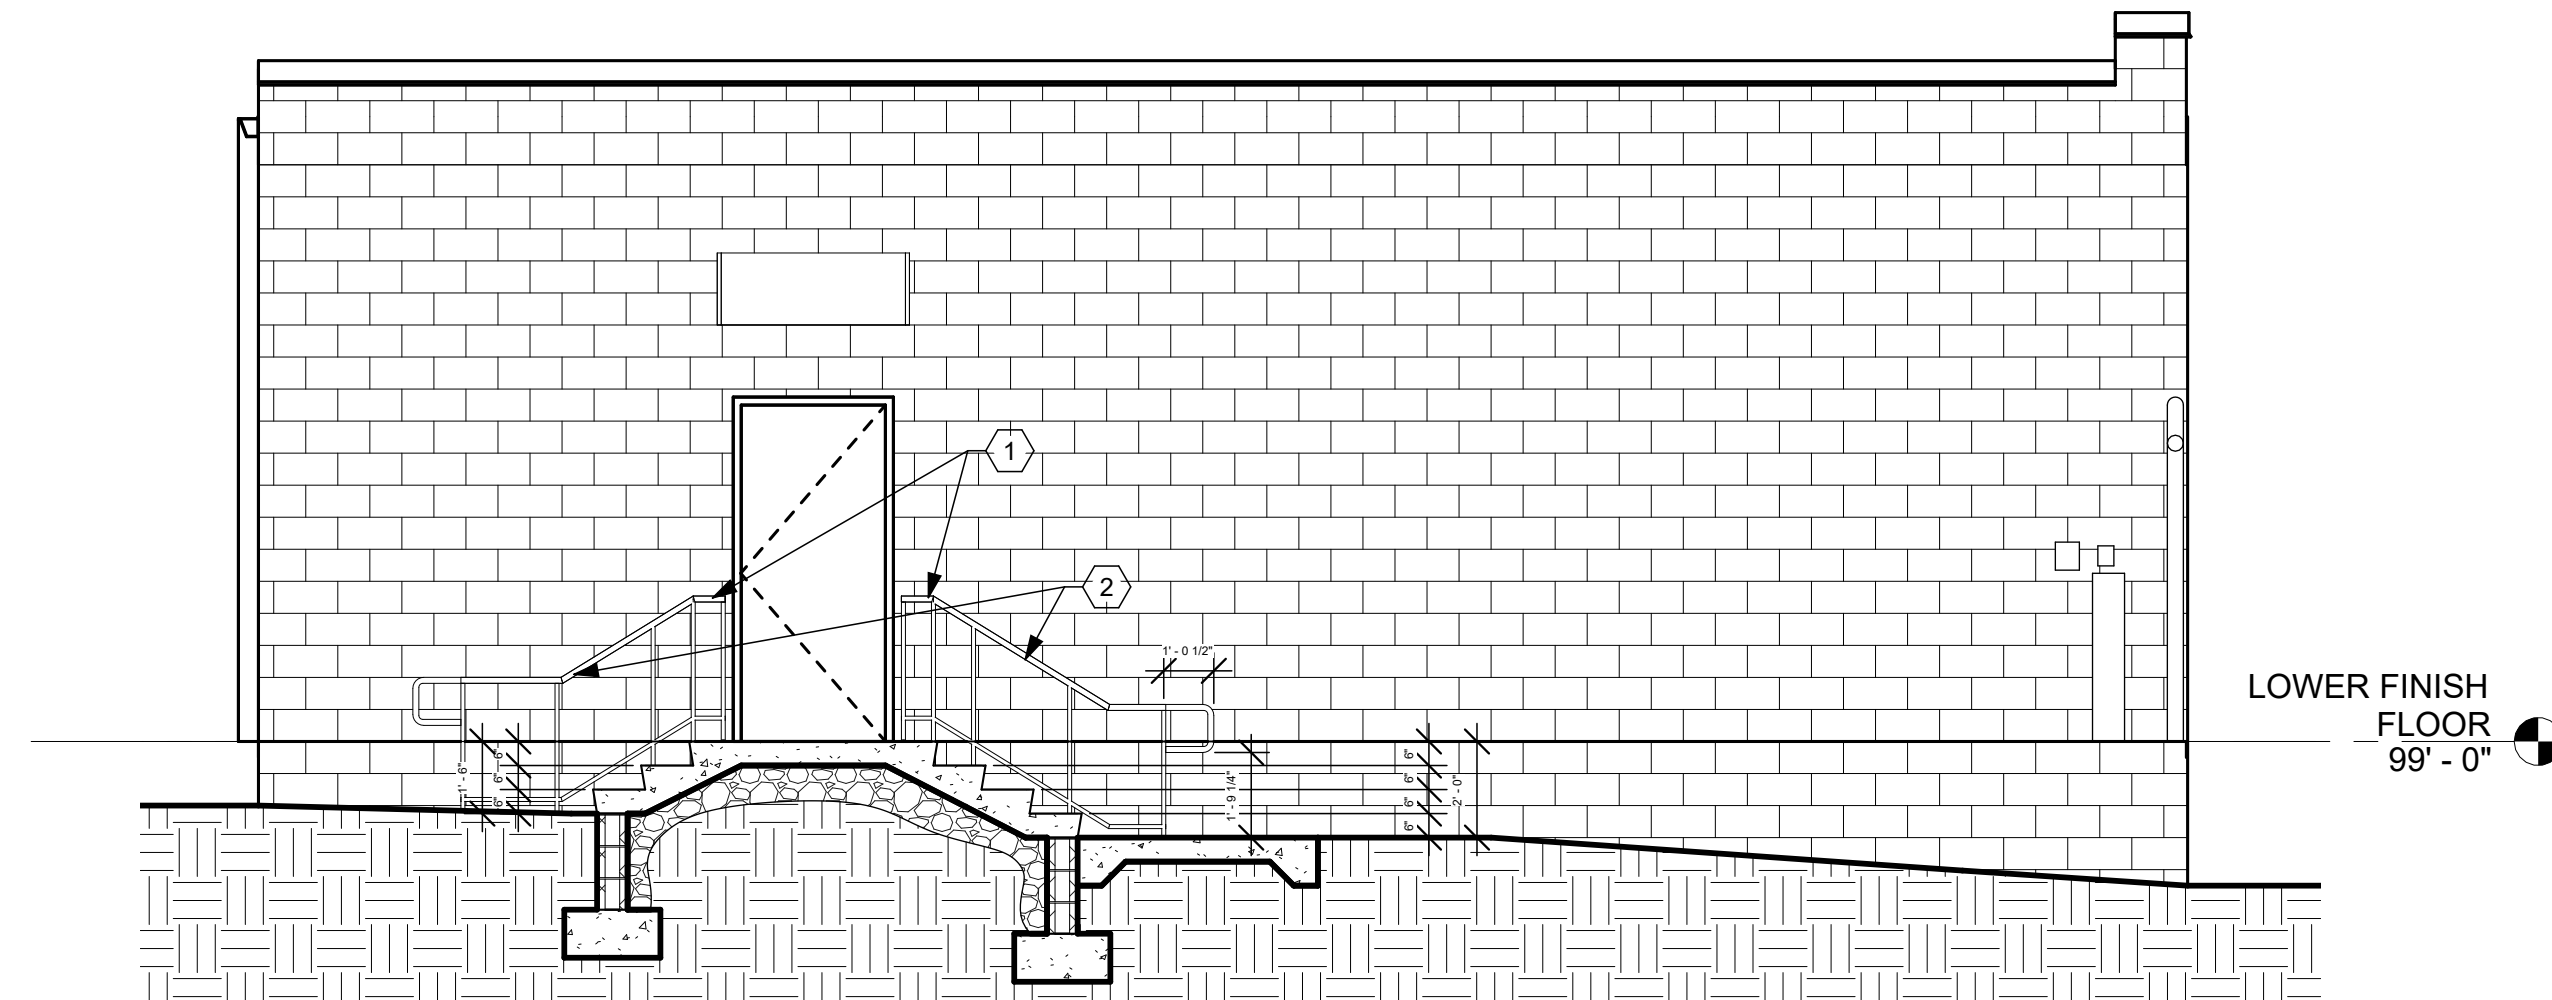


**F1** EXTERIOR STEPS SECTION  
1/4" = 1'-0"

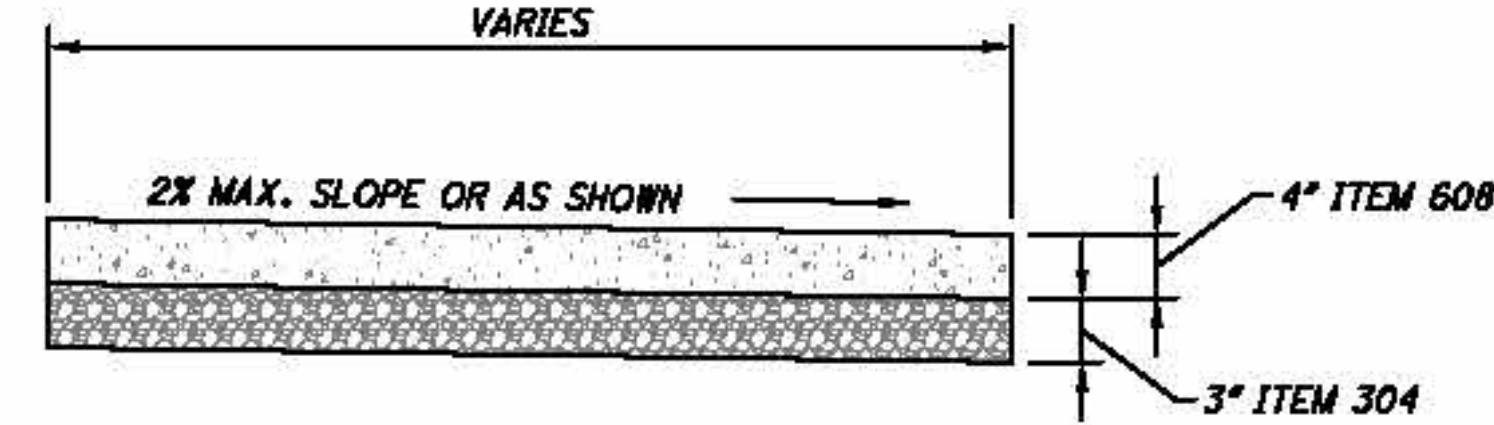

### NOTES

- WALK TO BE POURED ON 3" MINIMUM ODOT #304.
- PROVIDE EDGING AND BROOM FINISH TO ALL EXPOSED SURFACES.
- CONCRETE SHALL CONFORM TO ODOT ITEM 499 CONCRETE AND WORK SHALL CONFORM TO ODOT ITEM 608, UNLESS OTHERWISE SPECIFIED WITHIN.
- USE WHITE PIGMENTED CURING COMPOUND IMMEDIATELY AFTER FINISHING SURFACES. ANY OTHER METHOD OR TYPE OF CURING COMPOUND MUST BE PREAPPROVED.
- ALL CONCRETE SHALL BE ODOT QC-IP.
- PROPOSED CONCRETE WALK SHALL BE JOINTED AS CLOSE TO SQUARE AS POSSIBLE. JOINT SPACING MAY VARY SLIGHTLY DEPENDING ON THE LENGTH AND WIDTH OF THE PROPOSED SIDEWALK AREAS. JOINT SPACING SHALL TYPICALLY RANGE FROM 4'X4' TO 10'X10'. IN ALL CASES THE SIDEWALK SHALL BE JOINTED SO THAT THE MAXIMUM ASPECT RATIO (OF PANEL LENGTH TO WIDTH) OF THE JOINTING IS 1.25:1 OR LESS. CONTRACTOR TO VERIFY METHOD AND TYPE OF CONTROL JOINTING WITH OWNER PRIOR TO PERFORMING WORK.
- SIDEWALK SHALL HAVE EXPANSION JOINTS EVERY 100'.
- CONCRETE TO INCLUDE 3 LBS/CY OF EITHER EUCLID CHEMICAL TUFSTRAND SF, FORTA FERRO SYNTHETIC MACROFIBERS OR APPROVED EQUIVALENT MEETING ASTM C 1116 TYPE 3, MINIMUM 2" LENGTH, ASPECT RATIO 50 TO 90. CONTRACTOR SHALL CONTACT THE FIBER MANUFACTURER'S SUPPLIER 48 HOURS PRIOR TO ORDERING THE FIRST BATCH OF CONCRETE FOR APPROPRIATE MIXING AND FINISHING PROCEDURES.

### CONCRETE WALK NTS

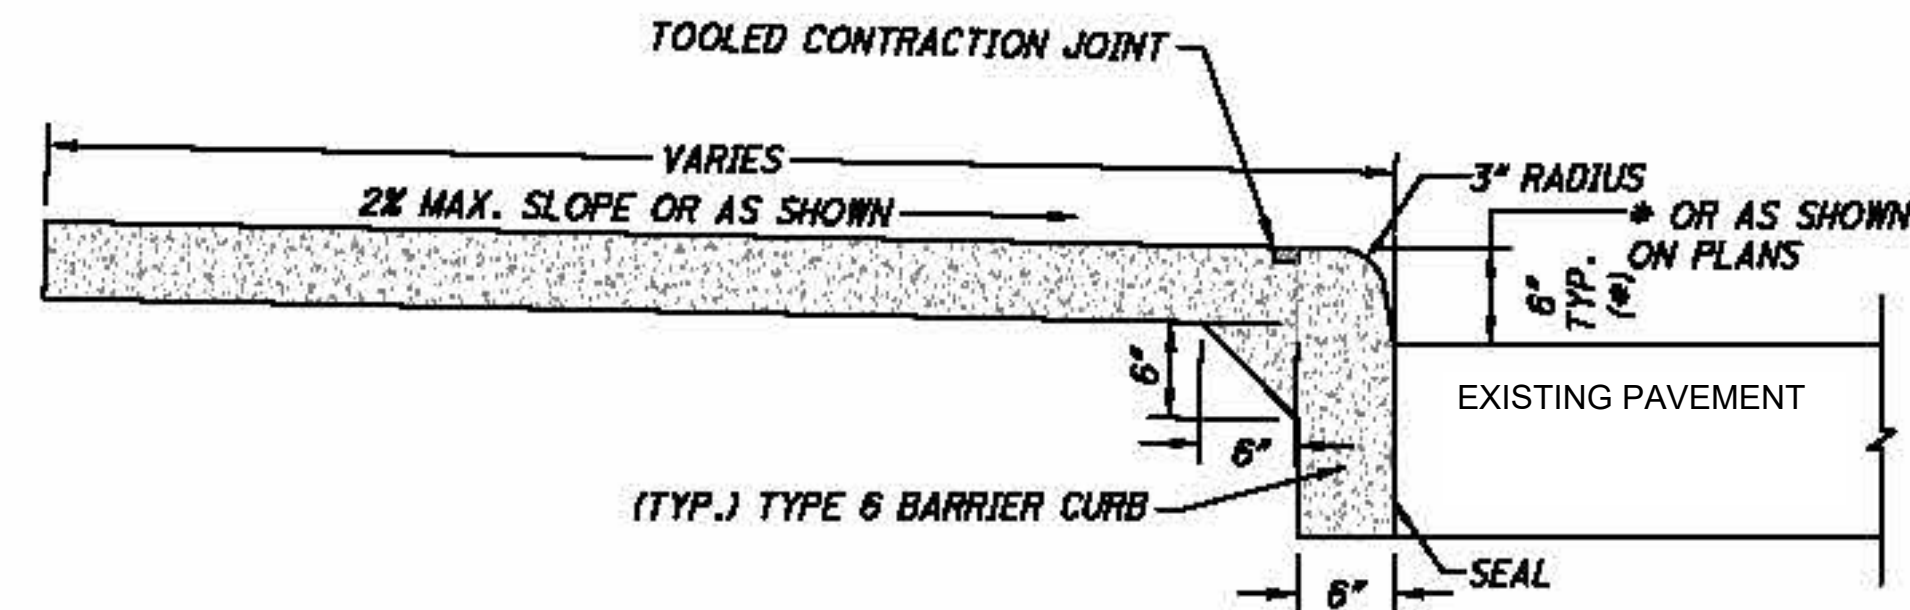

### NOTES

- WALK TO BE POURED ON 3" MINIMUM ODOT #304.
- (\*) HEIGHT VARIES WITH CURB EXPOSURE. ASTERISK INDICATES PROPOSED TOP OF CURB SPOT GRADE ELEVATION WITH CURB EXPOSURE THAT VARIES FROM THE STANDARD 0.50' (6" CURB.
- PROVIDE EDGING AND BROOM FINISH TO ALL EXPOSED SURFACES.
- CONCRETE SHALL CONFORM TO ODOT ITEM 499 CONCRETE AND WORK SHALL CONFORM TO ODOT ITEM 608, UNLESS OTHERWISE SPECIFIED WITHIN.
- USE WHITE PIGMENTED CURING COMPOUND IMMEDIATELY AFTER FINISHING SURFACES. ANY OTHER METHOD OR TYPE OF CURING COMPOUND MUST BE PREAPPROVED.
- ALL CONCRETE SHALL BE ODOT QC-IP.
- PROPOSED CONCRETE SIDEWALK SHALL BE JOINTED AS CLOSE TO SQUARE AS POSSIBLE. JOINT SPACING MAY VARY SLIGHTLY DEPENDING ON THE LENGTH AND WIDTH OF THE PROPOSED SIDEWALK AREAS. JOINT SPACING SHALL TYPICALLY RANGE FROM 4'X4' TO 10'X10'. IN ALL CASES THE SIDEWALK SHALL BE JOINTED SO THAT THE MAXIMUM ASPECT RATIO (OF PANEL LENGTH TO WIDTH) OF THE JOINTING IS 1.25:1 OR LESS. CONTRACTOR TO VERIFY METHOD AND TYPE OF CONTROL JOINTING WITH OWNER PRIOR TO PERFORMING WORK.
- CURB/SIDEWALK SHALL HAVE EXPANSION JOINTS EVERY 100'.
- CONCRETE TO INCLUDE 3 LBS/CY OF EITHER EUCLID CHEMICAL TUFSTRAND SF, FORTA FERRO SYNTHETIC MACROFIBERS OR APPROVED EQUIVALENT MEETING ASTM C 1116 TYPE 3, MINIMUM 2" LENGTH, ASPECT RATIO 50 TO 90. CONTRACTOR SHALL CONTACT THE FIBER MANUFACTURER'S SUPPLIER 48 HOURS PRIOR TO ORDERING THE FIRST BATCH OF CONCRETE FOR APPROPRIATE MIXING AND FINISHING PROCEDURES.

### COMBINED CURB AND WALK NTS

**F5** PAD AND CURB DETAILS  
1 1/2" = 1'-0"

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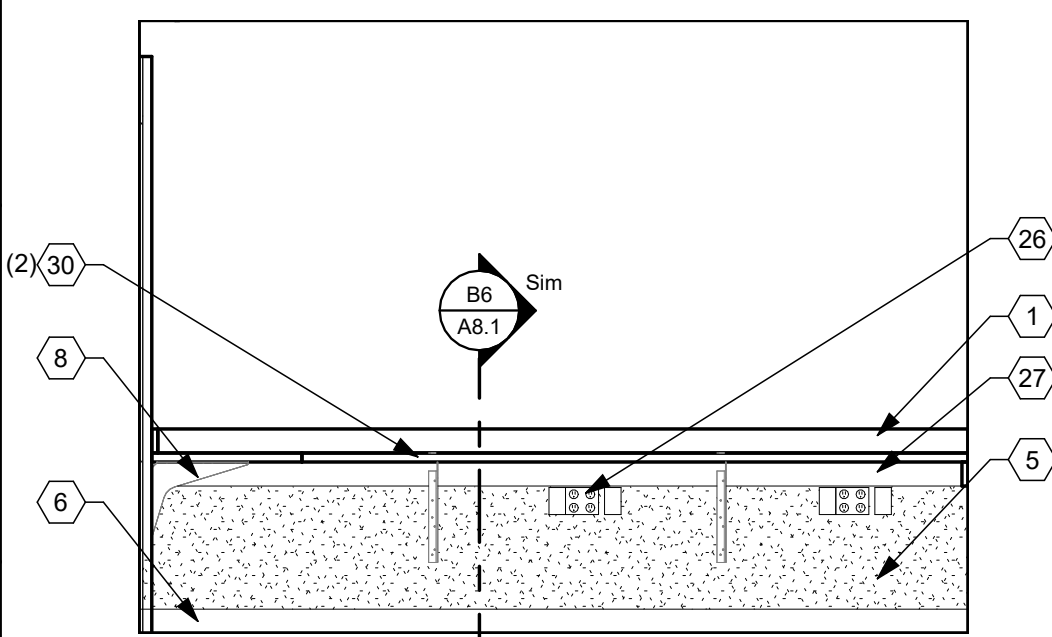
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TITLE	EXTERIOR DETAILS


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**A5.1**







(B1) 110 DEPUTIES NORTH  
3/8" = 1'-0"

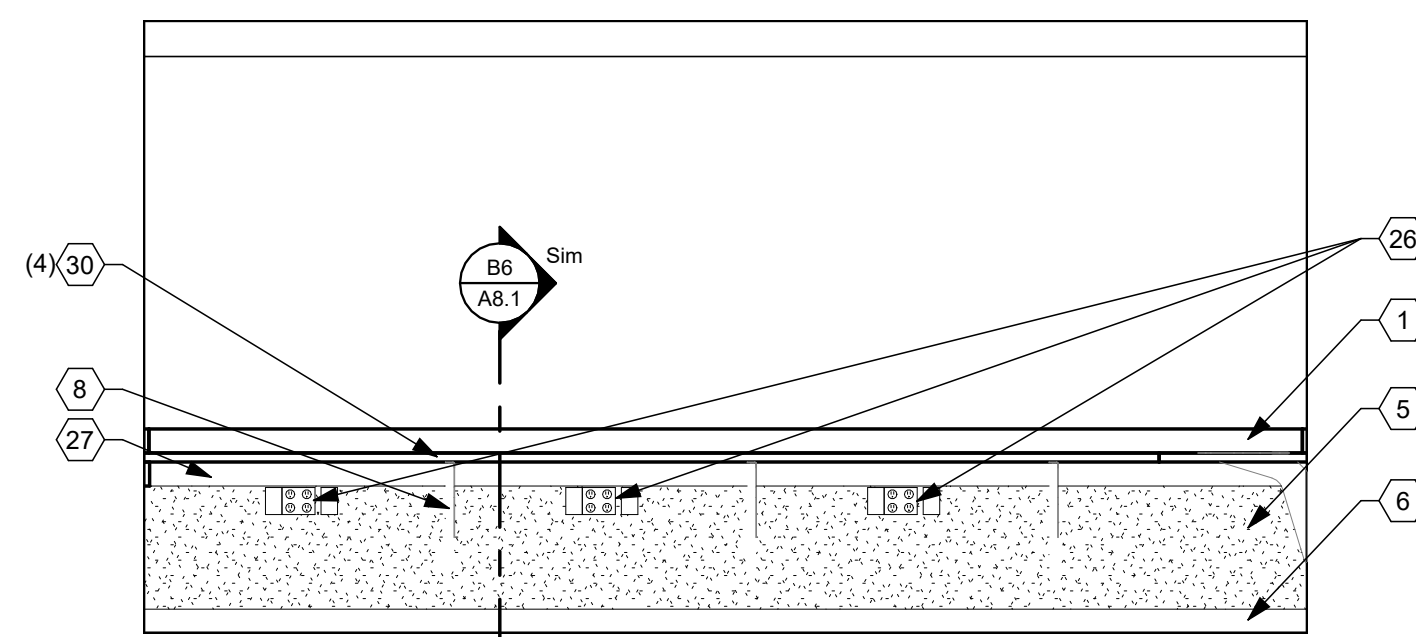


(B2) 110 DEPUTIES WEST  
3/8" = 1'-0"

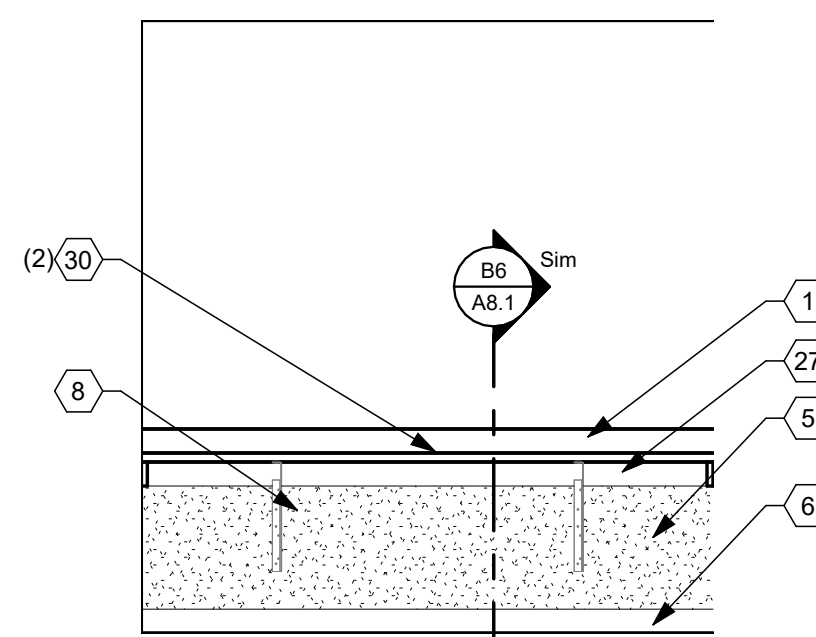


(B4) 123 BREATH WEST  
3/8" = 1'-0"

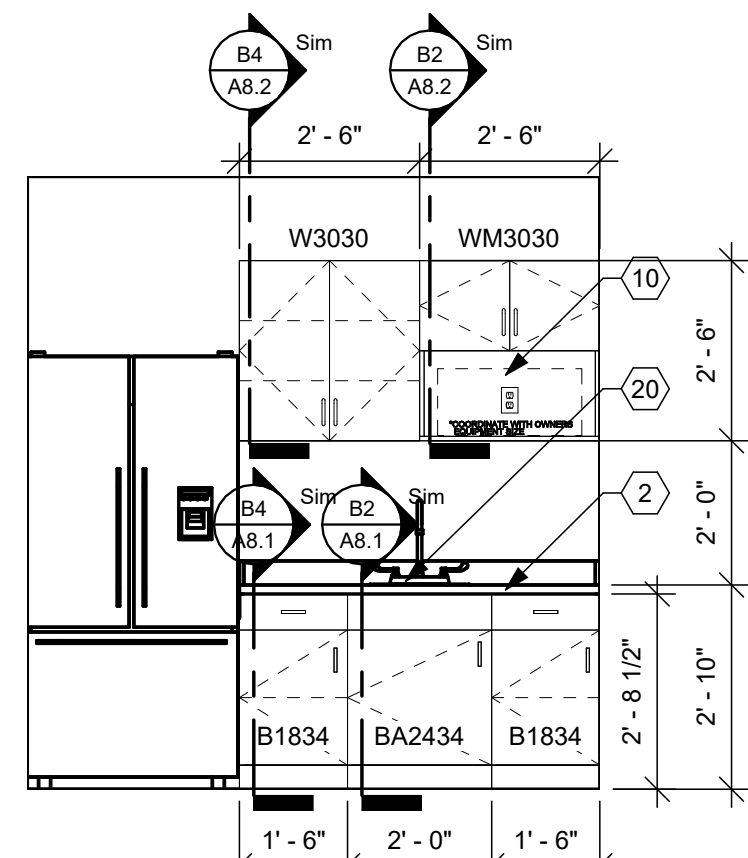


(C1) 130 BREAK ROOM EAST  
3/8" = 1'-0"

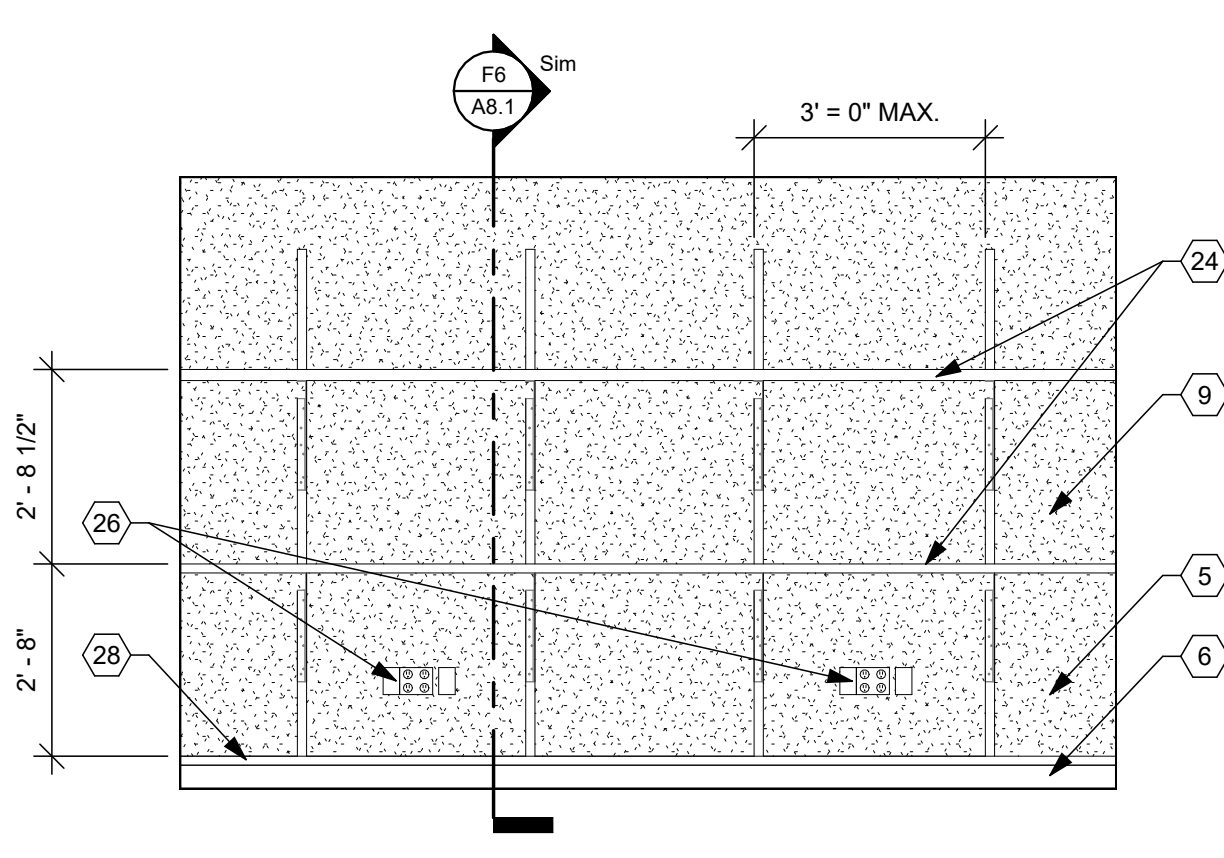


(C2) 128 EQUIPMENT BAGS  
3/8" = 1'-0"

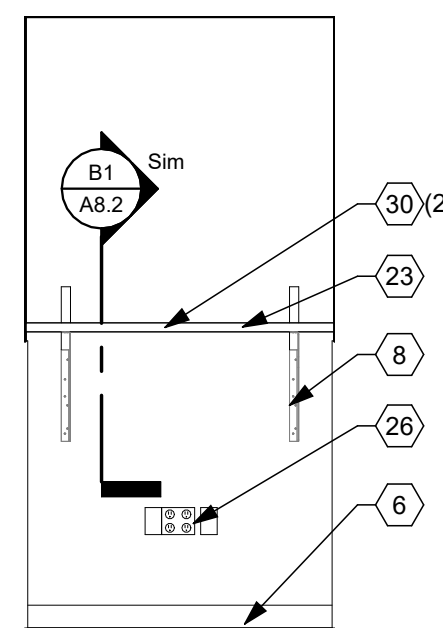


C3 125 CHARGING NORTH  
3/8" = 1'-0"

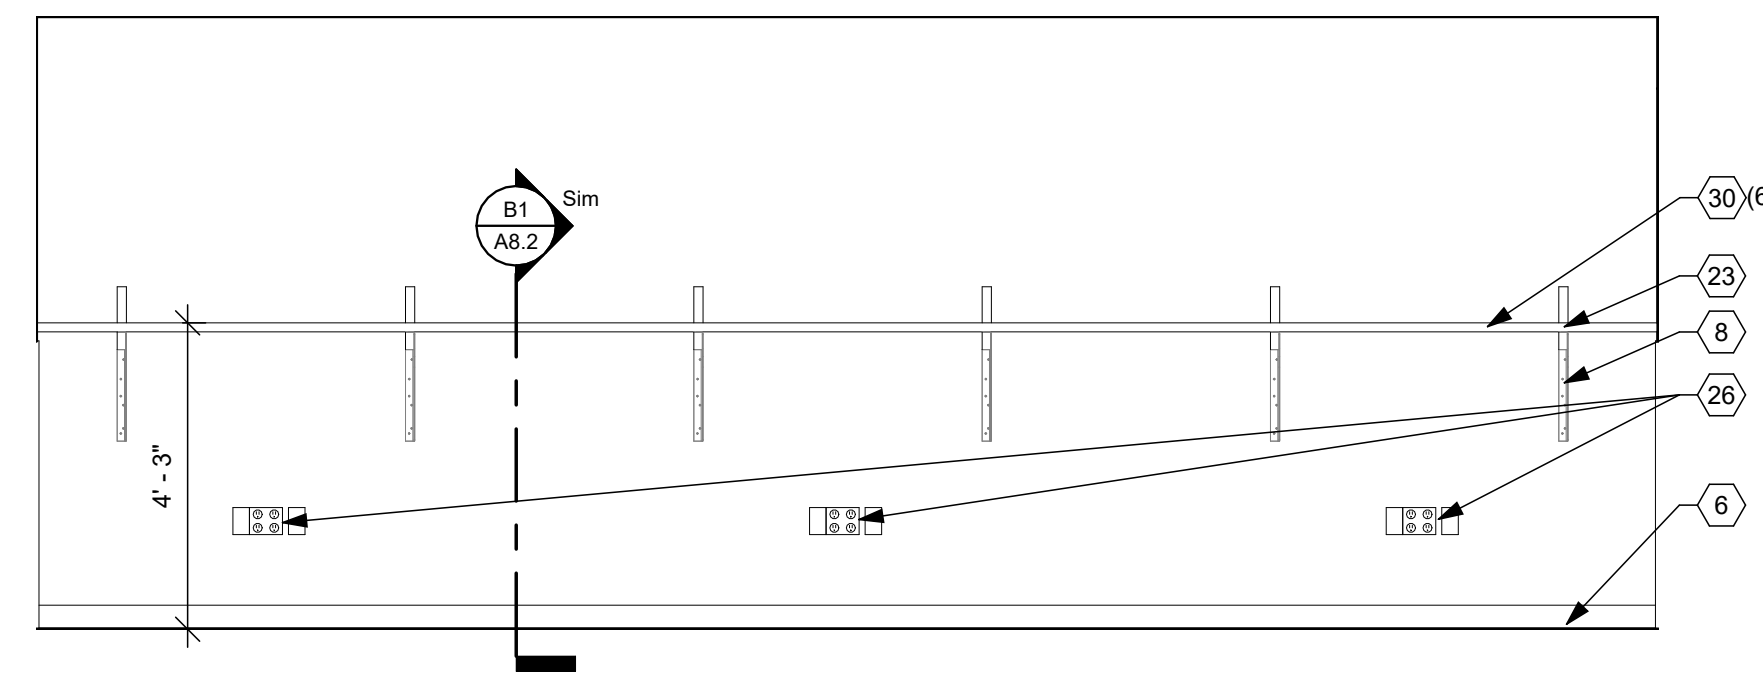


C4 140 CORRIDOR CHARGING SOUTH  
3/8" = 1'-0"

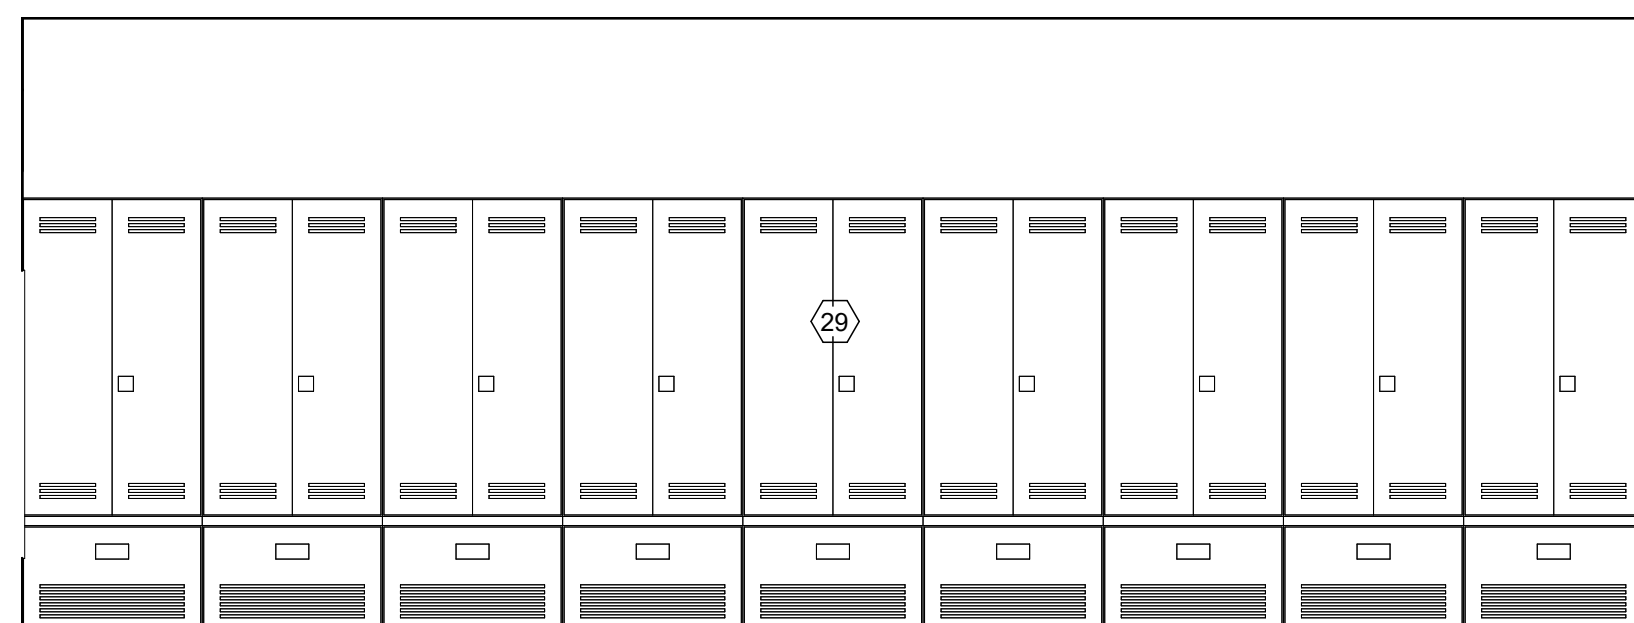


E1 139 LOCKERS NORTH  
3/8" = 1'-0"

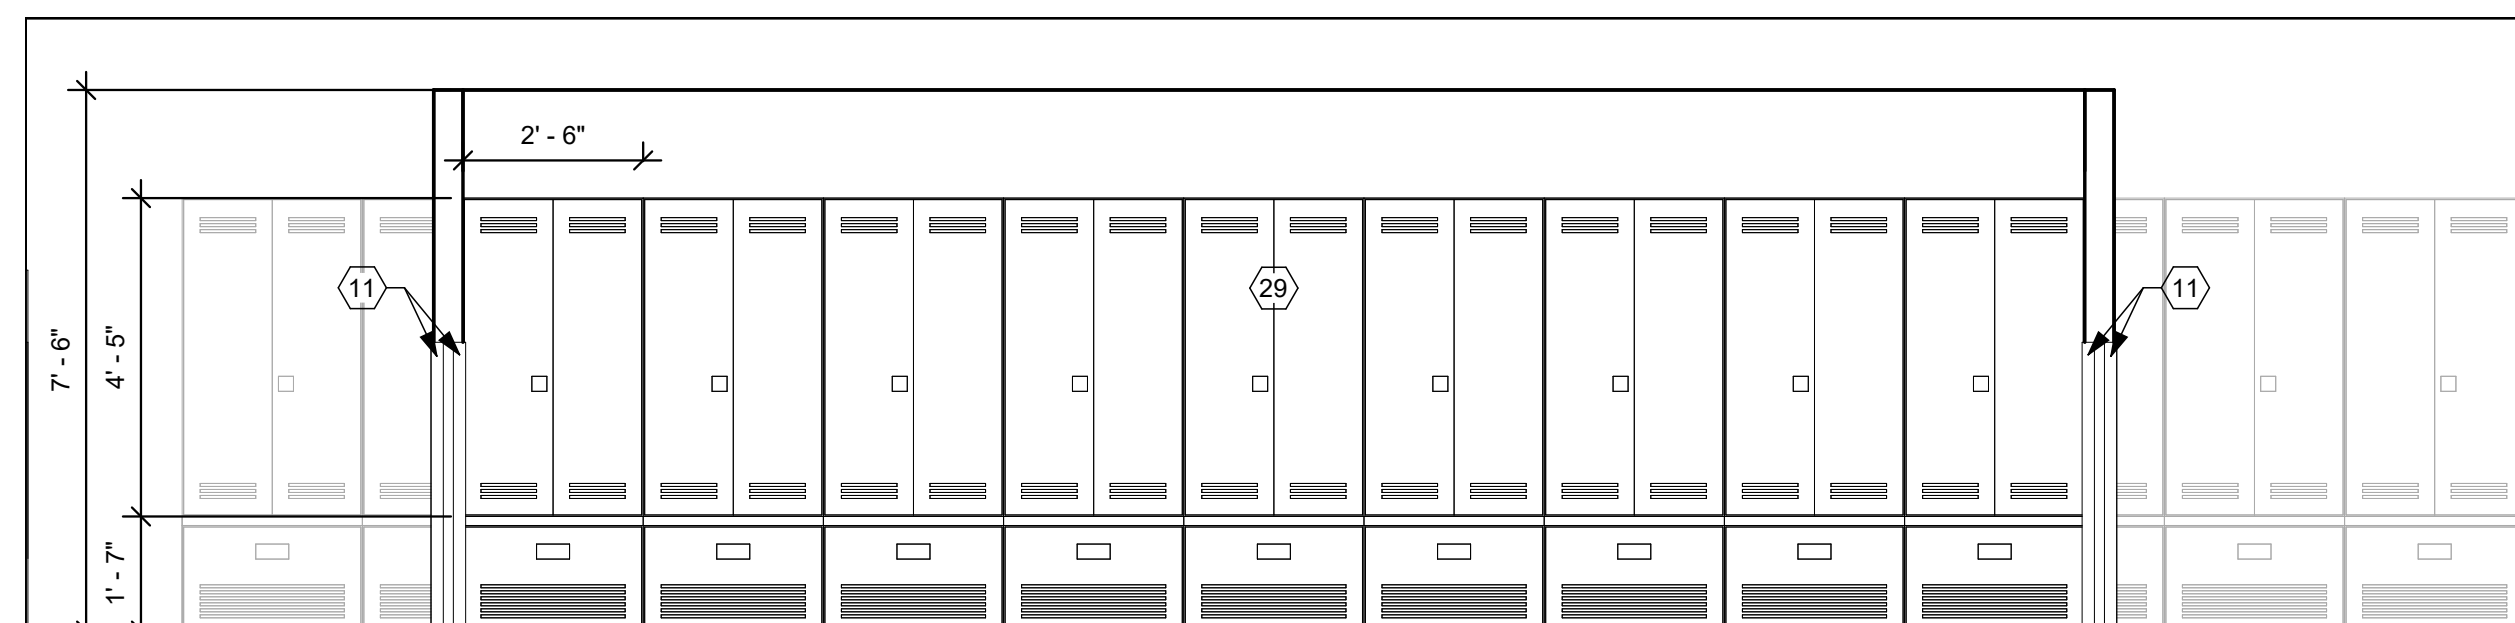

E3 139 LOCKERS SOUTH  
3/8" = 1'-0"

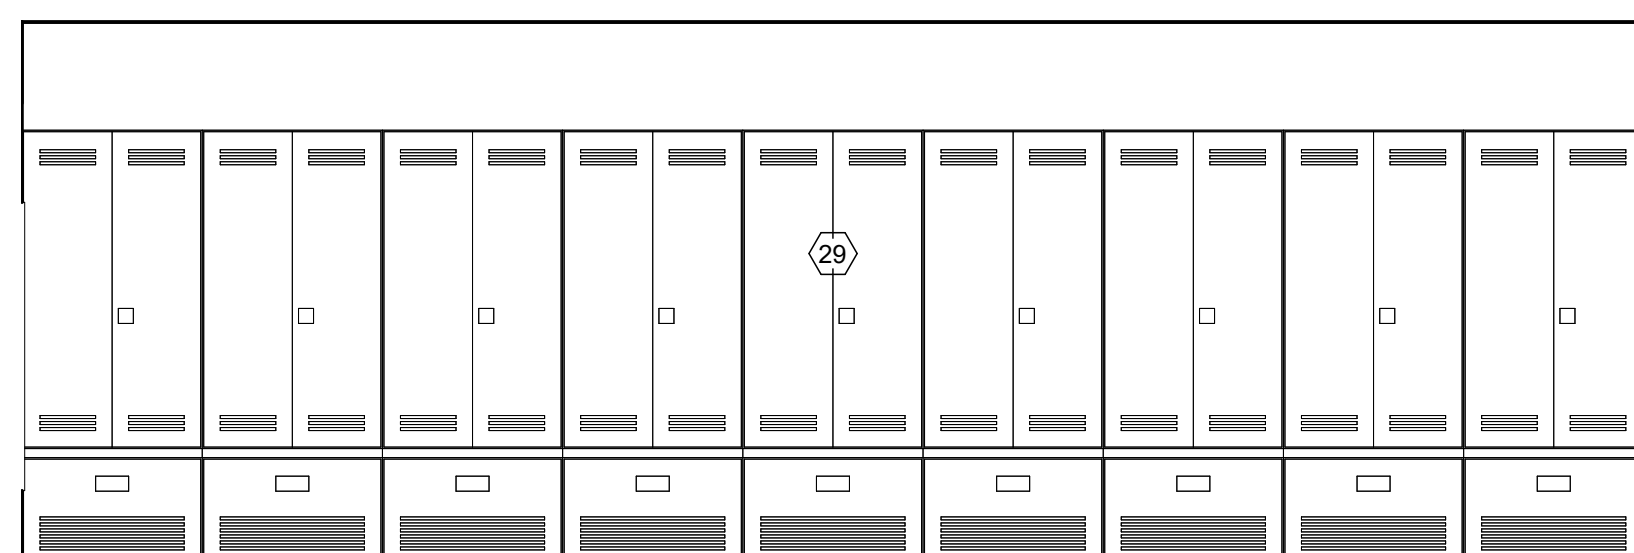

F1 139 LOCKERS NORTH  
3/8" = 1'-0"

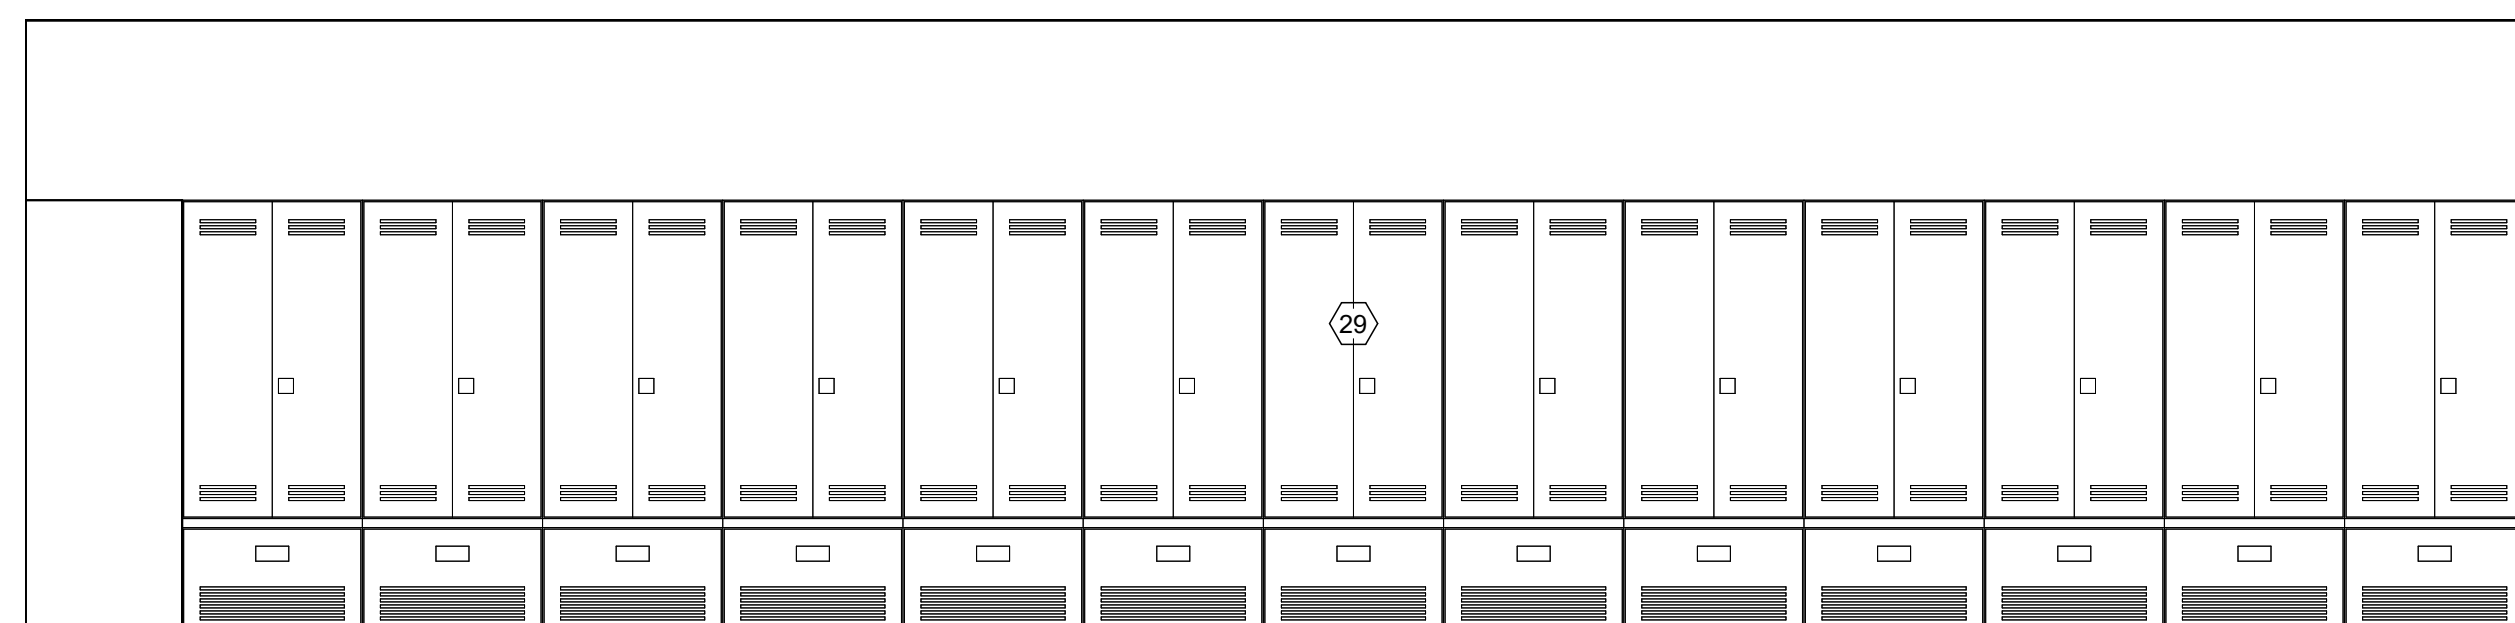

F3 139 LOCKERS SOUTH  
3/8" = 1'-0"

## CONSTRUCTION NOTES

00 INDICATES CONSTRUCTION NOTE.

- 1 PLASTIC LAMINATE (PL-2) WORKSTATION COUNTER. REFER TO FINISH SCHEDULE.
- 2 SOLID SURFACE COUNTERTOP (SSM-1). REFER TO FINISH SCHEDULE.
- 3 SOLID SURFACE SHOWER AND ENCLOSURE. REFER TO SHEET A0.8 AND PLUMBING DRAWINGS FOR DETAILS.
- 4 12" x 24" WALL TILE (PT-2) ON WET WALLS. REFER TO FINISH SCHEDULE A0.2 AND FINISH FLOOR PLAN A9.1
- 5 HIGH ABUSE VINYL WALL PROTECTION UP TO COUNTER. REFER TO FINISH SCHEDULE A0.2 AND FINISH FLOOR PLAN A9.1.
- 6 RUBBER (RB-1) BASE. REFER TO FINISH SCHEDULE A0.2 AND FINISH FLOOR PLAN A9.1.
- 7 CERAMIC TILE WALL BASE 4" (CTWB-2) BASE. REFER TO FINISH SCHEDULE A0.2 AND FINISH FLOOR PLAN A9.1.
- 8 METAL WORKTOP SUPPRT BRACKET. TYP. SPACING 4'-0" O.C. MAX. COLOR AS SPECIFIED.
- 9 HIGH ABUSE VINYL WALL PROTECTION BEHIND SHELVING. REFER TO FINISH SCHEDULE A0.2 AND FINISH FLOOR PLAN A9.1.
- 10 MICROWAVE CABINET. COORDINATE PLACEMENT OF ELECTRICAL OUTLET.
- 11 CORNER GUARD. REFER TO FINISH SCHEDULE A0.2 AND FINISH FLOOR PLAN A9.1.
- 12 WALL MOUNTED GRAB BARS. REFER TO MOUNTING AND CLEARANCE STANDARDS ON SHEET A0.1.
- 13 WALL MOUNTED PAPER TOWEL DISPENSER. C-FOLD TYPE.
- 14 WALL MOUNTED SOAP DISPENSER.
- 15 WALL MOUNTED TOILET TISSUE DISPENSER.
- 16 WALL MOUNTED WASTE RECEPTACLE.
- 17 SHOWER MOUNTED GRAB BARS. REFER TO MOUNTING AND CLEARANCE STANDARDS ON SHEET A0.1.
- 18 SHOWER ROD. REFER TO SPECIFICATIONS.
- 19 INTEGRAL SOLID SURFACE SHOWER SHELVES.
- 20 SINK. REFER TO PLUMBING DRAWINGS.
- 21 24" x 36" WA.; HUNG MIRROR. REFER TO MOUNTING AND CLEARANCE STANDARDS ON SHEET A0.1 FOR DETAILS.
- 22 LIGHT FIXTURE MOUNTED ABOVE MIRROR. REFER TO ELECTRICAL DRAWINGS.
- 23 CHARGING PLASTIC LAMINATE SHELVING. REFER TO SHEET A8.2 B1.
- 24 HEAVY DUTY SHELVING AND BRACKETS AT 3'-0" O.C.
- 25 NOT USED.
- 26 ELECTRICAL OUTLETS. REFER TO ELECTRICAL DRAWINGS.
- 27 WALL CLEAT. PAINT.
- 28 PLASTIC LAMINATE BASED SHELF.
- 29 PREMANUFACTURED GEAR LOCKER UNITS. BASIS OF DESIGN AIRFLOW: SENTINEL LAW ENFORCEMENT LOCKERS. REFER TO SPECIFICATIONS.
- 30 PROVIDE GROMMETS IN QUANTITIES INDICATED. COORDINATE LOCATION IN FIELD.
- 31 ROBE HOOK.

## GENERAL NOTES

- A. EXAMPLE OF CASEWORK DIMENSIONS (2438)  
INDICATES 24" WIDTH X 36" HEIGHT. FOR DEPTH  
REFER TO TYPICAL CASEWORK DETAILS U.N.O.
- B. PROVIDE 3/4" PLASTIC LAMINATE SCRIBE AGAINST  
FINISHED WALLS AT BASE, WALL AND TALL  
CABINETS.
- C. ALL BASE & WALL CABINET PL-2 U.N.O.
- D. INSTALL SOLID WOOD (FIRE TREATED)  
(CONTRACTOR OPTION STEEL) BLOCKING IN  
WALLS BEHIND WALL MOUNTED ITEMS INCLUDING  
CASEWORK, TOILET ACCESSORIES, ETC.
- E. REFER TO ELECTRICAL DRAWINGS FOR ELECTRICAL  
RECEPTACLE LOCATIONS.
- F. ALL PLASTIC LAMINATE GRAIN TO RUN VERTICALLY  
U.N.O.
- G. ALL OUTSIDE CORNERS OF PLAM COUNTERTOPS  
SHALL PROJECT 1" PAST CABINET/SUPPORT AND  
SHALL HAVE 1 1/2" RADIUS CORNER EXCEPT AT  
REFRIGERATORS AND SINKS WHERE SQUARE  
CORNERS AND 1/4" PROJECTION SHALL BE USED.
- H. ALL COUNTERTOPS 25" DEEP U.N.O.
- I. REFER TO SHEET AD. 2 FOR FINISHES DESCRIPTION  
AND ABBREVIATIONS.
- J. REFER TO SHEET AD. 1 FOR TOILET ACCESSORY  
MOUNTING HEIGHTS.

A

3

C


D

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Todd A. Gindelberger, License #12147  
Expiration Date 12/31/2027

## Harrison Township District 10 Sheriff Substation Renovation

6001 N Dixie Dr, Dayton, OH 45414

ISSUE		
NO.	DATE	DESCRIPTION
	01/22/2026	FOR CONSTRUCTION
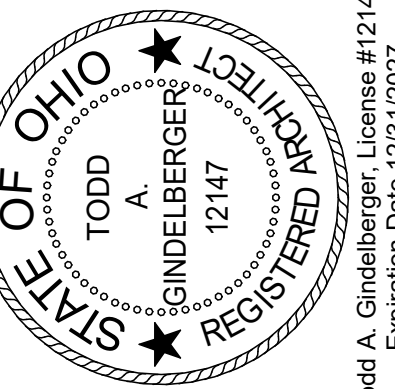
## INTERIOR ELEVATIONS

SHEET NO.

## A7.1



A


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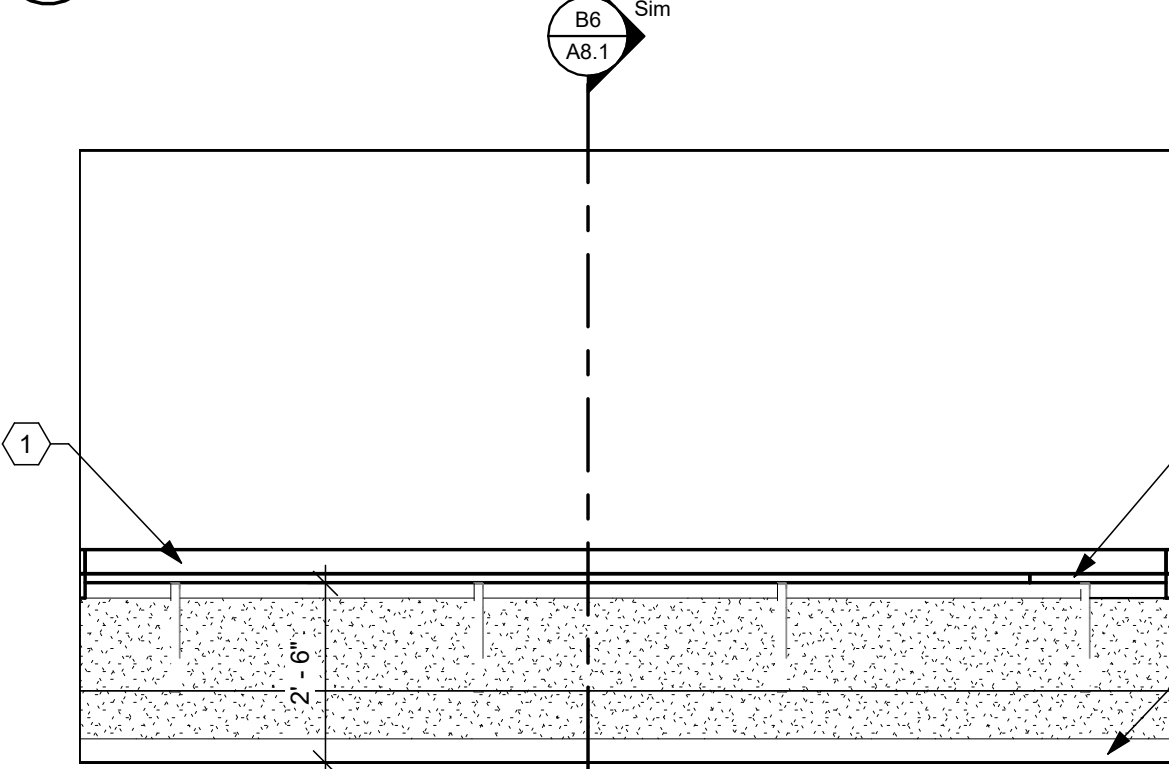
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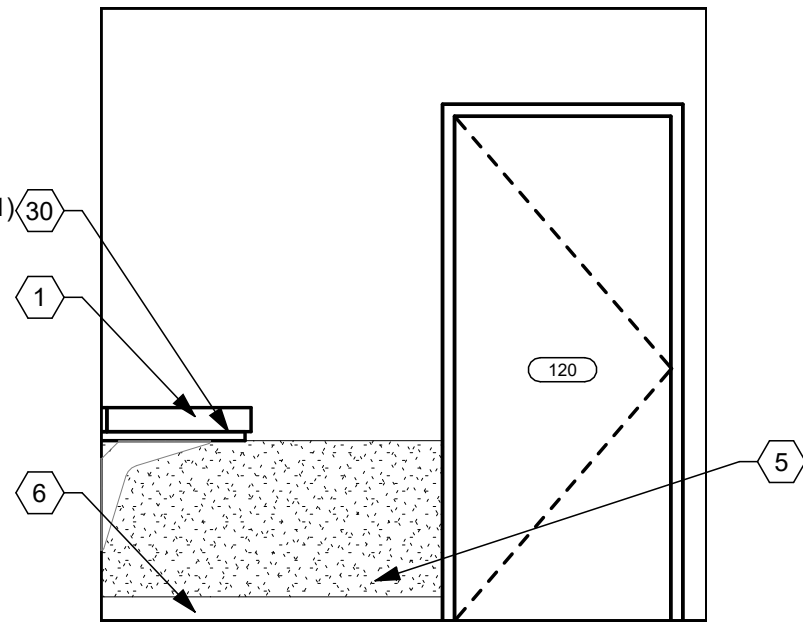
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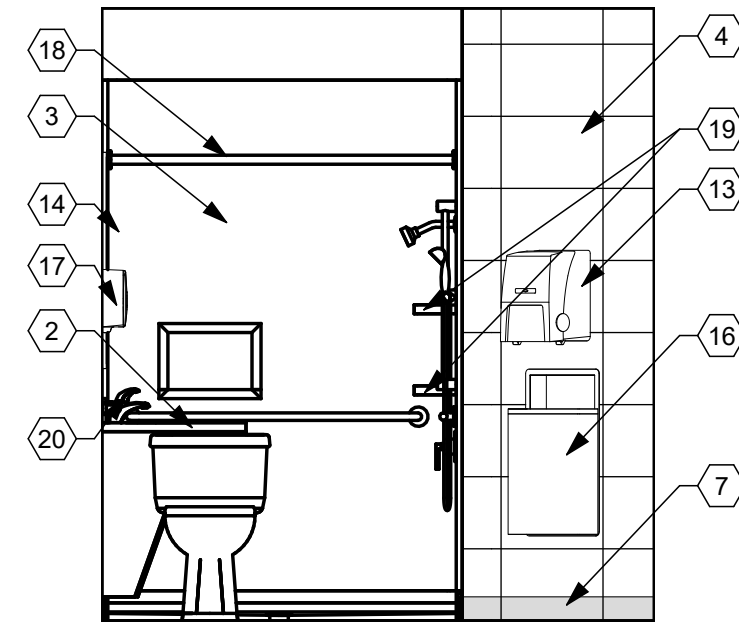
**C1 ENLARGED FLOOR PLAN D**  
1/4" = 1'-0"




**E1 119 COP EAST**  
3/8" = 1'-0"




**E2 120 TRAFFIC NORTH**  
3/8" = 1'-0"

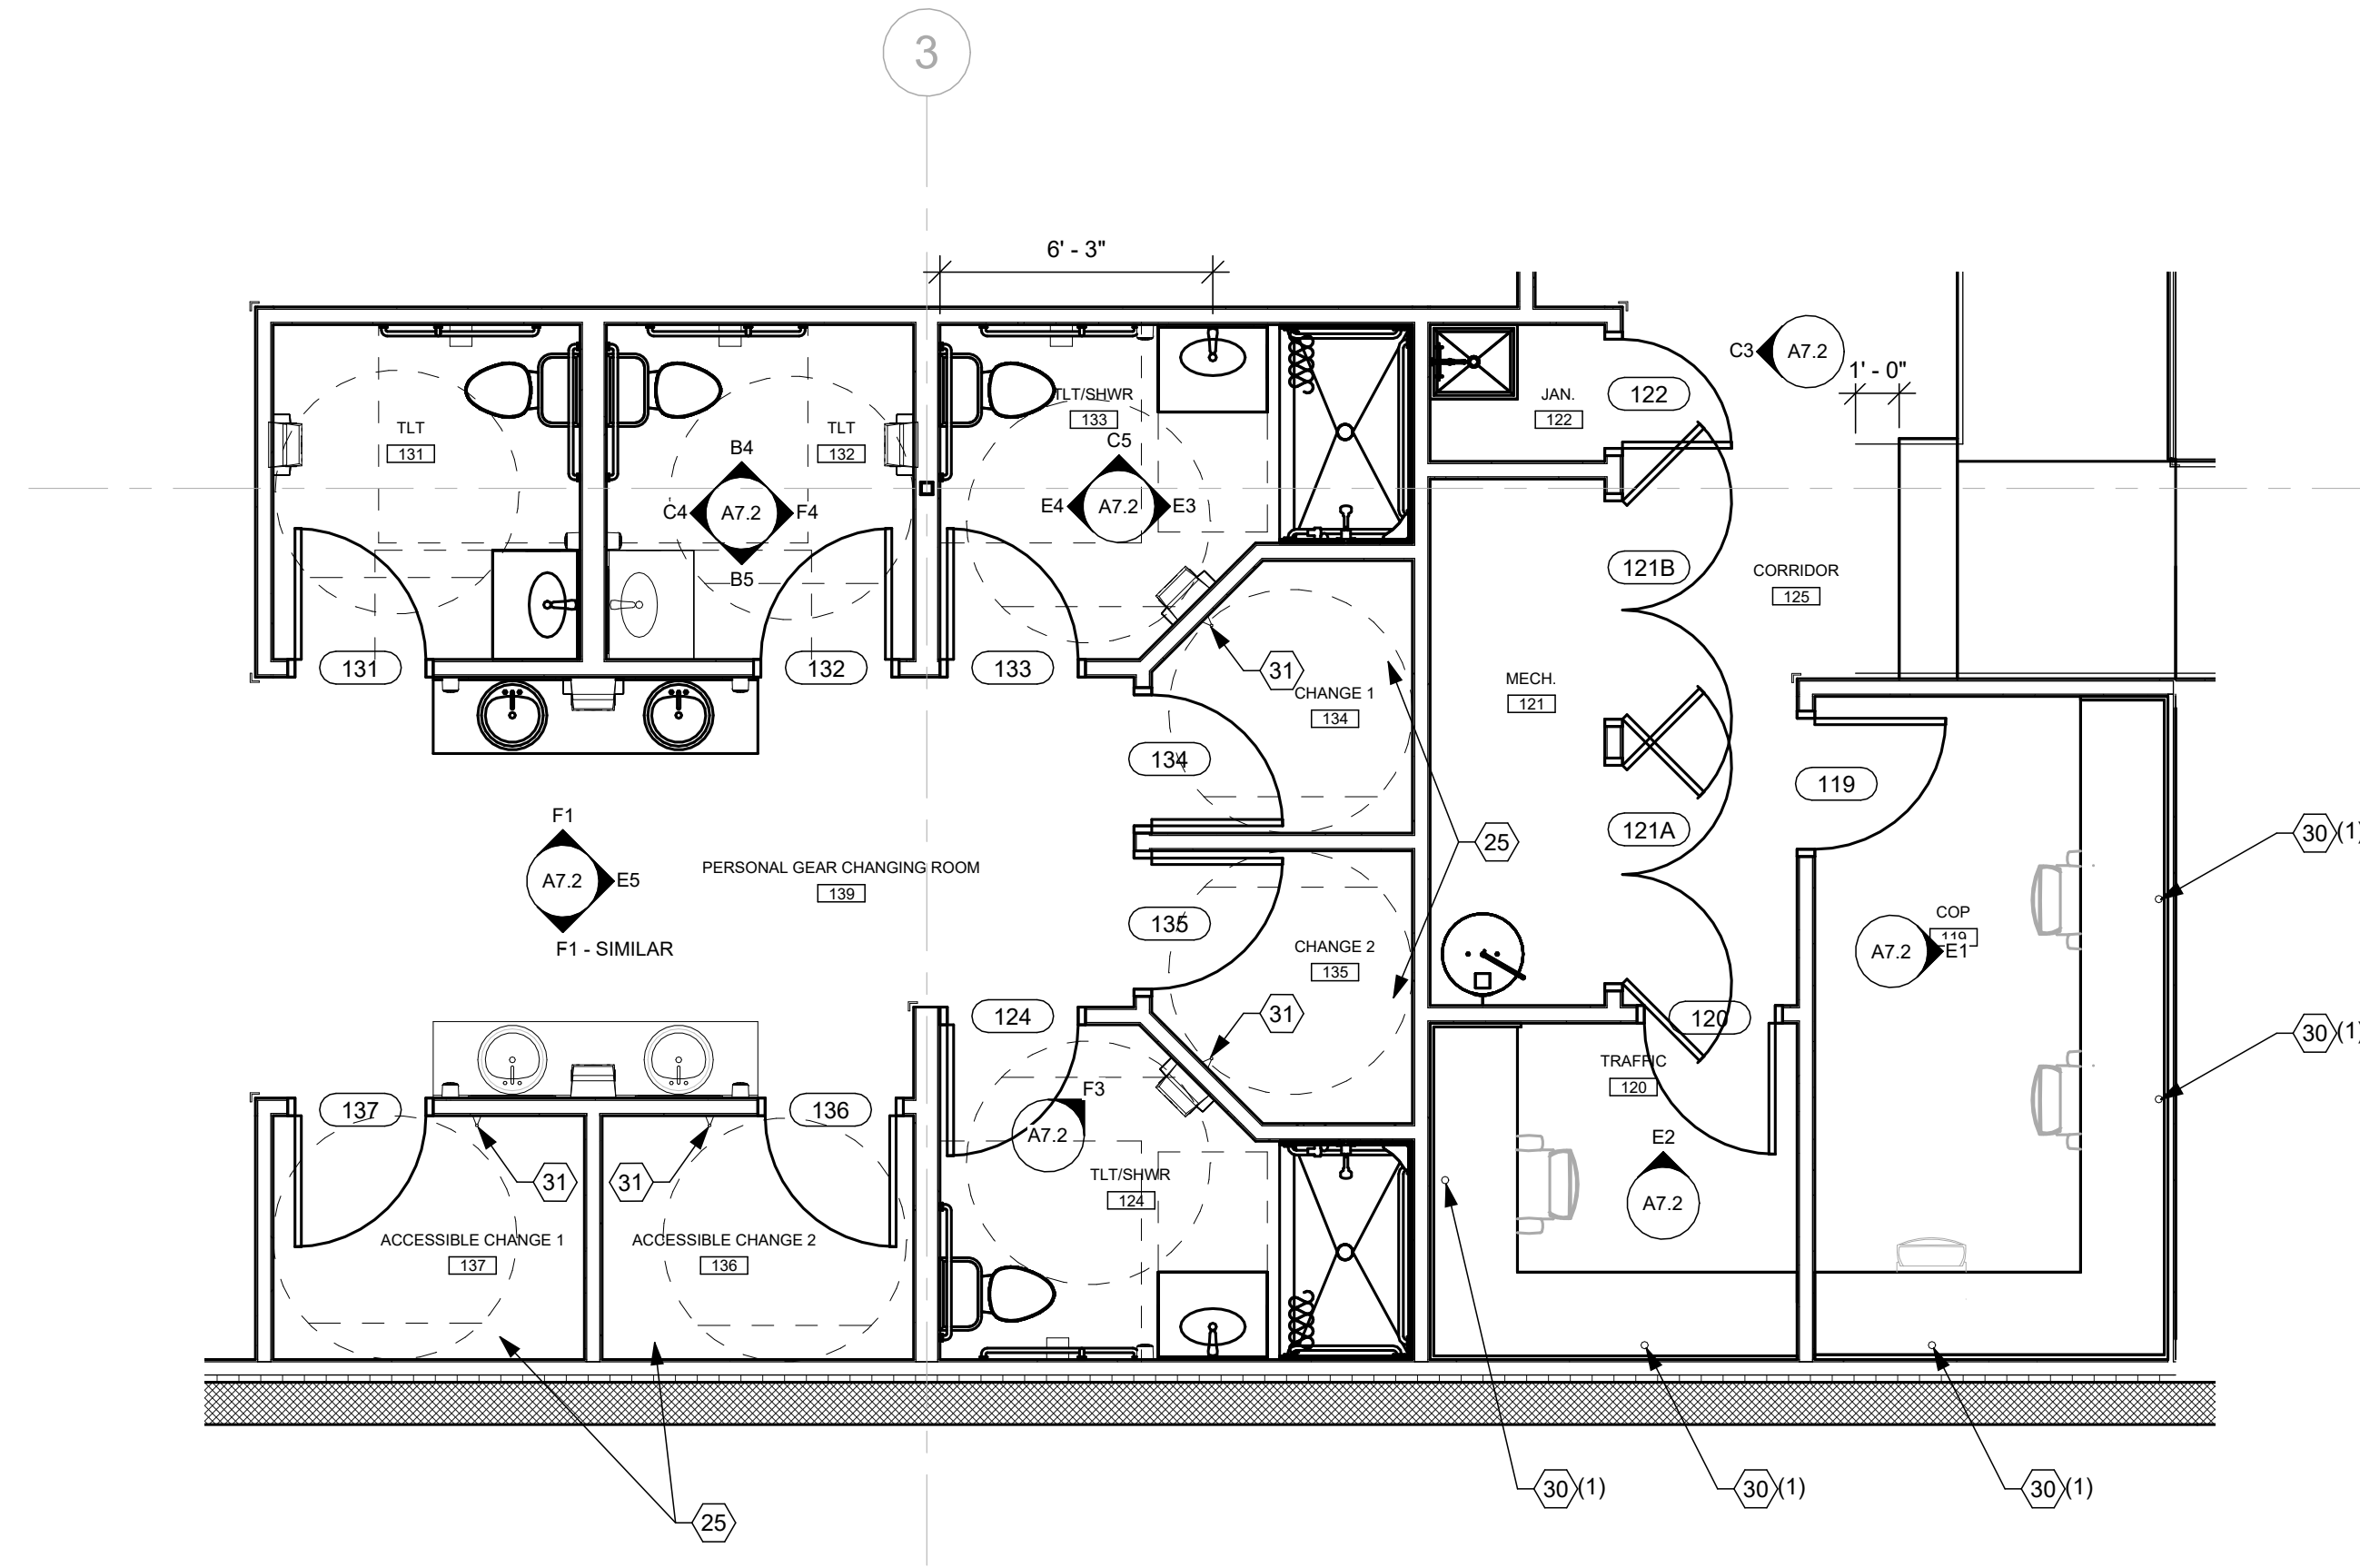


**E3 134 ADA TLT EAST**  
3/8" = 1'-0"

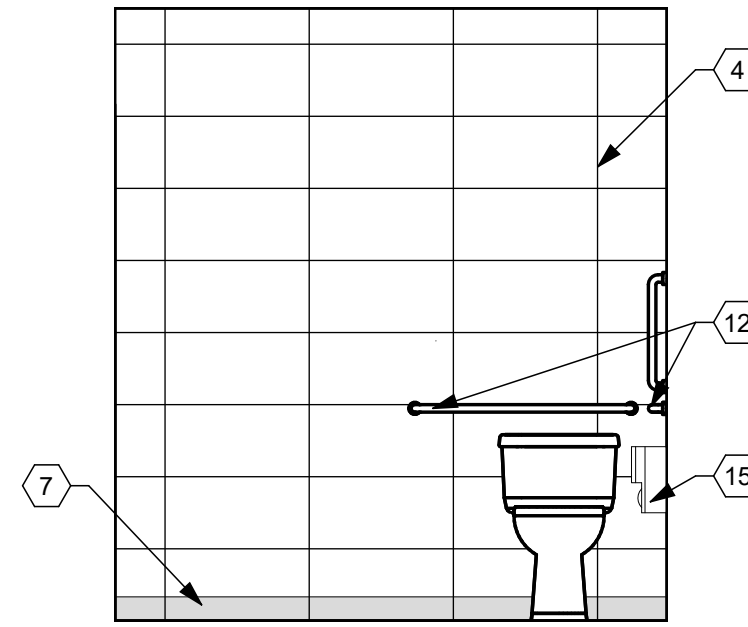


**E4 134 ADA TLT WEST**  
3/8" = 1'-0"

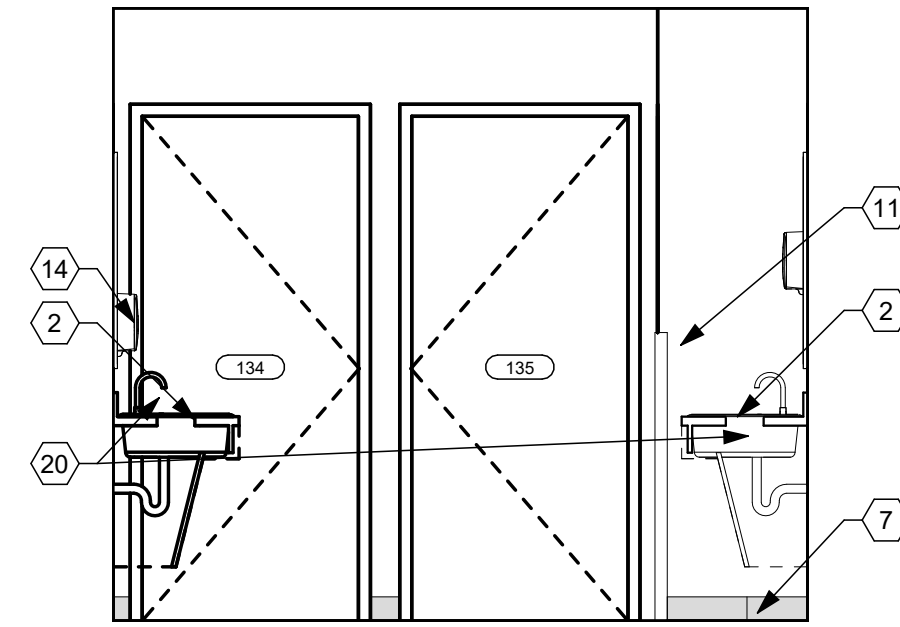


**E5 139 PERSONAL GEAR CHANGING EAST**  
3/8" = 1'-0"

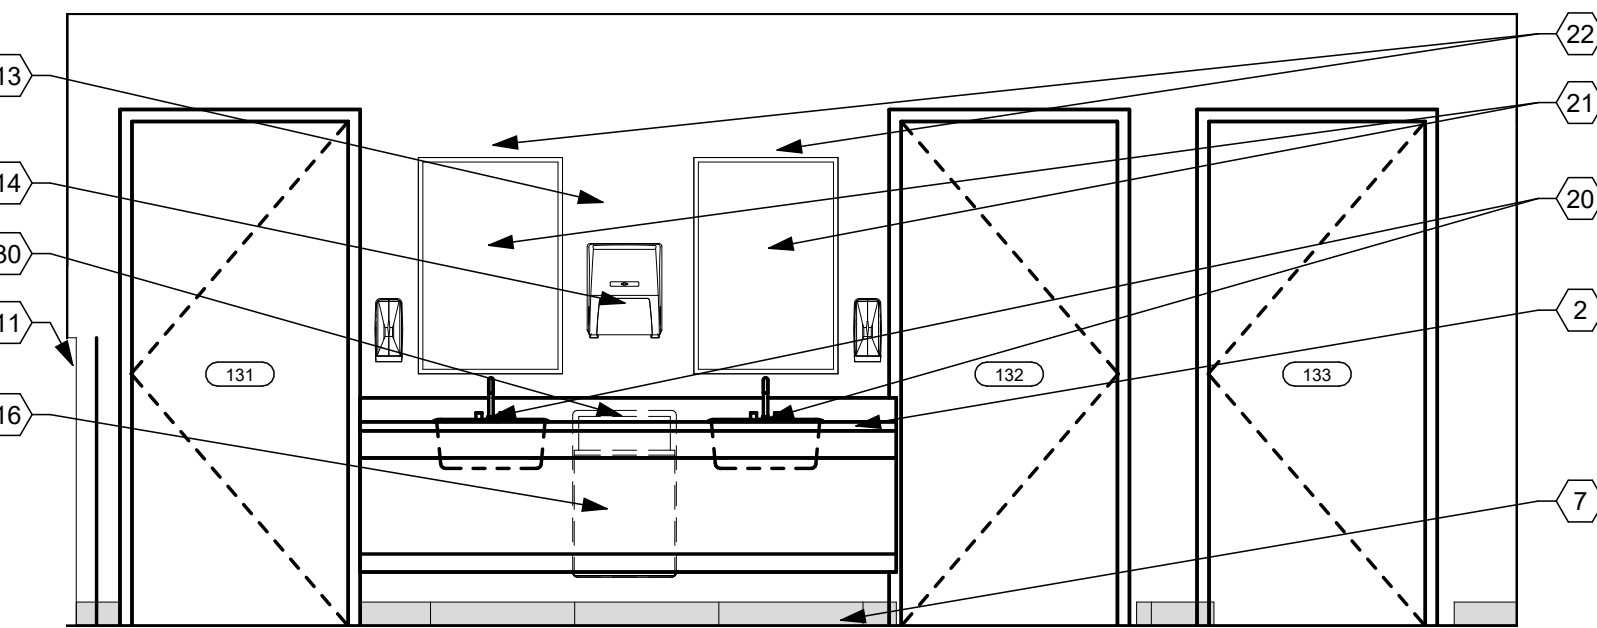


**F1 139 PERSONAL GEAR CHANGING NORTH**  
3/8" = 1'-0"

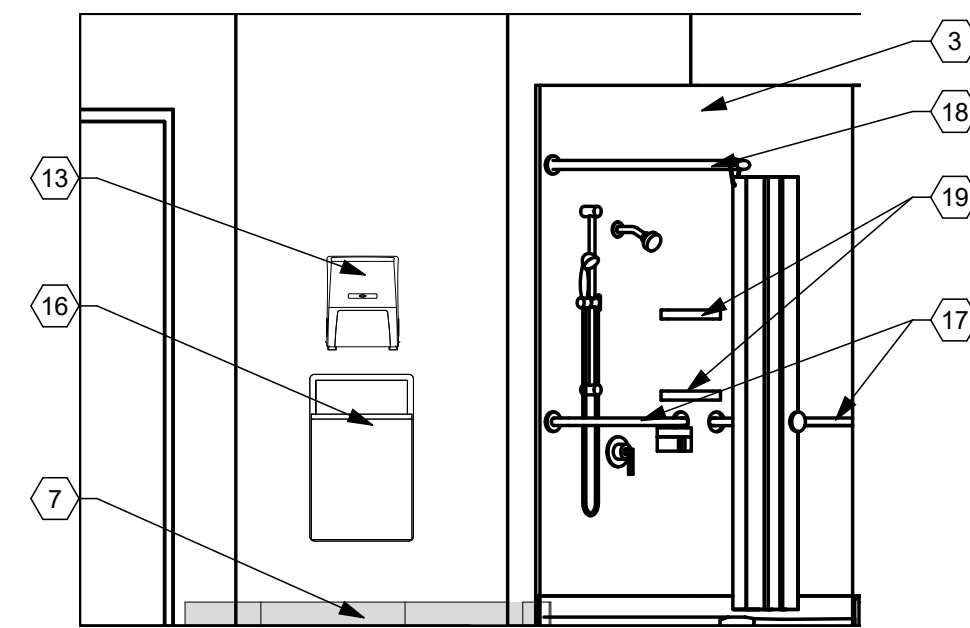


**F3 124 TLT/SHWR NORTH EAST**  
3/8" = 1'-0"

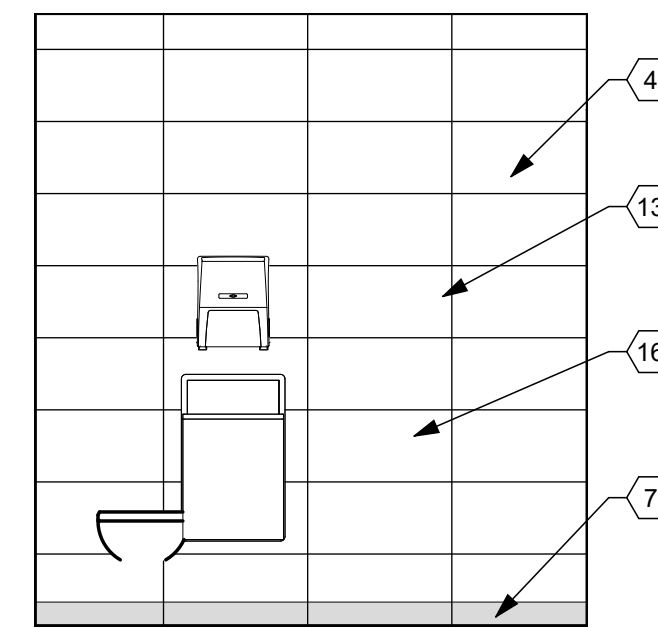


**F4 132 TLT EAST**  
3/8" = 1'-0"

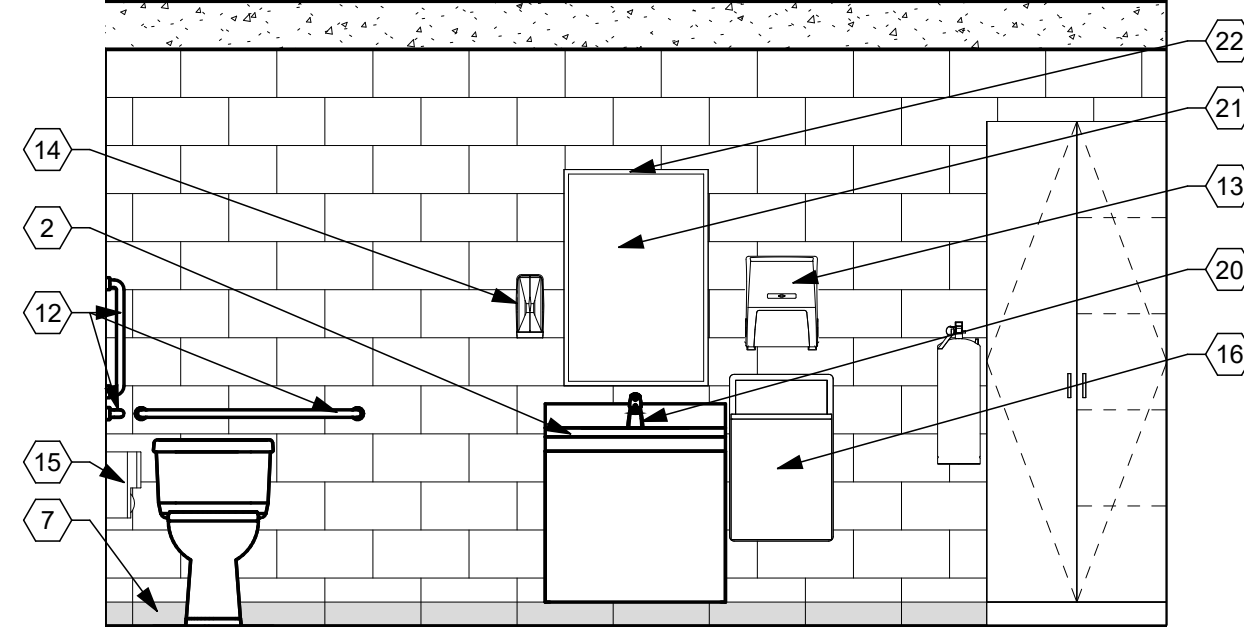


**F5 118 TLT/STORM SHELTER WEST**  
3/8" = 1'-0"

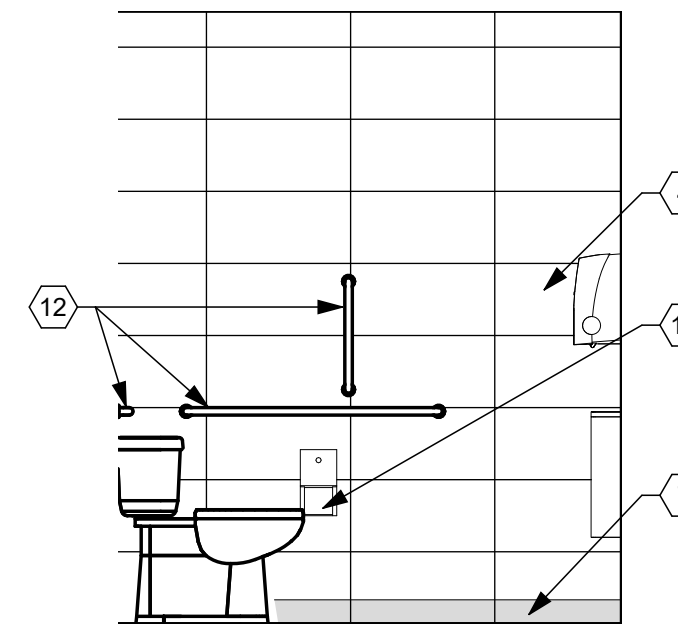


**B4 132 TLT NORTH**  
3/8" = 1'-0"

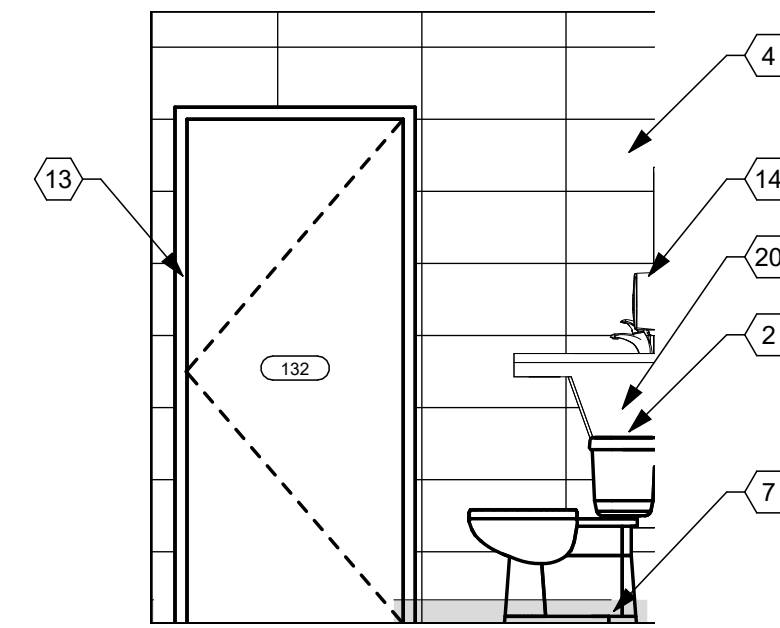

**B5 132 TLT SOUTH**  
3/8" = 1'-0"

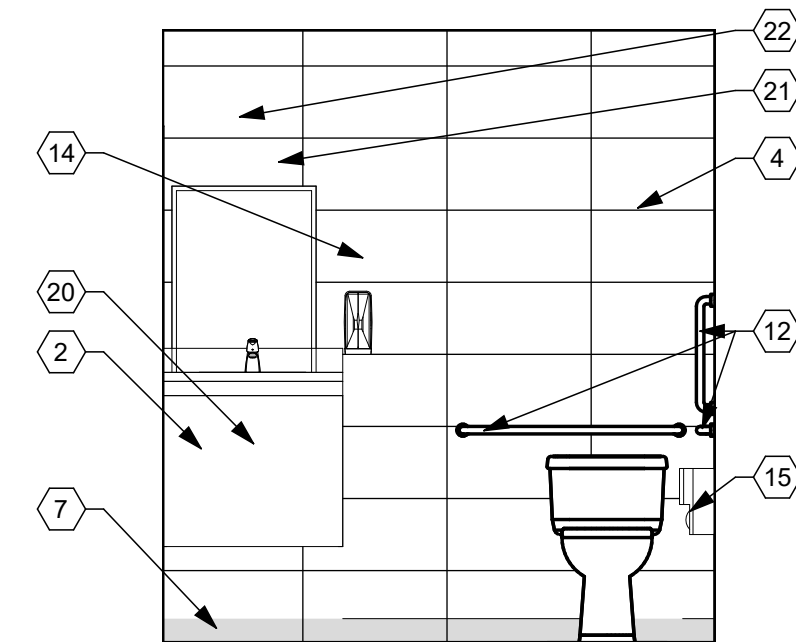


**C4 132 TLT WEST**  
3/8" = 1'-0"

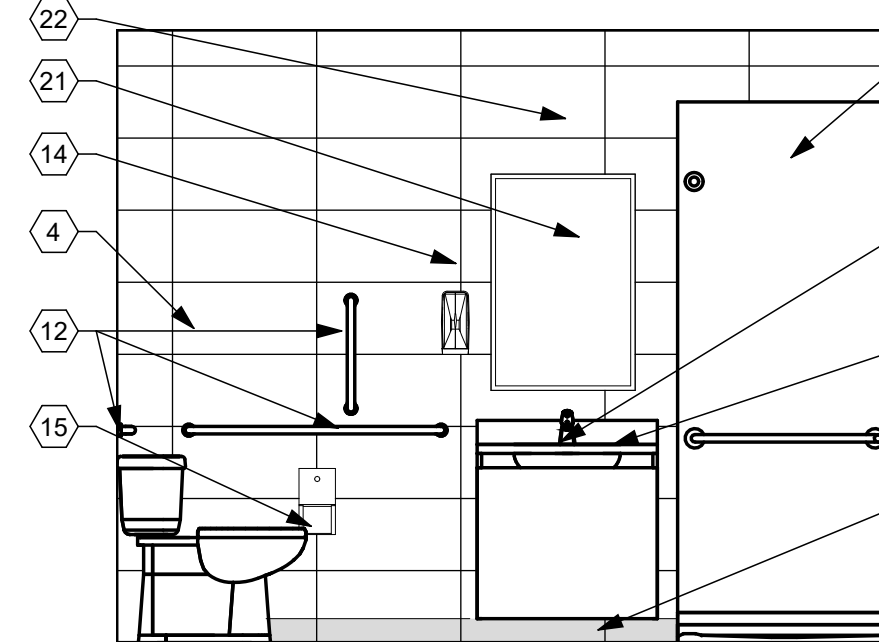

**C5 133 ADA TLT NORTH**  
3/8" = 1'-0"

**C3 122 JAN. WEST**  
3/8" = 1'-0"

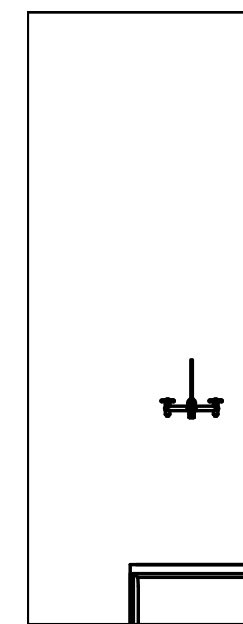

## CONSTRUCTION NOTES

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  - 6 RUBBER (RB-1) BASE. REFER TO FINISH SCHEDULE A0.2 AND FINISH FLOOR PLAN A9.1.
  - 7 CERAMIC TILE WALL BASE 4" (CTWB-2) BASE. REFER TO FINISH SCHEDULE A0.2 AND FINISH FLOOR PLAN A9.1.
  - 8 METAL WORKTOP SUPPRT BRACKET. TYP. SPACING 4'-0" O.C. MAX. COLOR AS SPECIFIED.
  - 9 HIGH ABUSE VINYL WALL PROTECTION BEHIND SHELVE. REFER TO FINISH SCHEDULE A0.2 AND FINISH FLOOR PLAN A9.1.
  - 10 MICROWAVE CABINET. COORDINATE PLACEMENT OF ELECTRICAL OUTLET.
  - 11 CORNER GUARD. REFER TO FINISH SCHEDULE A0.2 AND FINISH FLOOR PLAN A9.1.
  - 12 WALL MOUNTED GRAB BARS. REFER TO MOUNTING AND CLEARANCE STANDARDS ON SHEET A0.1.
  - 13 WALL MOUNTED PAPER TOWEL DISPENSER. C-FOLD TYPE.
  - 14 WALL MOUNTED SOAP DISPENSER.
  - 15 WALL MOUNTED TOILET TISSUE DISPENSER.
  - 16 WALL MOUNTED WASTE RECEPTACLE.
  - 17 SHOWER MOUNTED GRAB BARS. REFER TO MOUNTING AND CLEARANCE STANDARDS ON SHEET A0.1.
  - 18 SHOWER ROD. REFER TO SPECIFICATIONS.
  - 19 INTEGRAL SOLID SURFACE SHOWER SHELVE.
  - 20 SINK. REFER TO PLUMBING DRAWINGS.
  - 21 24" x 36" WA.: HUNG MIRROR. REFER TO MOUNTING AND CLEARANCE STANDARDS ON SHEET A0.1 FOR DETAILS.
  - 22 LIGHT FIXTURE MOUNTED ABOVE MIRROR. REFER TO ELECTRICAL DRAWINGS.
  - 23 CHARGING PLASTIC LAMINATE SHELVE. REFER TO SHEET A8.2 B1.
  - 24 HEAVY DUTY SHELVE AND BRACKETS AT 3'-0" O.C.
  - 25 NOT USED.
  - 26 ELECTRICAL OUTLETS. REFER TO ELECTRICAL DRAWINGS.
  - 27 WALL CLEAT. PAINT.
  - 28 PLASTIC LAMINATE BASED SHELVE.
  - 29 PREMANUFACTURED GEAR LOCKER UNITS. BASIS OF DESIGN AIRFLOW: SENTINEL LAW ENFORCEMENT LOCKERS. REFER TO SPECIFICATIONS.
  - 30 PROVIDE GROMMETS IN QUANTITIES INDICATED. COORDINATE LOCATION IN FIELD.
  - 31 ROBE HOOK.

## GENERAL NOTES

- A. EXAMPLE OF CASEWORK DIMENSIONS (2436) INDICATES 24" WIDTH X 36" HEIGHT. FOR DEPTH REFER TO TYPICAL CASEWORK DETAIL 5 U.N.O.
- B. PROVIDE 3/4" PLASTIC LAMINATE SCRIBE AGAINST FINISHED WALLS AT BASE, WALL AND TALL CABINETS.
- C. ALL BASE & WALL CABINET PL-2 U.N.O.
- D. INSTALL SOLID WOOD (FIRE TREATED) (CONTRACTOR OPTION SHEET STEEL) BLOCKING IN WALLS BEHIND WALL MOUNTED ITEMS INCLUDING CASEWORK, TOILET ACCESSORIES, ETC.
- E. REFER TO ELECTRICAL DRAWINGS FOR ELECTRICAL RECEPTACLE LOCATIONS.
- F. ALL PLASTIC LAMINATE GRAIN TO RUN VERTICALLY U.N.O.
- G. ALL OUTSIDE CORNERS OF PLAM COUNTERTOPS SHALL PROJECT 1" PAST CABINET/SUPPORT AND SHALL HAVE 1/2" RADIUS CORNER EXCEPT AT REFRIGERATORS AND EQUIPMENT, WHERE SQUARE CORNERS AND 1/4" PROJECTION SHALL BE USED.
- H. ALL COUNTERTOPS 25" DEEP U.N.O.
- I. REFER TO SHEET A0.2 FOR FINISHES DESCRIPTION AND ABBREVIATIONS.
- J. REFER TO SHEET A0.1 FOR TOILET ACCESSORY MOUNTING HEIGHTS.

A

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**STATE OF OHIO**  
TODD A. GINDEBERGER  
12147  
REGISTERED ARCHITECT  
Expiration Date 12/31/2027

## Harrison Township District 10 Sheriff Substation Renovation

6001 N Dixie Dr, Dayton, OH 45414

ISSUE		
NO.	DATE	DESCRIPTION

01/22/2026 FOR CONSTRUCTION

DATE	01/22/2026
JOB NO.	4325.00
DRAWN	SEP
CHECKED	RFW

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TITLE  
**INTERIOR ELEVATIONS**

SHEET NO.

**A7.2**



12/1/2026 9:55:37 AM

A


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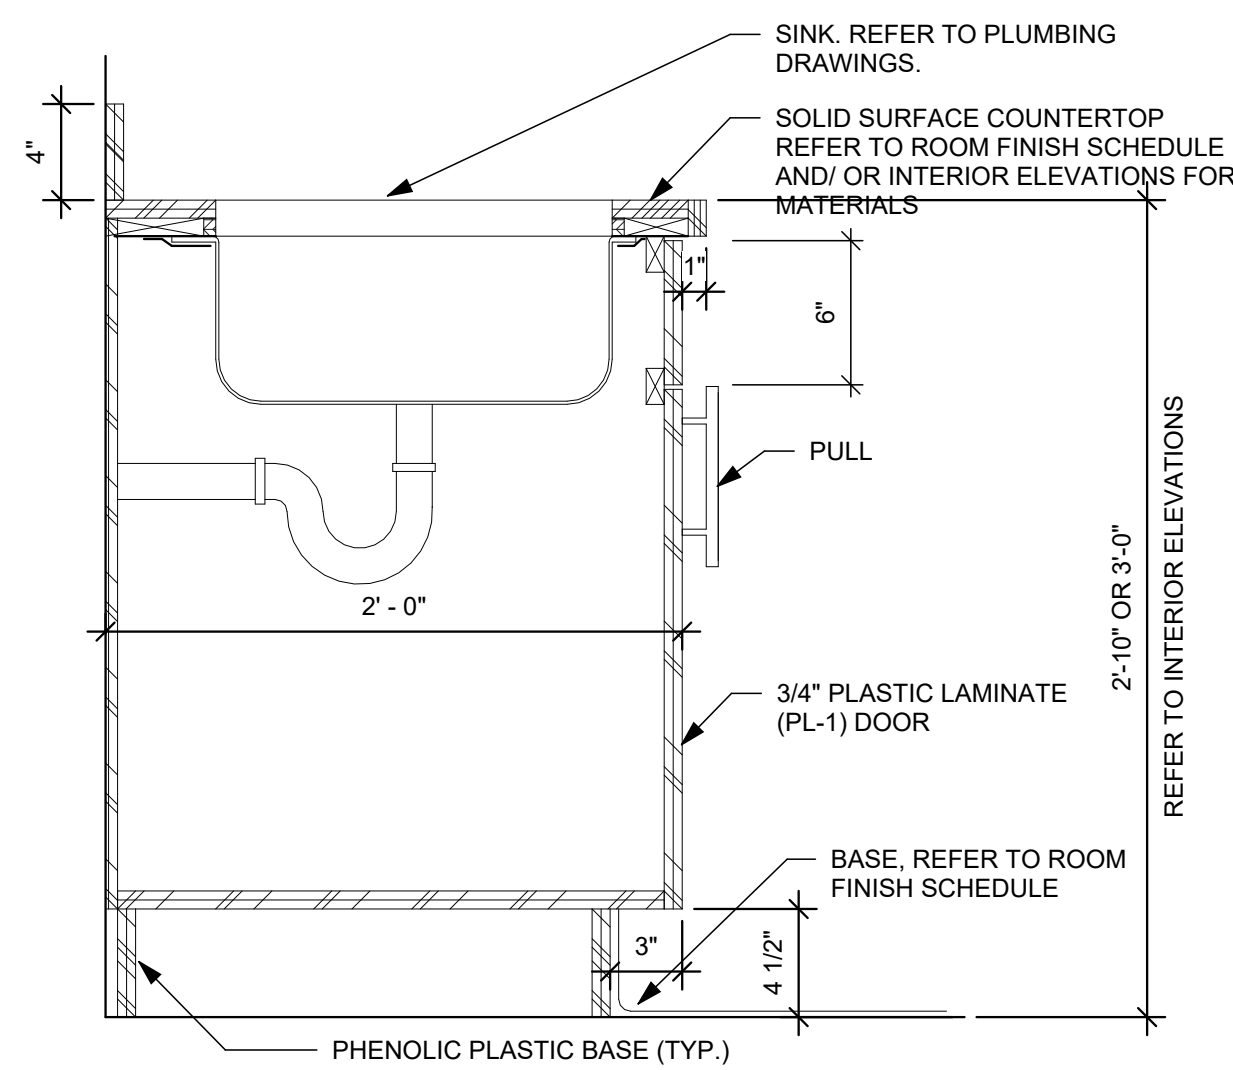
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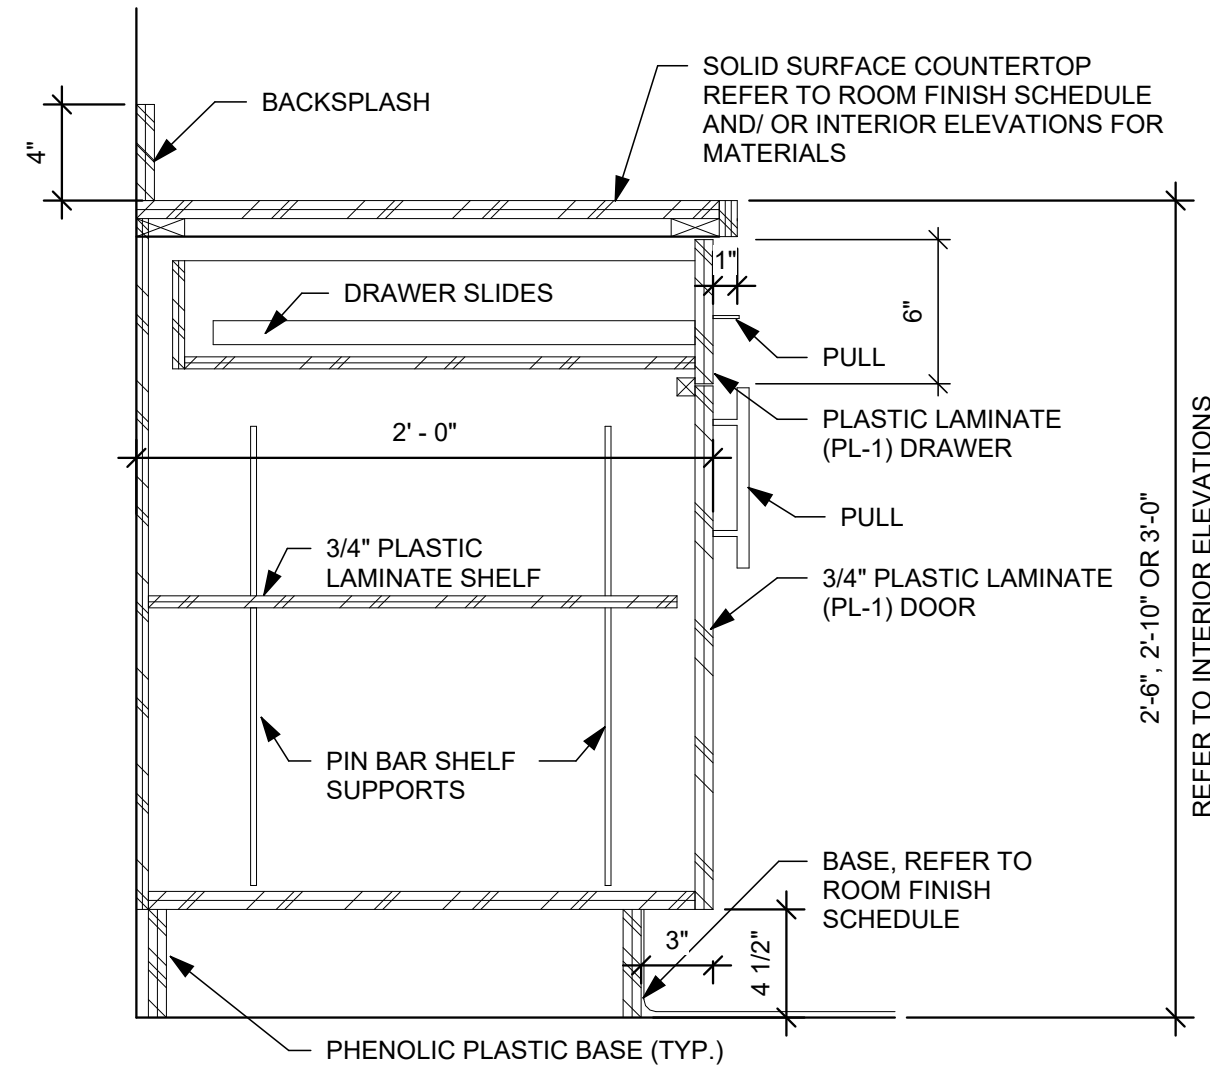
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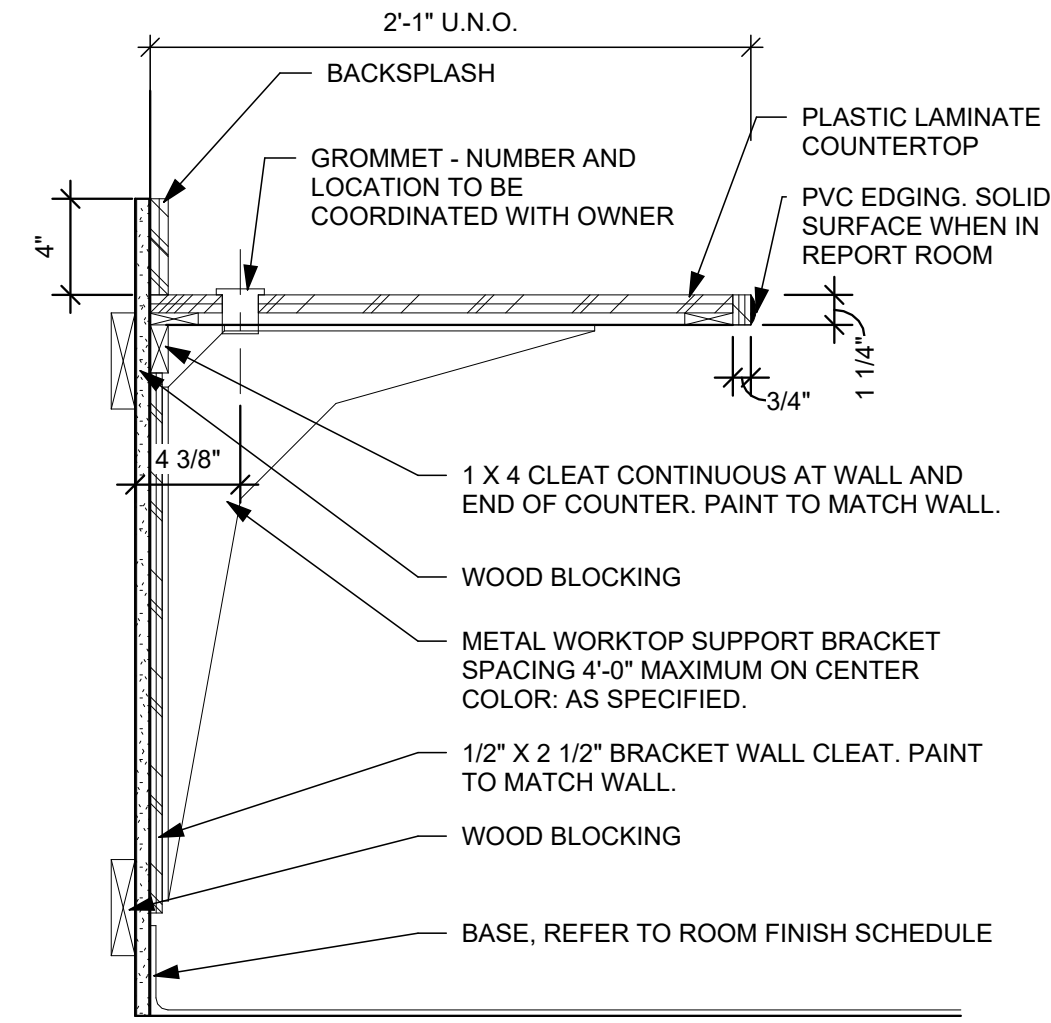
**B1** "ADA" SINK (SADA) DETAIL  
1 1/2" = 1'-0"




**B2** TYP. SINK BASE CABINET (SB) DETAIL  
1 1/2" = 1'-0"




**B4** TYP. BASE CABINET (B) DETAIL  
1 1/2" = 1'-0"

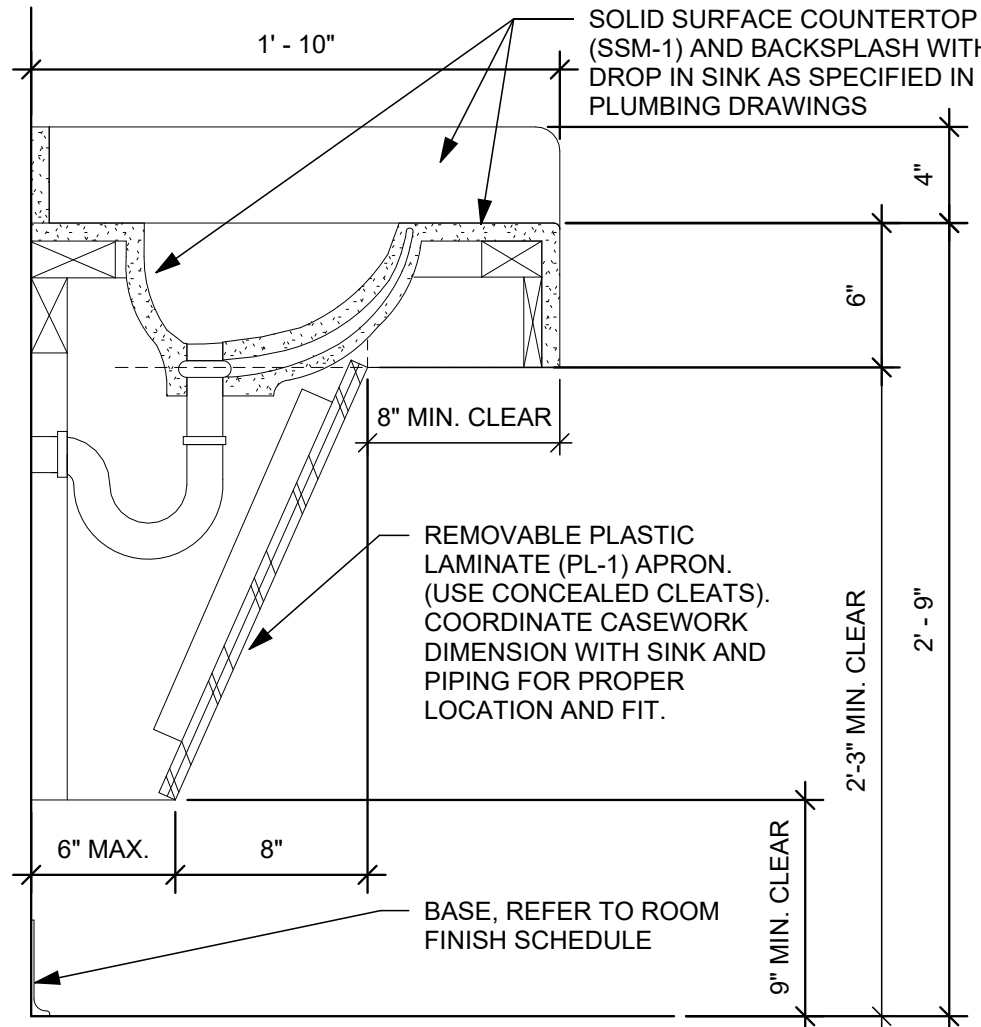


**B6** TYP. WORK SURFACE DETAIL  
1 1/2" = 1'-0"

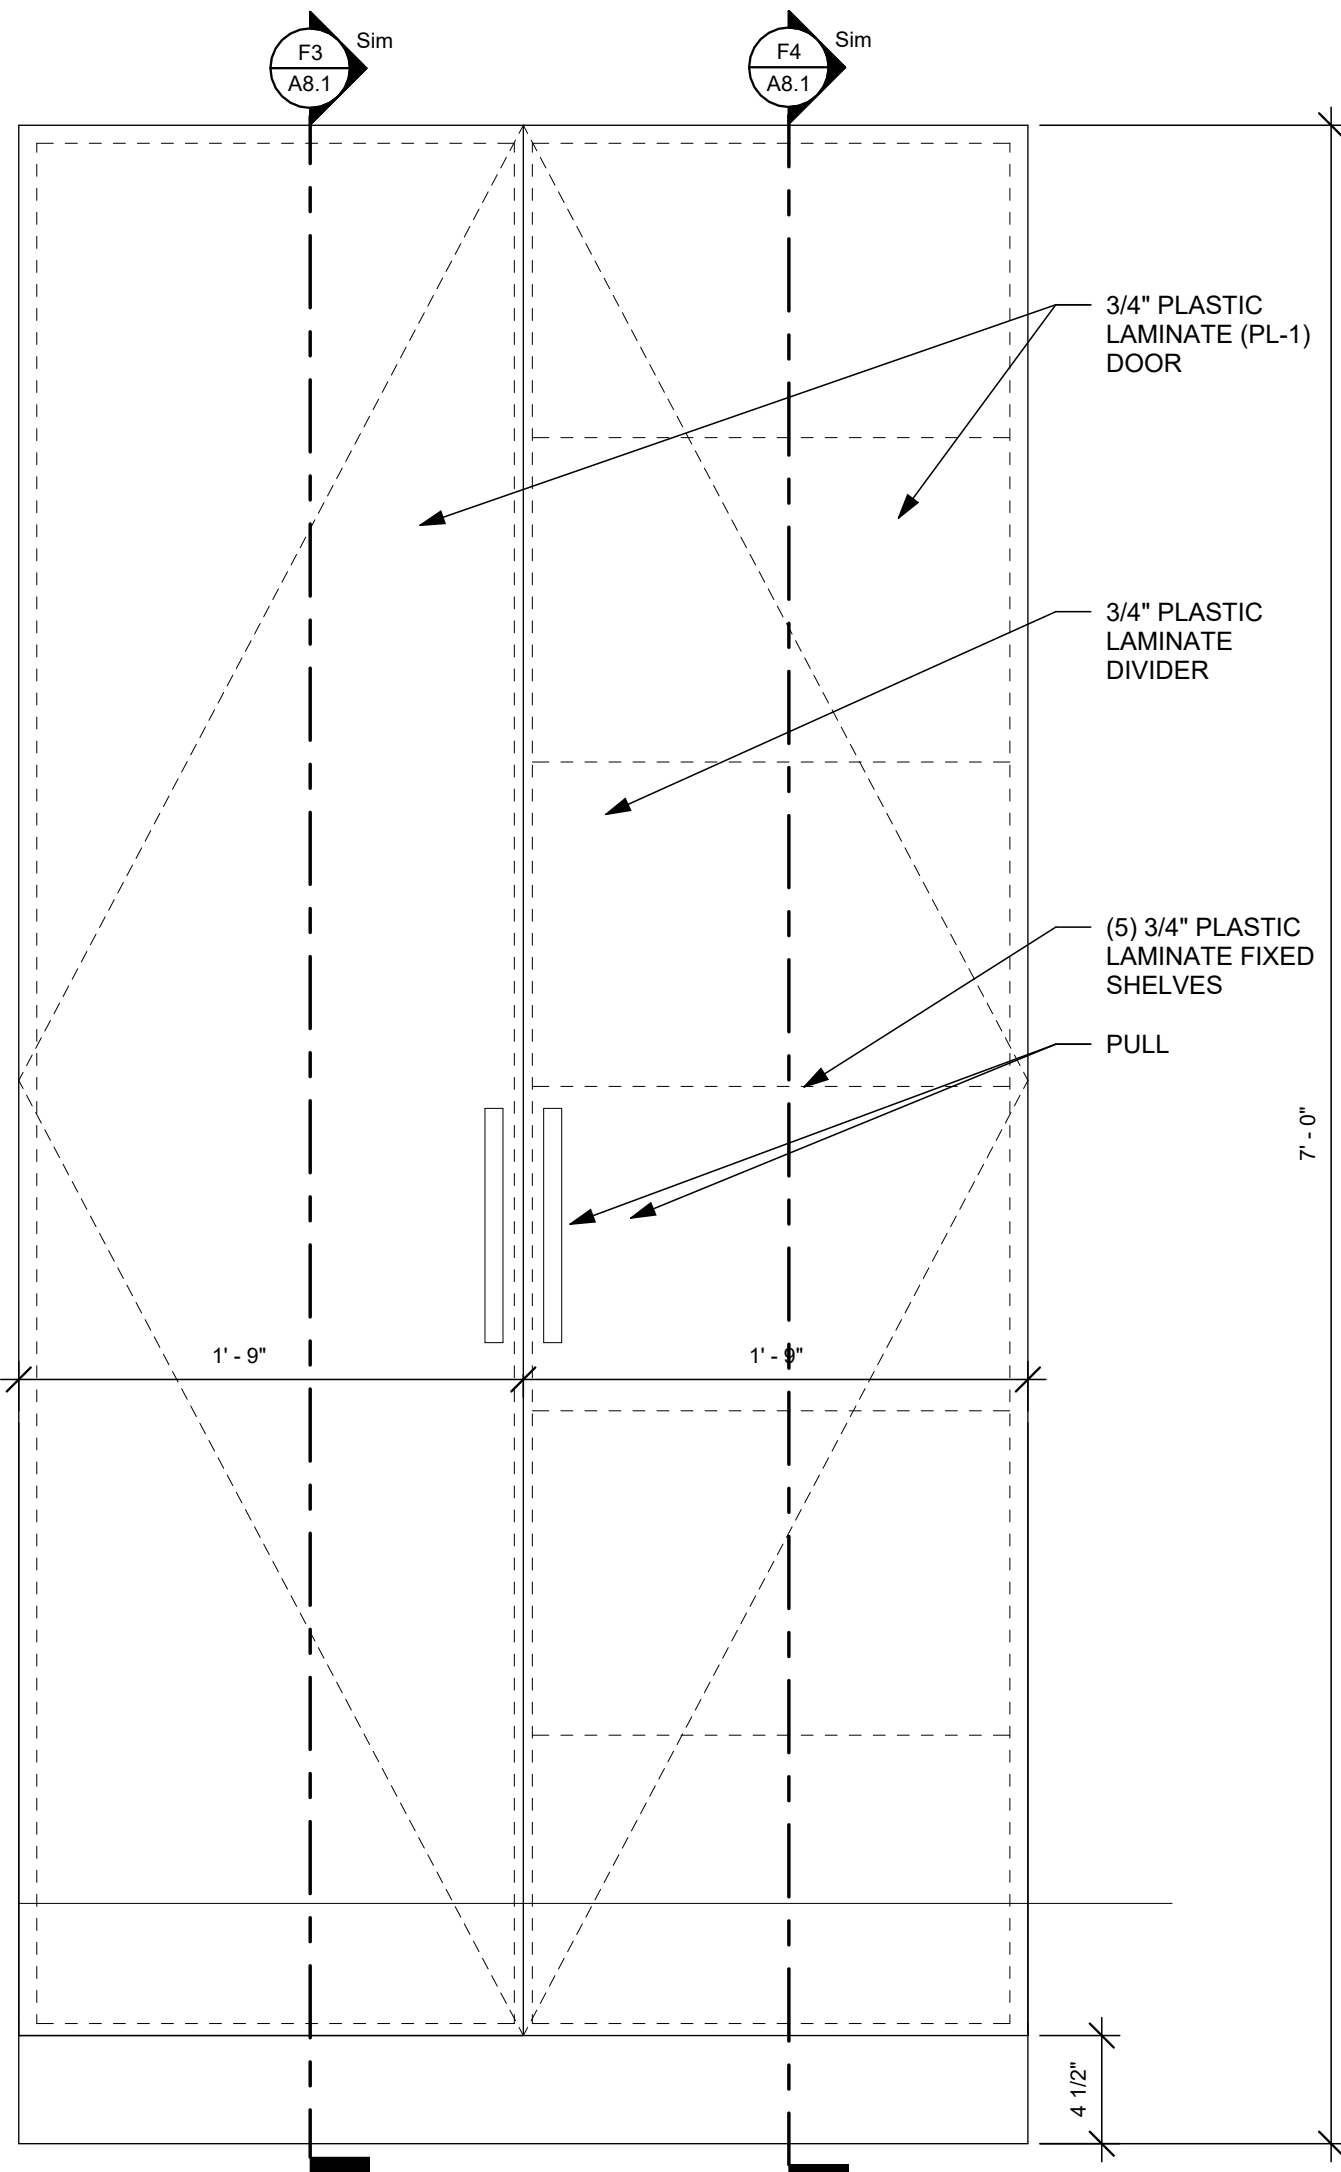


**F1** STORM CABINET (SC) ELEVATION  
1 1/2" = 1'-0"

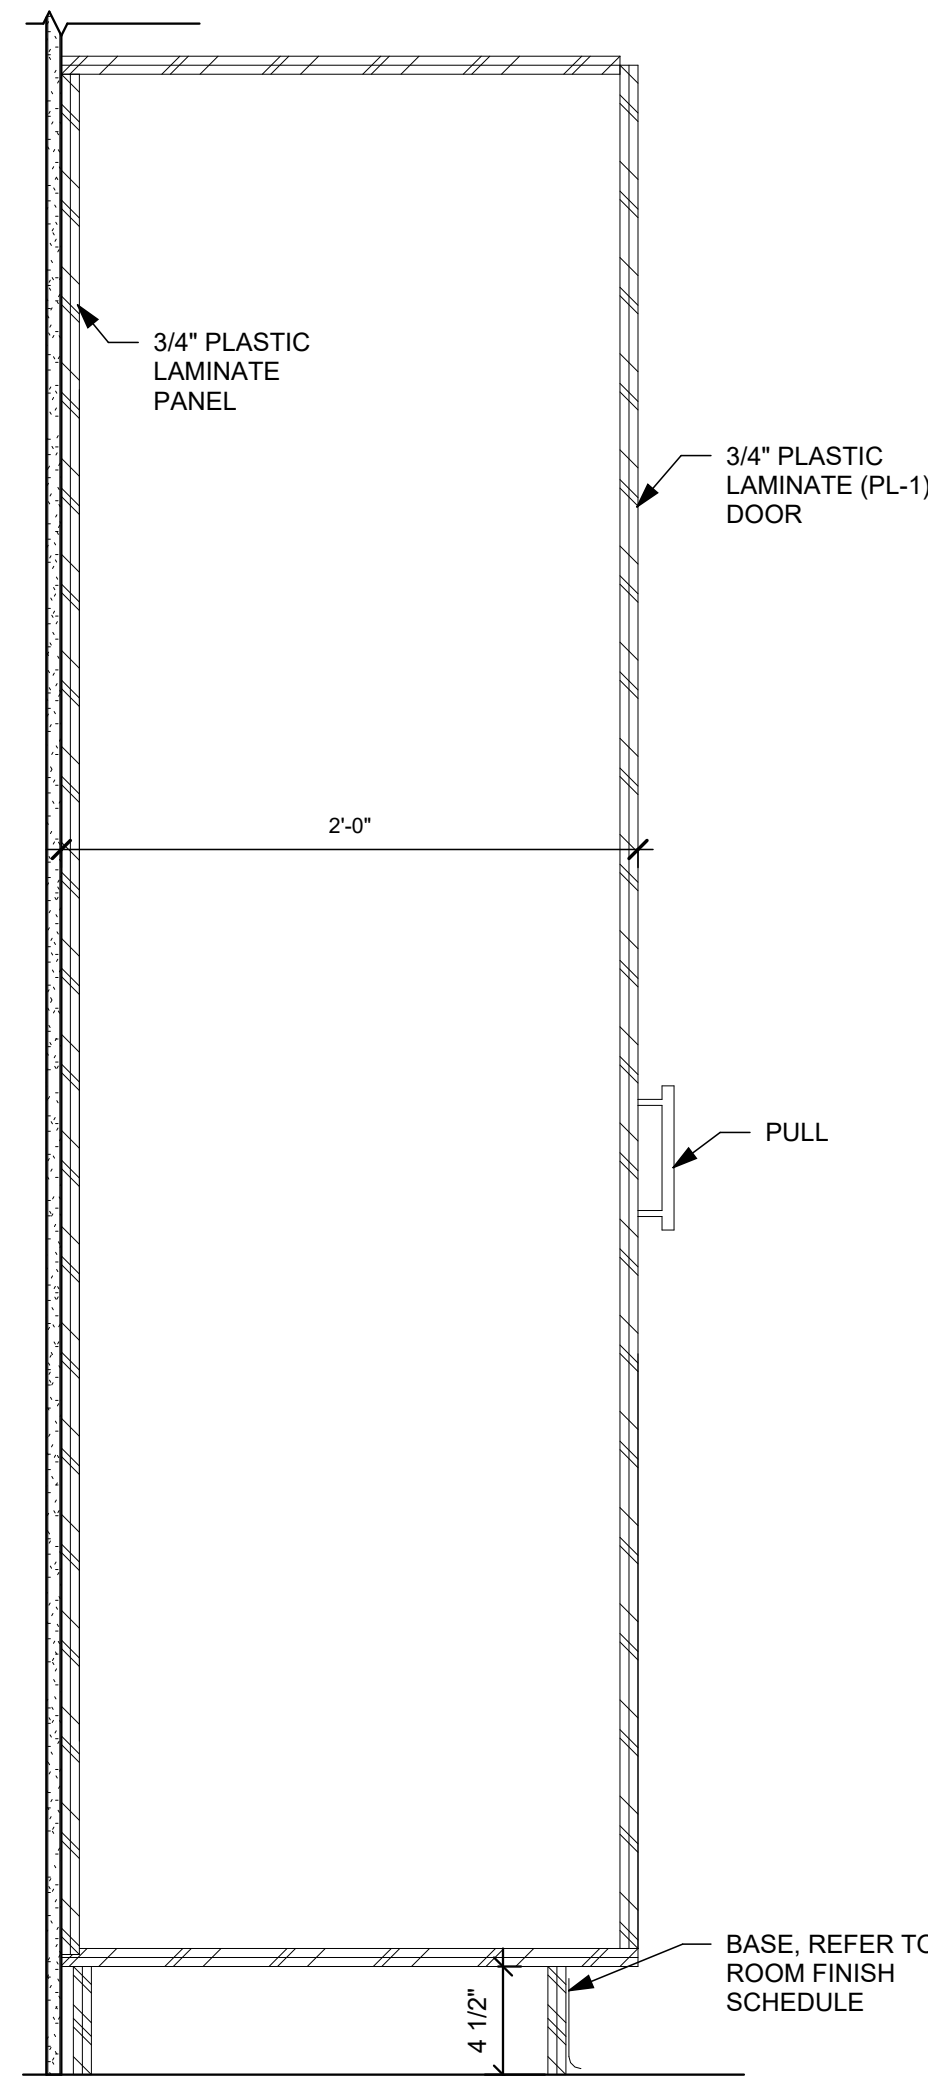

**F3** STORM CABINET (SC) - OPEN  
1 1/2" = 1'-0"

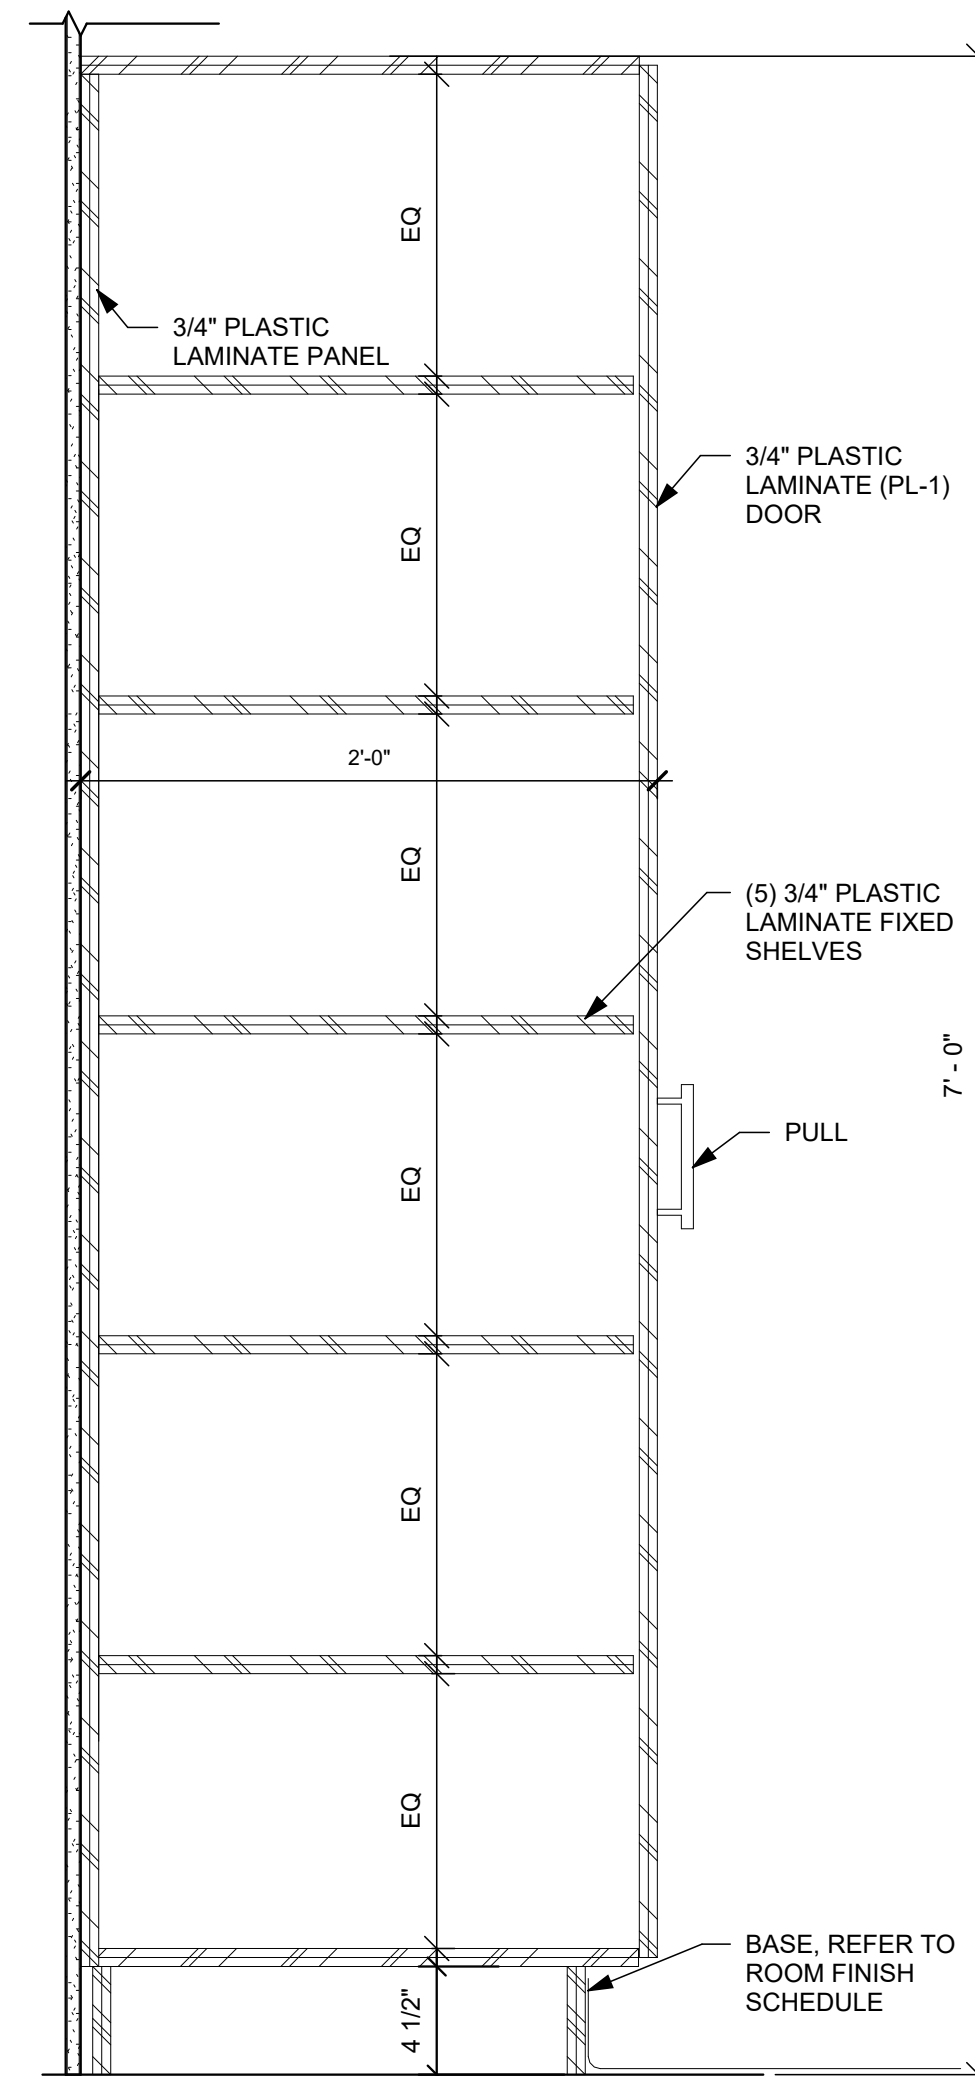

**F4** STORM CABINET (SC) - SHELVES  
1 1/2" = 1'-0"

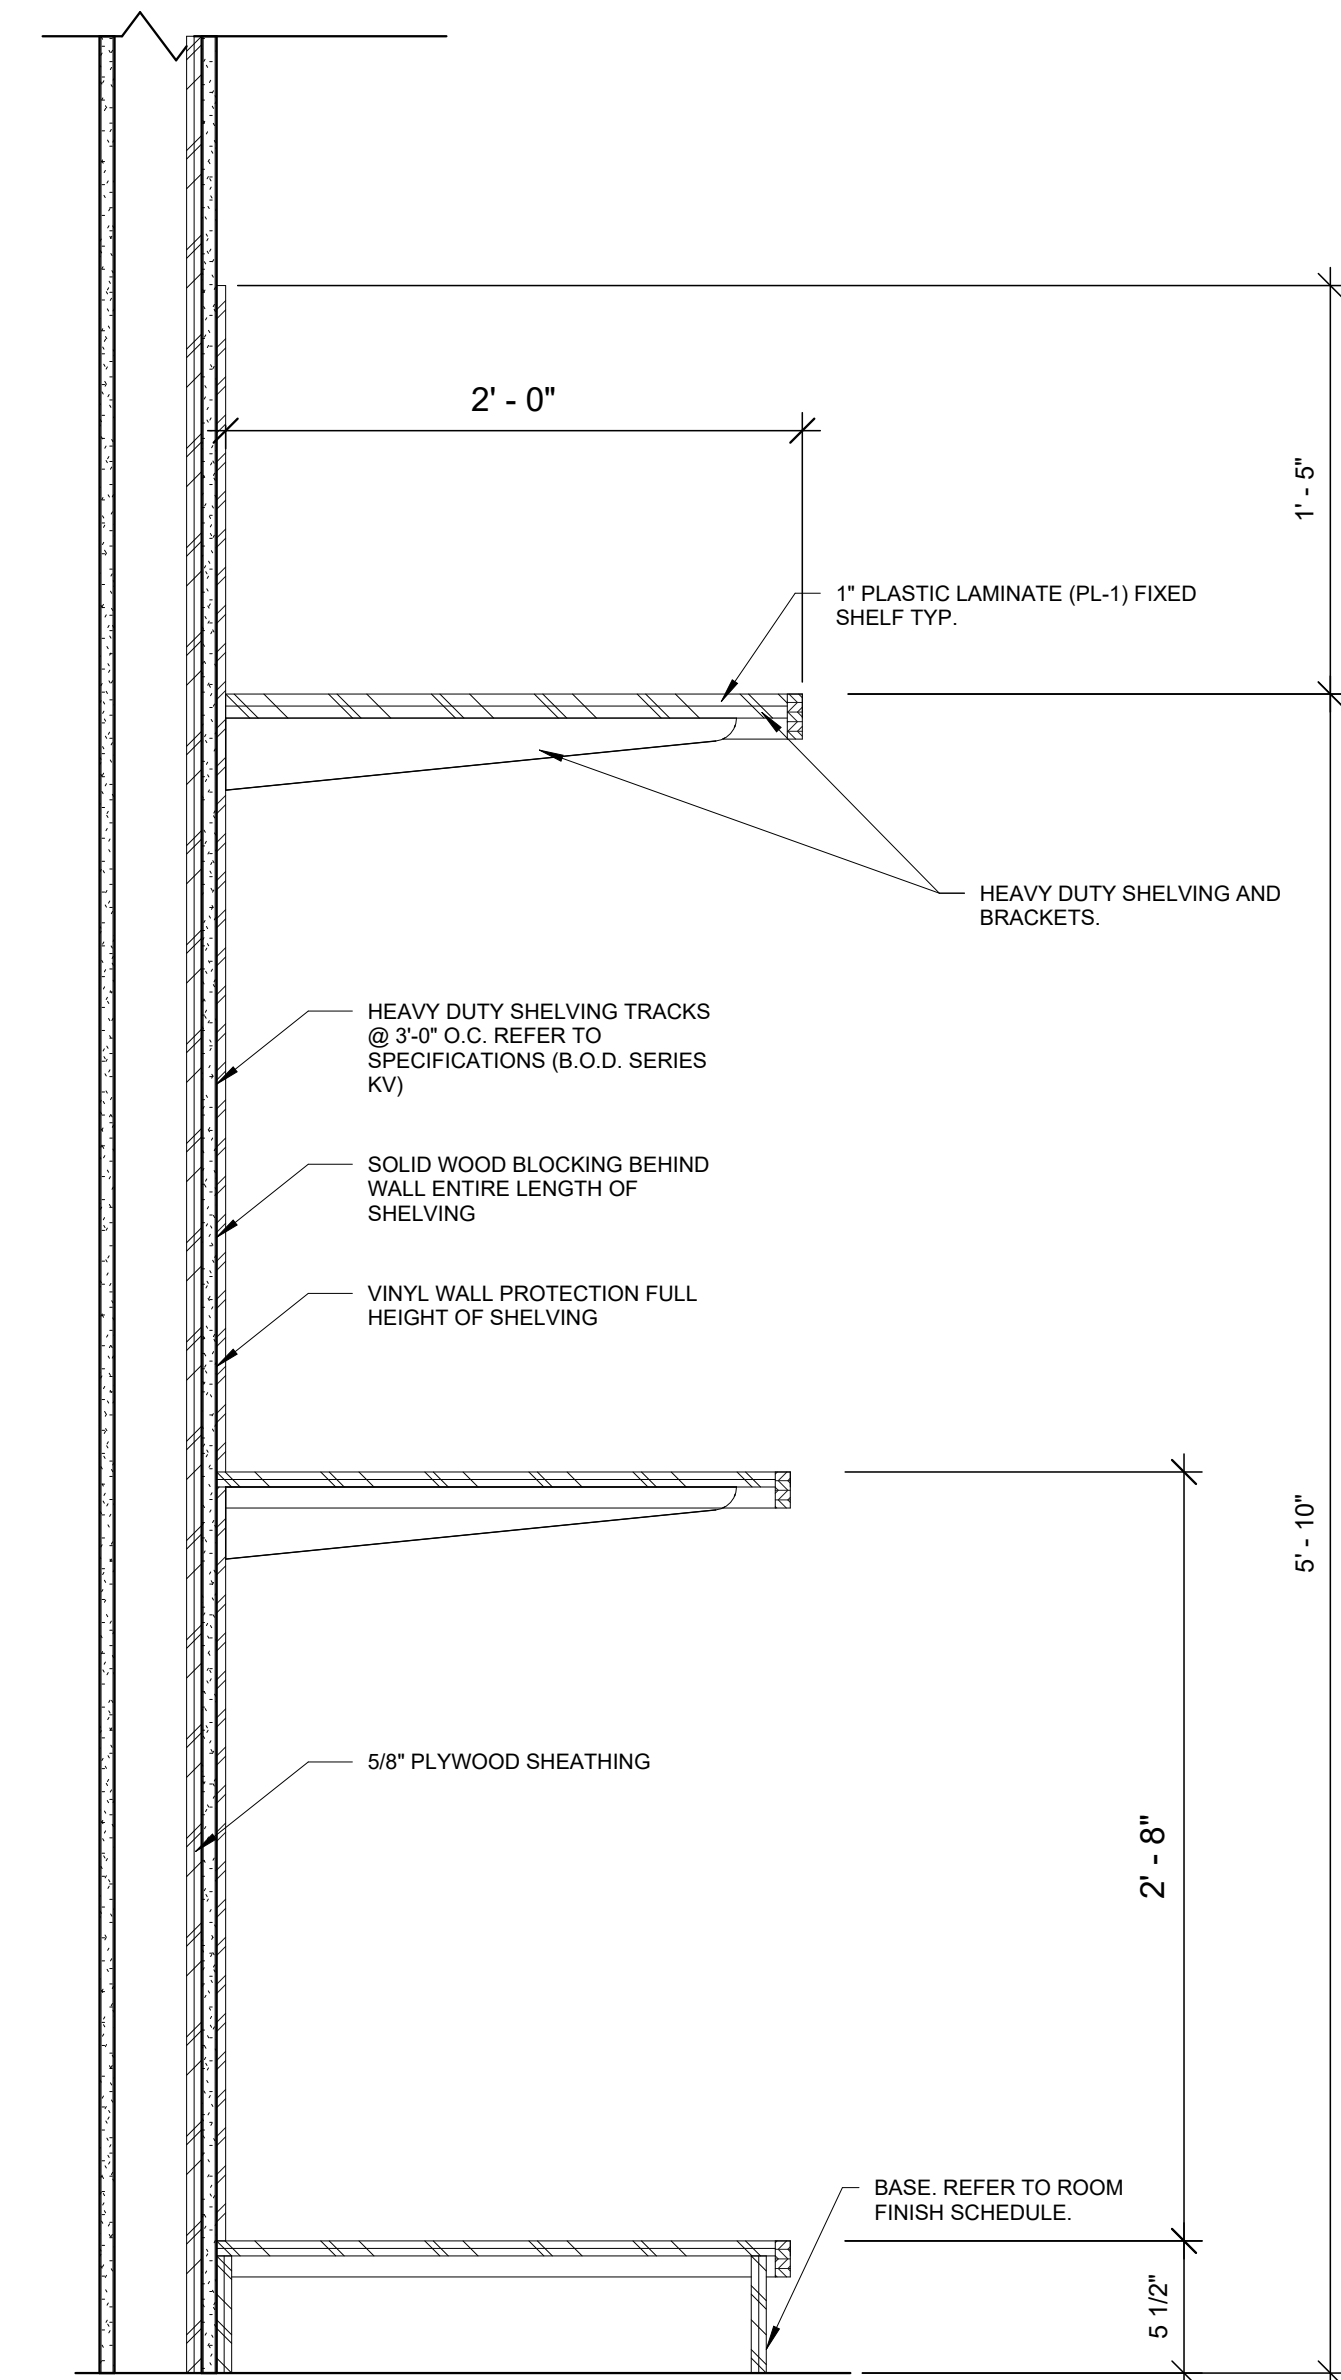

**F6** HEAVY DUTY TACTICAL GEAR SHELF  
1 1/2" = 1'-0"

A

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**Harrison Township District 10  
Sheriff Substation Renovation**

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TITLE CASEWORK DETAILS	

SHEET NO.  
**A8.1**



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A


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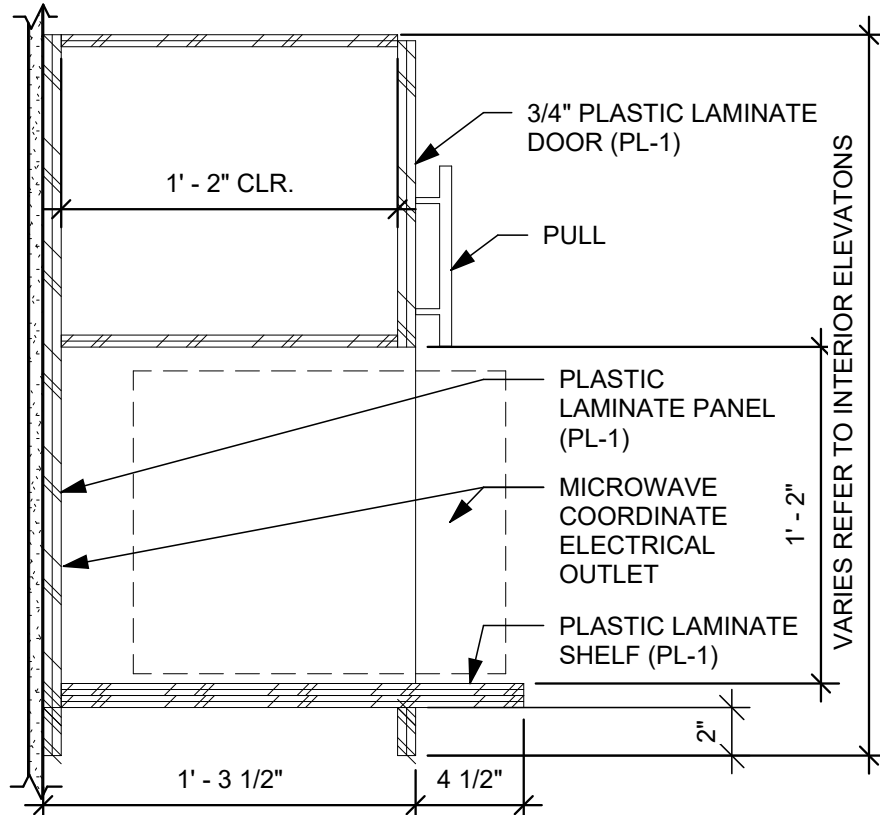
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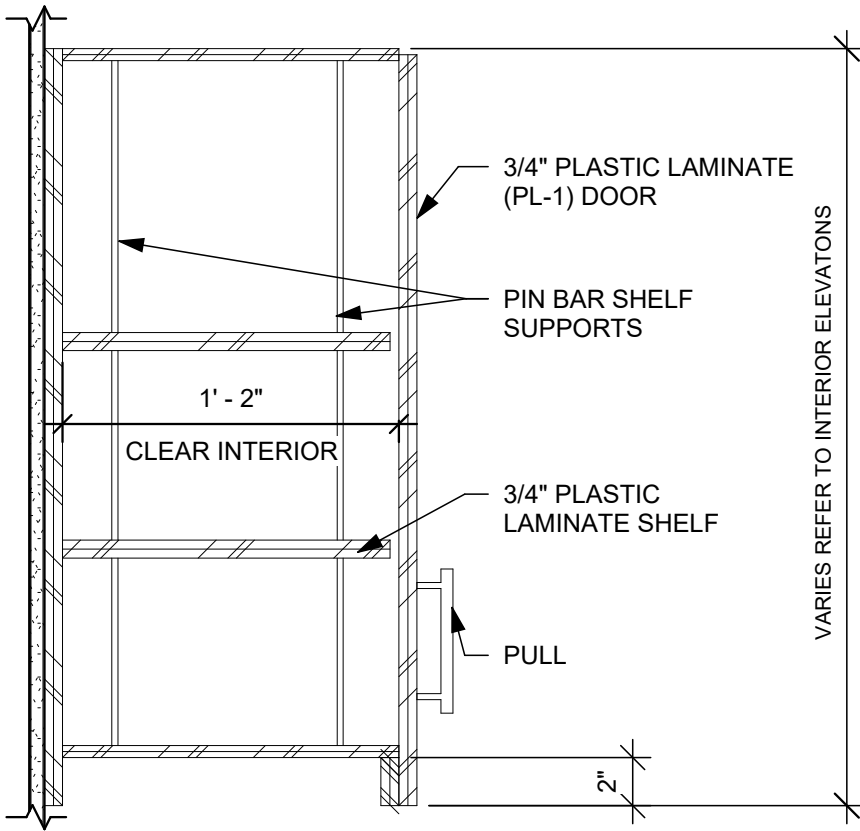
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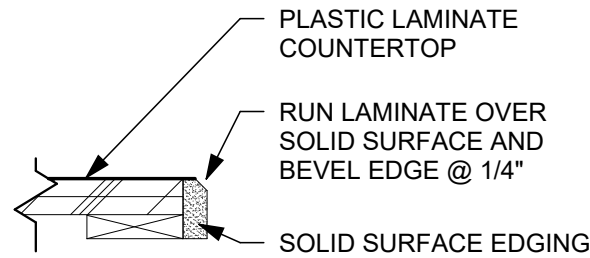
**B1** ADJUSTABLE SHELVING (ADJS)  
1 1/2" = 1'-0"




**B2** MICROWAVE WALL (MW) CABINET  
1 1/2" = 1'-0"



**B4** WALL CABINET (W) DETAIL  
1 1/2" = 1'-0"

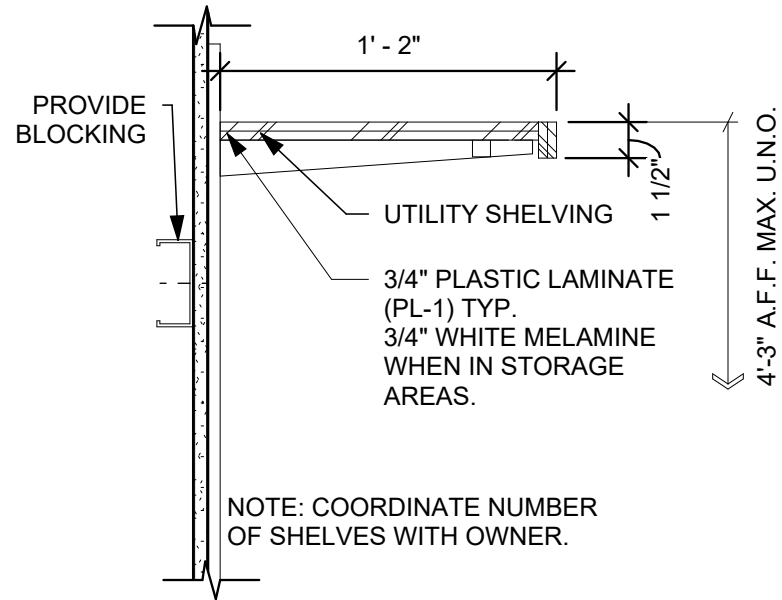

**B5** SOLID SURFACE COUNTER EDGE  
3" = 1'-0"

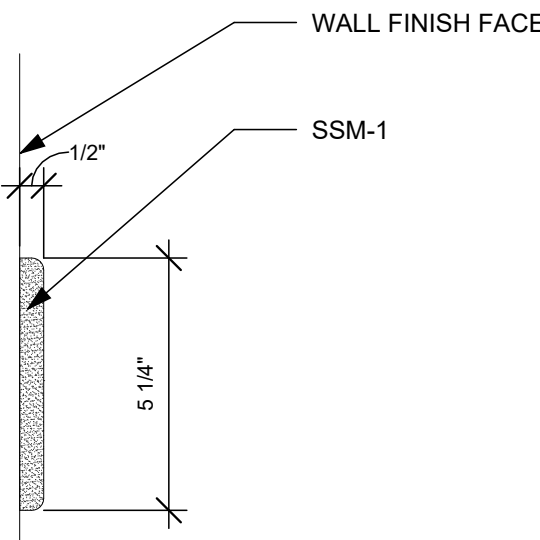

**C1** CHAIR RAIL PROFILE DETAIL  
3" = 1'-0"

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Sheriff Substation Renovation**

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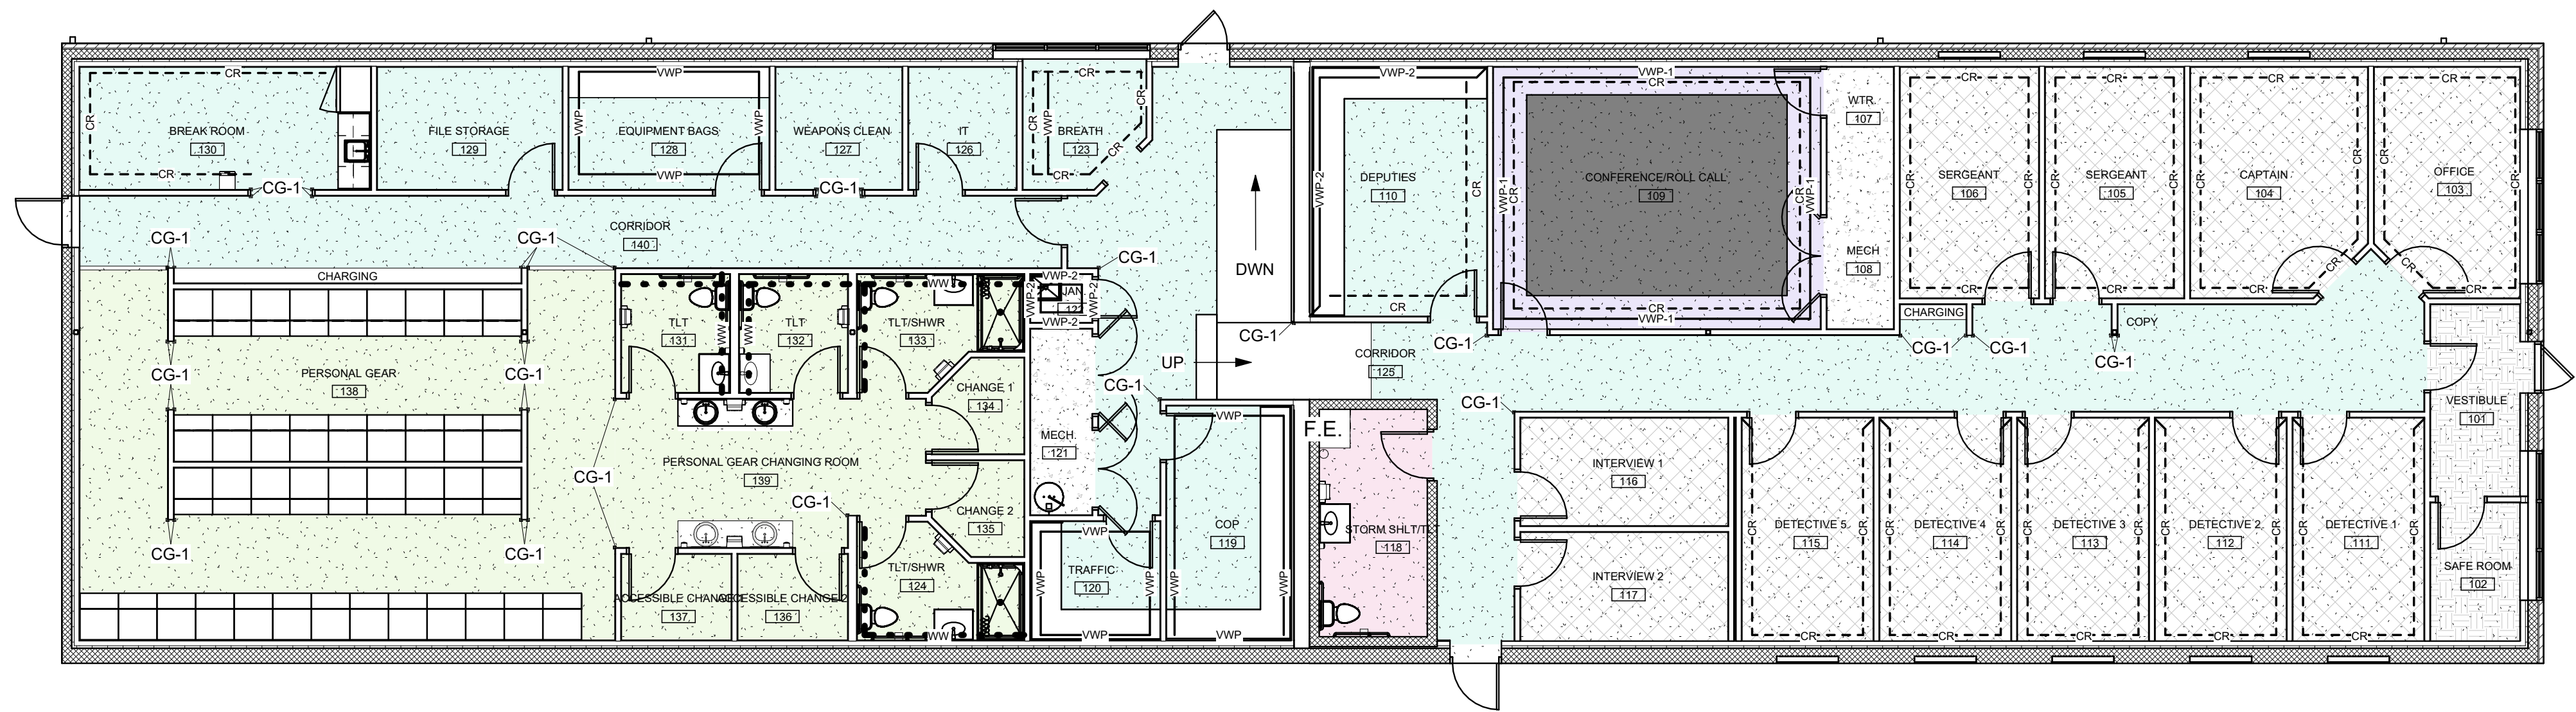
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TITLE  
**CASEWORK DETAILS**

SHEET NO.

**A8.2**





**E1 FINISH FLOOR PLAN**  
1/8" = 1'-0"

## FINISH LEGEND

- C-1 - CARPET
- MAT-1 - WALK-OFF MAT
- MCT-1 - MARMOLEUM COMPOSITION TILE
- MCT-1/2 - MARMOLEUM COMPOSITION TILE
- PC-1 - POLISHED CONCRETE
- PT-1 - PORCELAIN TILE
- SC-1 - SEALED CONCRETE
- VWP - VINYL WALL PROTECTION
- VWC - VINYL WALL COVERING
- CR - CHAIR RAIL
- WW - WALL TILE PWT-1 (WET WALLS)
- CG-1 - CORNER GUARD
- EWP-1 - END WALL PROTECTION
- SG-1 - STEEL IMPACT GUARD

BASIS OF DESIGN: OMEGA CORNER SHIELD HEAVY DUTY CORNER GUARDS. REFER TO E1/A0.4.

## GENERAL NOTES

- A. REPAIR, LEVEL, AND PREPARE EXISTING CONCRETE FLOOR SLABS TO RECEIVE NEW FLOOR FINISH. REFER TO ARCHITECTURAL ROOM FINISH SCHEDULE AND SPECIFICATIONS FOR ADDITIONAL INFORMATION.

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TITLE FINISH FLOOR PLAN	
SHEET NO. <b>A9.1</b>	



A. GENERAL:

- THE STRUCTURAL ENGINEER OF RECORD IS RESPONSIBLE FOR THE ADEQUACY OF THE STRUCTURAL DESIGN AS SHOWN IN THE CONTRACT DOCUMENTS WHICH DEPICT THE STRUCTURE IN ITS COMPLETED FORM. THE STRUCTURE IS DESIGNED TO BE CAPABLE OF WITHSTANDING CODE PRESCRIBED DESIGN FORCES AND FULLY STABLE WHEN THE STRUCTURE IS FULLY CONSTRUCTED (I.E., FULLY BUILT). IT IS SOLELY THE RESPONSIBILITY OF OTHERS TO DETERMINE ERECTION PROCEDURE AND SEQUENCE AS WELL AS TO PROVIDE FOR THE SAFETY OF THE STRUCTURE AND ITS COMPONENTS PARTS DURING ERECTION. THIS INCLUDES THE ADDITION OF WHATEVER SHORING, SHEETING, TEMPORARY BRACING, GUYS, TIE DOWNS, OR DE-WATERING WHICH MIGHT BE NECESSARY. SUCH MATERIAL SHALL REMAIN THE CONTRACTOR'S PROPERTY AFTER THE COMPLETION OF THE PROJECT.
- IT IS SOLELY THE CONTRACTOR'S RESPONSIBILITY TO FOLLOW ALL APPLICABLE SAFETY CODES AND REGULATIONS DURING ALL PHASES OF CONSTRUCTION.
- ALL ELEVATIONS GIVEN ON THE STRUCTURAL DRAWINGS ARE BASED ON THE GROUND FLOOR DATUM OF 100'-0" (U.N.O.).
- THE STRUCTURAL ENGINEER OF RECORD IS RESPONSIBLE FOR THE ADEQUACY OF THE STRUCTURAL DESIGN AS SHOWN IN THE CONTRACT DOCUMENTS WHICH DEPICT THE STRUCTURE IN ITS COMPLETED FORM. THE STRUCTURE IS DESIGNED TO BE CAPABLE OF WITHSTANDING CODE PRESCRIBED DESIGN FORCES AND FULLY STABLE WHEN THE STRUCTURE IS FULLY CONSTRUCTED (I.E., FULLY BUILT). IT IS SOLELY THE RESPONSIBILITY OF OTHERS TO DETERMINE ERECTION PROCEDURE AND SEQUENCE AS WELL AS TO PROVIDE FOR THE SAFETY OF THE STRUCTURE AND ITS COMPONENTS PARTS DURING ERECTION. THIS INCLUDES THE ADDITION OF WHATEVER SHORING, SHEETING, TEMPORARY BRACING, GUYS, TIE DOWNS, OR DE-WATERING WHICH MIGHT BE NECESSARY. SUCH MATERIAL SHALL REMAIN THE CONTRACTOR'S PROPERTY AFTER THE COMPLETION OF THE PROJECT.
- STRUCTURAL DRAWINGS ARE INTENDED TO BE USED WITH THE OTHER DRAWINGS RELEASED FOR THE PROJECT. CONTRACTOR TO COORDINATE, TO THE EXTENT POSSIBLE, SUCH INTERRELATIONSHIPS IN PROJECT SHOP DRAWINGS AND FIELD WORK.
- DO NOT SCALE THESE DRAWINGS, USE DIMENSIONAL DATA PROVIDED.
- REFER TO ARCHITECTURAL DRAWINGS AND SPECIFICATIONS FOR FIRE RATING REQUIREMENTS, FIRE-PROOFING METHODS, AND FIRE-PROOFING MATERIALS FOR STRUCTUREAL MEMBERS.

B. DELEGATED DESIGN / DEFERRED SUBMITTALS:

- DELEGATED DESIGN AND DEFERRED SUBMITTALS ARE ITEMS DESIGNED BY OTHERS. SHOP DRAWINGS AND CALCULATIONS SHALL BE GENERATED FOR THE DESIGN AND FABRICATION OF ALL DELEGATED DESIGN AND DEFERRED SUBMITTALS ITEMS INDICATED BELOW. THESE DRAWINGS AND CALCULATIONS SHALL BE SEALED AND SIGNED BY A PROFESSIONAL ENGINEER IN THE STATE WHERE THE PROJECT IS TO BE CONSTRUCTED. FOR ITEMS INDICATED AS "DESIGNED BY THE CONTRACTOR", "DESIGNED BY SUPPLIER", "DESIGNED BY FABRICATOR" AND "DESIGNED BY INSTALLER", IF THESE ENTITIES ARE NOT PROVIDING THEIR OWN ENGINEERING WITH THEIR DESIGNS COMPLETED BY A PROFESSIONAL ENGINEER WHO WILL SEAL AND SIGN THEIR SUBMITTALS THEN THESE ENTITIES WILL INDEPENDENTLY CONTRACT A THIRD PARTY TO PROVIDE THIS SERVICE ON THEIR BEHALF. UNLESS SPECIFIED ON THE DRAWINGS OR IN THE SPECIFICATIONS, DELEGATED DESIGN ITEMS SHALL BE DESIGNED FOR ALL CODE DEFINED LOADS PLUS INDUSTRY STANDARD LOADS INCLUDING GRAVITY LOADS AND LATERAL LOADS DUE TO WIND AND SEISMIC. SEE THE RELEVANT SECTIONS OF THE GENERAL NOTES SHEETS FOR ADDITIONAL DESIGN REQUIREMENTS. CALCULATIONS SHALL INCLUDE REVIEW OF THE CAPACITIES OF ALL SUPPORTING STRUCTURAL ELEMENTS INCLUDING LOCAL STRESSES DUE TO THE CONNECTION METHODS SELECTED. ADDITIONALLY, THE CALCULATIONS AND DRAWINGS SHALL CLEARLY INDICATE THE MAGNITUDES AND DIRECTIONS OF THE LOADS IMPARTED ON THE SUPPORTING STRUCTURAL ELEMENTS. THE LOADING CRITERIA USED FOR DESIGN OF THE DELEGATED DESIGN SYSTEMS AND COMPONENTS SHALL BE CLEARLY INDICATED ON THE DRAWINGS AND CALCULATIONS, REGARDLESS OF WHETHER THEY ARE MANDATED BY THE ENGINEER OF RECORD BY WAY OF THE DRAWING AND SPECIFICATIONS OR DERIVED BY THE DESIGNER.
- TEMPORARY SHORING: FOUNDATIONS - SHEET PILING, PILES AND LAGGING REQUIRED FOR INSTALLATION OF FOUNDATIONS AND FOUNDATION WALLS SHALL BE DESIGNED BY THE CONTRACTOR. EXCAVATIONS REQUIRED FOR FOUNDATION AND FOUNDATION WALL CONSTRUCTION NEXT TO EXISTING BUILDINGS, NEAR PROPERTY LINES AND NEAR OR OVER UTILITIES MUST BE CONSIDERED BY THE CONTRACTOR IN EVALUATING SHORING REQUIREMENTS.
- MECHANICAL, ELECTRICAL, PLUMBING AND FIRE PROTECTION COMPONENTS: ROOF-TOP UNITS - DESIGN OF THE MECHANICAL UNIT CURB, CONNECTIONS OF THE UNIT TO THE CURB AND CONNECTIONS OF THE CURB TO STRUCTURE SHALL BE PROVIDED BY THE MECHANICAL UNIT CONTRACTOR. ADDITIONAL SUPPORT FRAMING FOR SUPPORTING THE GRAVITY AND LATERAL LOADS SHALL BE DESIGNED, ENGINEERED AND PROVIDED IF IT IS NOT INDICATED ON THE STRUCTURAL DRAWINGS. IF ADDITIONAL SUPPORT FRAMING IS PROVIDED, THE STRUCTURAL ADEQUACY SHALL BE VERIFIED FOR ALL ASCE 7-16 LOAD COMBINATIONS. SHOP DRAWINGS AND CALCULATIONS PROVIDED BY THE MECHANICAL CONTRACTOR SHALL PROVIDE DETAILS INDICATING THESE CONNECTIONS, SUPPORT AND BRACING OF DUCTWORK, PIPING, CONDUIT AND CABLE TRAYS ASSOCIATED WITH MECHANICAL, ELECTRICAL, PLUMBING AND FIRE PROTECTION COMPONENTS SHALL BE PROVIDED BY THE CONTRACTOR INSTALLING THE COMPONENTS. FOR PROJECTS IN SEISMIC DESIGN CATEGORY C, D AND HIGHER, SEISMIC BRACING OF ALL MECHANICAL AND ELECTRICAL COMPONENTS REQUIRED BY THE ASCE 7-16 SHALL BE DESIGNED BY THE MECHANICAL CONTRACTOR AND CLEARLY INDICATED AND DETAILED ON THE SHOP DRAWINGS.
- SUPPORTS FOR INTERIOR FINISHES AND ACCOUTREMENTS: INTERIOR PARTITIONS, SOFFITS AND STOREFRONT SYSTEMS NOT PART OF THE MAIN BUILDING SHELL SHALL BE DESIGNED BY THE SUPPLIER. SUPPORTS AND CONNECTION TO STRUCTURE REQUIRED FOR ARTWORK, SPECIALTY LIGHTING SYSTEMS, MONITORS, VIDEO EQUIPMENT AND PROJECTION SCREENS, TELEVISIONS AND ANY OTHER MISCELLANEOUS ITEMS SHALL BE PROVIDED BY THE SUPPLIER.
- WINDOWS, STOREFRONTS, GLAZING AND CURTAIN WALL SYSTEMS: ALL EXTERIOR AND INTERIOR GLAZING SYSTEMS AND THEIR CONNECTIONS TO STRUCTURE SHALL BE DESIGNED BY THE SUPPLIER. CONNECTION LOCATIONS SHALL BE CLEARLY INDICATED AND COORDINATED WITH ARCHITECTURAL AND STRUCTURAL DETAILS.  
  
DUE TO MOVEMENT OF THE STRUCTURAL FRAMING SYSTEMS FROM LATERAL WIND AND SEISMIC FORCES, THE GLAZING SYSTEM MUST BE DESIGNED TO ACCOMMODATE 3/4" HORIZONTAL STORY DRIFT IN EACH DIRECTION AT EACH STORY LEVEL. THE DESIGN STORY DRIFT IS THE DIFFERENCE IN LATERAL DISPLACEMENT OF THE TOP OF THE STORY UNDER CONSIDERATION RELATIVE TO THE BOTTOM OF THAT STORY (TOP OF THE STORY BELOW).  
  
THE CONNECTIONS OF THE GLAZING SYSTEM TO STRUCTURE CAN BE DESIGNED FOR THIS RELATIVE HORIZONTAL MOVEMENT. THE CONNECTIONS SHALL BE DESIGNED FOR 3/4" HORIZONTAL (IN-PLANE) MOVEMENT IN ADDITION TO THE VERTICAL DEFLECTION REQUIREMENTS AS NOTED IN THE PLANS, DETAILS AND SPECIFICATIONS. IF THE CONNECTIONS ARE NOT DESIGNED FOR THE LATERAL MOVEMENT, THE GLAZING SYSTEM SHALL BE DESIGNED TO ACCOMMODATE 3/8" HORIZONTAL STORY DRIFT IN EACH DIRECTION AT EACH STORY LEVEL TO ACCOUNT FOR DIFFERENTIAL DISPLACEMENTS FROM LOAD REVERSALS IN THE STRUCTURAL SYSTEMS.
- RAILING AND GUARDRAILS: THE INTERIOR AND EXTERIOR RAILING AND GUARDRAILS SHALL BE DESIGN BY THE FABRICATOR. UNLESS SPECIFICALLY DETAILED ON THE ARCHITECTURAL OR STRUCTURAL DRAWINGS, THE FABRICATOR SHALL DESIGN THE CONNECTIONS TO STRUCTURE AND VERIFY THE CAPACITY OF THE RECEIVING STRUCTURAL ELEMENTS FOR LOADS DUE TO THEIR CONNECTIONS. RAILING SHOP DRAWINGS SHALL BE SUBMITTED TO THE BUILDING OFFICIAL HAVING JURISDICTION, FOR REVIEW AND APPROVAL PRIOR TO THIS WORK COMMENCING.
- CANOPY AND MISCELLANEOUS EXTERIOR FRAMING: ALL CANOPIES, NOT OTHERWISE DETAILED, SHALL BE DESIGNED BY THE SUPPLIER. SUPPORTS AND CONNECTIONS TO STRUCTURE REQUIRED FOR CANOPIES AND OTHER MISCELLANEOUS EXTERIOR FRAMING ITEMS SHALL BE PROVIDED BY THE SUPPLIER. ASSOCIATED SHOP DRAWINGS SHALL BE SUBMITTED TO THE BUILDING OFFICIAL HAVING JURISDICTION, FOR REVIEW AND APPROVAL PRIOR TO THIS WORK COMMENCING. THIS IS TO BE A DEFERRED SUBMITTAL UNDER THIS PERMIT.

C. SOIL/STRUCTURE INTERACTION & SOIL PREPARATION INFORMATION:

- DO NOT BACKFILL WALLS UNTIL CONCRETE HAS ATTAINED FOURTEEN (14) DAY STRENGTH OR LATERAL BRACING IS PROVIDED.
- FOUNDATIONS HAVE BEEN DESIGNED ASSUMING AN ALLOWABLE SOIL BEARING PRESSURE OF 1,500 POUNDS PER SQUARE FOOT (PSF) FOR SPREAD FOOTINGS FOR BUILDING COLUMNS AND CONTINUOUS FOOTINGS FOR BEARING WALLS. SOIL CONDITIONS SHALL BE INSPECTED BY A GEOTECHNICAL ENGINEER OR AN APPOINTED REPRESENTATIVE OF THE GEOTECHNICAL ENGINEER PRIOR TO CONCRETE PLACEMENT. THE GEOTECHNICAL ENGINEER (OR REPRESENTATIVE) SHALL BE THE SOLE JUDGE AS TO THE SUITABILITY OF THE BEARING MATERIAL.

D. DESIGN LOADS:

1. CODE REFERENCES:

- OHIO BUILDING CODE (OBC) - 2024
- ICC 500-2020, STANDARD FOR THE DESIGN AND CONSTRUCTION OF STORM SHELTERS
- ASCE 7-22, MINIMUM DESIGN LOADS FOR BUILDINGS AND OTHER STRUCTURES
- BUILDING CODE REQUIREMENTS FOR STRUCTURAL CONCRETE AND COMMENTARY, ACI 318 - 2019
- BUILDING CODE REQUIREMENTS FOR MASONRY STRUCTURES AND SPECIFICATIONS FOR MASONRY STRUCTURES AND COMMENTARIES, ACI 530 - 2016
- COLD-FORMED STEEL DESIGN MANUAL, AISI - 2017
- SPECIFICATIONS FOR THE DESIGN OF COLD-FORMED STEEL STRUCTURAL MEMBERS, AISI - 2017
- CATALOG OF STANDARD SPECIFICATIONS AND LOAD TABLES FOR STEEL JOISTS AND JOIST GIRDERS, STEEL JOIST INSTITUTE - 2017
- STEEL DECK INSTITUTE FLOOR DECK DESIGN MANUAL, 1st EDITION - MARCH 2014
- STEEL DECK INSTITUTE ROOF DECK DESIGN MANUAL, 1st EDITION - MAY 2013
- STEEL DECK INSTITUTE DIAPHRAGM DESIGN MANUAL, 4th EDITION - SEPTEMBER 2015
- STEEL DECK INSTITUTE MANUAL OF CONSTRUCTION WITH STEEL DECK - OCTOBER 2016
- STEEL DECK INSTITUTE STANDARD PRACTICE DETAILS - MAY 2001
- MANUAL OF STEEL CONSTRUCTION - AISC, 15th EDITION - 2017
- SPECIFICATION FOR STRUCTURAL JOINTS USING ASTM A325 OF A490 BOLTS - 01 AUGUST 2014
- STRUCTURAL WELDING CODE - STEEL, ANSI/AWS D1.1 - 2015
- FEMA 405 - NEHRP RECOMMENDED PROVISIONS FOR SEISMIC REGULATIONS FOR NEW BLDGS AND OTHER STRUCTURES - 2015

DEAD LOADS:

ROOF DEAD LOAD 20 PSF

LIVE LOADS:

FLOOR LIVE LOADS:

OCCUPANCY TYPES: DISTRIBUTED LOADS CONCENTRATED LOAD (ON 2.5 SF AREA)

STORM SHELTER FLOOR LIVE LOAD	100 PSF	
CORRIDORS AND PUBLIC AREAS	100 PSF	1,000 POUNDS
STAIRS/LANDINGS/EXTWAYS	100 PSF	300 POUNDS (ON 4.5 SQ IN OF AREA)

ROOF LIVE LOAD:

STORM SHELTER ROOF LIVE LOAD 100 PSF (Lrt)  
MINIMUM DESIGN ROOF LIVE LOAD 20 PSF

SNOW LOAD PARAMETERS:

- GROUND SNOW LOAD, Pg 20 PSF
- FLAT-ROOF SNOW LOAD, Pf 16.8 PSF
- THERMAL FACTOR, Ct 1.0
- EXPOSURE FACTOR, Ce 1.0
- ROOF SLOPE FACTOR, Cs 1.0
- SNOW LOAD IMPORTANCE FACTOR, I 1.2

WIND DESIGN PARAMETERS:

- STORM SHELTER DESIGN WIND SPEED = 250 MPH (Vt)
- ULTIMATE DESIGN WIND SPEED = 115 MPH
- WIND LOAD IMPORTANCE FACTOR = 1.25
- WIND EXPOSURE = EXPOSURE C
- MAIN WIND DESIGN VELOCITY PRESSURES:

HEIGHT (FT.)	WINDWARD WALL	LEEWARD WALL	SIDEWALLS
0 - 15	22.0 PSF	-17.8 PSF / -10.3 PSF	-22.8 PSF
15 - 20	22.9 PSF	-17.8 PSF / -10.3 PSF	-22.8 PSF
20 - 25	23.7 PSF	-17.8 PSF / -10.3 PSF	-22.8 PSF
25 - 30	24.5 PSF	-17.8 PSF / -10.3 PSF	-22.8 PSF
30 - 35	25.3 PSF	-17.8 PSF / -10.3 PSF	-22.8 PSF

COMPONENT AND CLADDING - WALLS

AREA (SQ. FT.)	INTERIOR ZONE	EDGE ZONE
10	30.8 PSF	37.9 PSF
100	26.6 PSF	29.4 PSF
200	25.4 PSF	27.0 PSF
500	23.7 PSF	23.7 PSF

SEISMIC DESIGN PARAMETERS:

- OCCUPANCY CATEGORY IV
- SITE CLASS D
- IMPORTANCE FACTOR 1.25
- SEISMIC DESIGN CATEGORY: B
- RESPONSE MODIFICATION COEFFICIENT, R 2
- 0.2 SECOND DESIGN SPECTRAL RESPONSE, Sds 15.6%
- 1.0 SECOND DESIGN SPECTRAL RESPONSE, Sd1 11.3%
- DEFLECTION AMPLIFICATION FACTOR, Cd 1-3/4
- ANALYSIS PROCEDURE: EQUIVALENT LATERAL FORCE PROCEDURE
- SEISMIC FORCE-RESISTING SYSTEM: ORDINARY REINFORCED MASONRY SHEAR WALLS
- SEISMIC BASE SHEAR: V = Cs x WEIGHT

LOADS ON HANDRAIL & GUARDRAIL SYSTEMS:

- HANDRAILS AND GUARDRAILS SHALL BE DESIGNED TO WITHSTAND A LOAD OF 200 POUNDS IN ANY DIRECTION, AT ANY POINT ALONG THE TOP RAIL.
- HANDRAILS AND GUARDRAILS SHALL BE DESIGNED TO WITHSTAND A LOAD OF 50 POUNDS-PER- LINEAR-FOOT IN ANY DIRECTION ALONG THE TOP RAIL. THIS DEMAND NEED NOT BE CONSIDERED CONCURRENTLY WITH THE LOAD IN 'a'.
- INTERMEDIATE RAILS AND PANEL FILLERS SHALL BE DESIGNED TO WITHSTAND A HORIZONTALLY APPLIED LOAD OF 50 POUNDS ON AN AREA NOT TO EXCEED 12" x 12". THE REACTIONS FROM THIS LOAD NEED NOT BE CONSIDERED CONCURRENTLY WITH THE LOADS IN 'a' & 'b'.

E. REINFORCED CONCRETE:

1. MATERIALS

a. STRUCTURAL CONCRETE OVERVIEW

LOCATION	Fc (PSI)
FOUNDATIONS AND GRADE BEAMS	3000
TYP. INTERIOR CONCRETE	4000
EXTERIOR CONCRETE EXPOSED TO DE-ICING	4500, 6% AIR
BACKFILL BELOW FOOTINGS, CONCRETE FILL IN STRUCTURES	1500

- ALL DEFORMED REINFORCING BARS: FY = 60,000 P.S.I.

- WELDED WIRE FABRIC: ASTM A185

2. FIELD MANUAL:

PROVIDE AT LEAST ONE COPY OF THE LATEST ACI FIELD REFERENCE MANUAL, SP-15, IN THE FIELD OFFICE AT ALL TIMES.

3. CONTINGENCIES:

PROVIDE LEAN CONCRETE UNDER FOUNDATIONS FOR ACCIDENTAL OVER-EXCAVATION, SOFT SPOTS AND TRENCHES.

4. FOOTINGS, PIERS, WALLS AND SLABS:

- DOWELS IN FOOTINGS TO MATCH VERTICAL PIER OR WALL REINFORCING, U.N.O.
- PROVIDE CORNER BARS AT WALL AND FOOTING CORNERS TO MATCH HORIZONTAL REINFORCING, MINIMUM LENGTH OF EACH LEG - 45 BAR DIAMETERS. (PLACE AS PER DETAILS U.N.O.).
- PROVIDE 10 MIL. POLYETHYLENE VAPOR RETARDER AND 4" COMPACTED AGGREGATE SUBBASE MATERIAL ON TOP IN ACCORDANCE WITH THE TYPICAL SLAB DETAILS. UNDER ALL INTERIOR SLABS ON GRADE, VAPOR RETARDER SHALL BE CARRIED TO AND PLACED IN CONTACT W/IRIGID INSULATION AT INTERIOR FACE OF EXTERIOR FOUNDATION WALLS. SEE SPECIFICATIONS FOR FURTHER INFORMATION.

5. CONSTRUCTION JOINTS:

CONSTRUCTION JOINTS PERMITTED ONLY WHERE SHOWN OR AS APPROVED BY THE STRUCTURAL ENGINEER. ALL CONSTRUCTION JOINTS ARE TO BE KEYS.

6. CHAMFER:

PROVIDE 3/4" CHAMFER AT ALL EXPOSED EDGES OF CONCRETE, U.N.O.

7. MISCELLANEOUS:

- SEE ARCHITECTURAL, MECHANICAL, ELECTRICAL, AND PLUMBING DRAWINGS FOR OPENINGS AND COORDINATE WORK WITH THE CONSTRUCTION MANAGER AND OTHER TRADES. IF OPENING IS NOT SHOWN ON THE STRUCTURAL DRAWINGS, OBTAIN PRIOR APPROVAL.

8. CONCRETE COVER:

U.N.O. DETAIL REINFORCING TO PROVIDE MINIMUM CONCRETE COVER AS FOLLOWS:

CONCRETE CAST AGAINST AND PERMANENTLY EXPOSED TO EARTH:	3 IN.
CONCRETE EXPOSED TO EARTH OR WEATHER: No. 6 - No. 18 BARS No. 5 BAR, W31 OR D31 WIRE, AND SMALLER	2 IN. 1 1/2 IN.
CONCRETE NOT EXPOSED TO EARTH OR WEATHER OR IN CONTACT WITH GROUND: SLABS, WALLS, AND JOISTS: No. 14 AND No. 18 BARS No. 11 BARS AND SMALLER	1 1/2 IN. 3/4 IN.
BEAMS AND COLUMNS: PRIMARY REINFORCEMENT, STIRRUPS, TIES AND SPIRALS	1 1/2 IN.
SURFACES EXPOSED TO LIQUIDS:	2 IN.
SLABS ON GRADE - 1/3 SLAB THICKNESS FROM TOP OF SLAB OR AS SHOWN ON DRAWINGS	

TENSION LAP SCHEDULE:

Fc = 3000 PSI TENSION LAP SPLICE LENGTHS (INCHES) - TOP BARS (NOTES 1 AND 2)

BAR COVER (INCHES)	3/4			1 1/2			1 1/2		
BAR SPACING (INCHES)	2 1/2	4	>=6	2 1/2	4	>=6	2 1/2	4	>=6
#4	29	29	29	29	29	29	29	29	29
#5	36	36	36	36	36	36	36	36	36
#6	43	43	43	43	43	43	43	43	43
#7	69	69	69	66	63	63	66	63	63
#8	-	-	-	86	72	72	86	72	72
#9	-	-	-	109	81	63	109	81	81

Fc = 4000 PSI TENSION LAP SPLICE LENGTHS (INCHES) - TOP BARS (NOTES 1 AND 2)

BAR COVER (INCHES)	3/4			1 1/2			1 1/2		
BAR SPACING (INCHES)	2 1/2	4	>=6	2 1/2	4	>=6	2 1/2	4	>=6
#4	25	25	25	25	25	25	25	25	25
#5	31	31	31	31	31	31	31	31	31
#6	37	37	37	37	37	37	37	37	37
#7	60	60	60	57	54	54	57	54	54
#8	-	-	-	74	62	62	74	62	62
#9	-	-	-	94	70	70	94	70	70

NOTES:

- TOP BARS ARE DEFINED AS HORIZONTAL BARS WITH MORE THAN 12" OF CONCRETE CAST BELOW THE BARS.
- FOR BARS OTHER THAN TOP BARS, DIVIDE DEVELOPMENT LENGTH SPECIFIED IN TABLE BY 1.3.
- INTERPOLATE FOR SPLICE LENGTHS AS NECESSARY.
- TENSION LAP SPLICES ARE BASED ON CLASS B. FOR CLASS A, DIVIDE BY 1.3. UNLESS NOTED OTHERWISE IN DRAWINGS, ASSUME ALL SPLICES AS CLASS B.
- IF SPLICE DIMENSION IS INDICATED IN DRAWINGS, PROVIDE LARGER SPLICE LENGTH.
- LAP SPLICE TABLES ARE BASED ON ACI 318002, SECTIONS 12.2.2, 12.2.3 & 12.14.2
- VALUES SHOWN IN TABLE MAY BE LOWERED WITH Ktr IF TRANSVERSE REINFORCEMENT EXISTS PER 12.2.3.



ISSUE

NO.	DATE	DESCRIPTION
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01/22/2026 FOR CONSTRUCTION

DATE 01.22.2026

JOB NO. 2025139

DRAWN JMR

CHECKED JMR

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TITLE GENERAL NOTES

SHEET NO.

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F. STRUCTURAL STEEL:

1. GENERAL:  
THE STRUCTURAL STEEL IS DESIGNED TO BE CAPABLE OF WITHSTANDING CODE PRESCRIBED DESIGN FORCES AND FULLY STABLE WHEN THE STRUCTURE (I.E., BUILDING) IS TOTALLY CONSTRUCTED (I.E., FULLY BUILT). THE STEEL ERECTOR SHALL DETERMINE, FURNISH, AND INSTALL ALL TEMPORARY SUPPORTS, SUCH AS TEMPORARY GUYS, BEAMS, FALSE-WORK, CRIBBING OR OTHER ELEMENTS REQUIRED FOR THE ERECTION OPERATION. THE STEEL ERECTOR SHALL PROVIDE THESE TEMPORARY SUPPORTS THAT SHALL BE SUFFICIENT TO SECURE THE BARE STRUCTURAL STEEL FRAMING, OR ANY PORTION THEREOF, AGAINST LOADS THAT ARE LIKELY TO BE ENCOUNTERED DURING ERECTION INCLUDING THOSE DUE TO WIND AND THOSE THAT RESULT FROM ERECTION OPERATIONS.  
  
STEEL FABRICATOR AND ERECTOR FOR ALL STEEL SHALL FOLLOW ALL APPLICABLE REQUIREMENTS OF THE LATEST DOL PUBLICATION "SAFETY STANDARDS FOR STEEL ERECTIONS FINAL RULE".

2. MATERIALS:  
  
a. W-SHAPE MEMBERS: ASTM A572, Fy=50 KSI, AND PER AISC TECHNICAL BULLETIN #3 (OR ASTM A992), AND ASTM 6  
b. CHANNELS, M-SHAPES, S-SHAPES: ASTM A572, Fy=50 KSI, AND ASTM 6  
c. HOLLOW STRUCTURAL SHAPES (DESIGNATED AS HSS OR TS): ASTM 500, GRADE B, (ROUND HSS -> Fy=42 KSI) (SQUARE & RECTANGULAR HSS -> Fy= 46 KSI)  
d. TEES: SAME MATERIAL OF THE FULL SECTIONS THAT WAS SPLIT TO MAKE THE TEE SECTION  
e. MISC. STEEL, PLATES, AND ANGLES: ASTM A36 Fy=36 KSI, OR ASTM A572, GRADE 42 WHERE NOTED ON THE DRAWINGS, AND ASTM A6  
f. HIGH STRENGTH BOLTS: ASTM A325 OR A490  
g. ANCHOR BOLTS: ASTM F1554, GRADE 55  
h. ELECTRODES: E70XX  
  
3. STANDARDS AND CODES:  
WELDING PERSONNEL AND PROCEDURES ARE TO BE QUALIFIED PER AWS D1.1 UNLESS SPECIFICALLY SHOWN OTHERWISE. DESIGN, FABRICATION, AND ERECTION TO BE GOVERNED BY THE LATEST REVISIONS OF:  
  
a. AISC CODE OF STANDARD PRACTICE FOR STEEL BUILDINGS AND BRIDGES.  
b. STRUCTURAL WELDING CODE, AWS D1.1 OF THE AMERICAN WELDING SOCIETY  
c. AISC SPECIFICATION FOR STRUCTURAL JOINTS USING ASTM A325 OR 490 BOLTS.  
  
4. CONNECTIONS:  
  
a. CONNECTIONS MAY BE BOLTED OR WELDED. THE FABRICATOR IS RESPONSIBLE FOR THE DESIGN OF CONNECTIONS NOT DESIGNED ON THE DRAWINGS. GENERALLY, CONNECTIONS SHOWN ON THE STRUCTURAL DRAWINGS ARE SCHEMATIC AND ARE ONLY INTENDED TO SHOW THE RELATIONSHIP OF MEMBERS CONNECTED. ANY CONNECTION THAT IS NOT SHOWN OR IS NOT COMPLETELY DETAILED ON THE STRUCTURAL DRAWINGS SHALL BE DESIGNED BY AN ENGINEER, REGISTERED IN THE STATE OF OHIO, RETAINED BY THE FABRICATOR. IT IS THE RESPONSIBILITY OF THE FABRICATOR TO PROVIDE ALL STIFFENER PLATES, ETC., THAT MAY BE REQUIRED IN ADDITION TO THOSE SHOWN ON THE STRUCTURAL SCHEMATIC DETAILS TO ENSURE THAT THE MEMBERS CONNECTED TOGETHER HAVE ADEQUATE STRENGTH AT THE CONNECTION. COMPLETELY DETAILED INCLUDES PROVIDING THE FOLLOWING INFORMATION ON THE DETAIL.  
  
i. ALL PLATE DIMENSIONS AND GRADES  
ii. ALL WELD SIZES, LENGTHS, PITCHES AND RETURNS  
iii. ALL HOLE SIZES AND SPACINGS.  
iv. NUMBER AND TYPES OF BOLTS  
  
b. CONNECTIONS SHALL BE DESIGNED FOR ONE-HALF OF THE ALLOWABLE LOAD ON THE MEMBER, AS DEFINED IN THE AISC TABLES FOR ALLOWABLE LOADS ON BEAMS AS W<sub>o</sub>/2L OR THE REACTIONS SHOWN ON THE DRAWINGS, WHICHEVER IS GREATER.  
  
c. MOMENT CONNECTIONS SHALL BE DESIGNED FOR THE FULL MOMENT CAPACITY WHERE MAGNITUDE IS NOT SHOWN ON DRAWINGS AND THE SHEAR OBTAINED FROM NOTE b. ABOVE.  
  
d. THE MINIMUM PLATE THICKNESS SHALL BE 3/8", THE MINIMUM BOLT DIAMETER SHALL BE 3/4", THE MINIMUM WELD SHALL BE 1/4"x 2" LONG AND THE MINIMUM LOAD ON ANY CONNECTION SHALL BE 10 KIPS.  
  
e. PROVIDE WELDED STIFFENER PLATES ON BOTH SIDES OF THE WEB OF BEAMS AT POINT OF CONCENTRATED LOADS, INCLUDING BEAMS SUPPORTING COLUMNS OR RUNNING OVER THE TOPS OF COLUMNS, OR GIRDERS, AND AT THE LOCATION OF CHANGE OF SLOPE (KINKS) AT ANY MEMBER. MINIMUM STIFFENER PLATE THICKNESS SHALL BE 5/8" OR FLANGE THICKNESS OF THE COLUMN ABOVE OR BELOW, WHICHEVER IS GREATER.  
  
f. SLIP CRITICAL CONNECTIONS OF A325SC OR A490SC BOLTS SHALL BE USED FOR ALL BOLTED CONNECTIONS OF MOMENT CONNECTIONS, CANTILEVERS AND AS SHOWN ON THE DRAWINGS. OVERSIZED AND LONG-SLOTTED HOLES ARE ALLOWED FOR SLIP CRITICAL CONNECTIONS. ALL OTHER BOLTED CONNECTIONS SHALL BE BEARING TYPE USING A325N OR A490N BOLTS.  
  
g. PROTRUDING BOLT HEADS, SHAFTS OR NUTS SHALL NOT EXTEND INTO NOR PROHIBIT THE APPLICATION OF ARCHITECTURAL FINISHES AND THEY SHALL NOT EXTEND INTO NOR PROHIBIT THE PLACEMENT OF STEEL DECKING TO THE CORRECT LINE AND ELEVATION.  
  
h. SHOP DRAWINGS SHALL INDICATE THE TYPE OF BOLT USED IN EACH CONNECTION AND THE ALLOWABLE BALUES USED FOR THE BARIOUS BOLT TYPES.  
  
i. FABRICATOR SHALL PROVIDE FILLER PLATES BETWEEN ALL DOUBLE ANGLES AT INTERVALS SUCH THAT THE SLENDERNESS RATIO OF A SINGLE ANGLE DOES NOT CONTROL.  
  
j. ALL EXPOSED WELDS SHALL BE GROUND SMOOTH.  
  
k. SPLICING OF STEEL MEMBERS, UNLESS SHOWN ON THE DRAWINGS, IS PROHIBITED WITHOUT WRITTEN APPROVAL OF THE STRUCTURAL ENGINEER OF RECORD.  
  
5. PAINT:  
  
a. DO NOT PAINT STEEL OR ANCHOR BOLTS WHICH WILL BE ENCASED IN CONCRETE OR MASONRY.  
  
6. METAL DECK:  
  
a. METAL DECK TO BE AS SHOWN ON THE DRAWINGS.  
  
b. ANCHORAGE TO BE AS ASHOWN ON DRAWINGS & PER STEEL DECK INSTITUTE SPECS. UNO.  
  
c. DO NOT SUSPEND PIPES OR DUCTS FROM ROOF DECK.  
  
d. FABRICATE DECK UNITS IN LENGTHS TO SPAN THREE OR MORE SUPPORT SPACINGS.  
  
e. DECKING MANUFACTURER SHALL COORDINATE SIZE AND LOCATION OF ROOF OPENINGS WITH MECHANICAL DRAWINGS.  
  
f. METAL ROOF DECK USED IN THE BUILDING SHALL NOT HAVE SECTION PROPERTIES PER FOOT OF WIDTH LESS THAN THE FOLLOWING:  
1.5" 20GA, TYPE B; I<sub>p</sub>=0.201 IN<sup>3</sup>, S<sub>n</sub>=0.247 IN<sup>3</sup>."

F. STRUCTURAL STEEL (Cont.):  
  
7. STEEL JOISTS:  
  
a. ALL JOISTS SHALL BE DESIGNED, FABRICATED, AND ERECTED IN ACCORDANCE WITH THE LATEST EDITION OF THE STANDARD SPECIFICATIONS OF THE STEEL JOIST INSTITUTE.  
  
b. JOIST SIZES INDICATED ON PLANS ARE MINIMUMS. JOIST MANUFACTURER SHALL DESIGN AND SUBMIT CALCULATIONS BY AN ENGINEER REGISTERED IN THE STATE OF OHIO. FOR JOISTS HAVING ANY ADDITIONAL CONCENTRATED LOADS, SUCH AS MECHANICAL EQUIPMENT, SUSPENDED FOLDING PARTITIONS, ETC., OR UN-BRACED COMPRESSION CHORDS AND/OR OTHER UNUSUAL CONDITIONS, MANUFACTURER SHALL ADJUST CHORD AND WEB SIZES ACCORDINGLY, BUT SHALL NOT ALTER DEPTH UNLESS APPROVED IN WRITING.  
  
c. CONTRACTOR SHALL SUBMIT SHOP DRAWINGS FOR REVIEW PRIOR TO MANUFACTURE. SHOP DRAWINGS AND CALCULATIONS SHALL INCLUDE DETAILS OF ANY OPTIONAL FIELD SPLICES AND IF HIGH STRENGTH BOLTS OR FULL PENETRATION WELDS ARE UTILIZED, CONTRACTOR SHALL RETAIN AN INDEPENDENT TESTING LAB TO CERTIFY COMPLIANCE WITH AISC AND AWS SPECIFICATIONS, RESPECTIVELY.  
  
d. JOISTS MUST NOT ALIGN WITH CMU WALLS BELOW. CENTERLINE OF JOIST SHALL BE A MINIMUM OF 6" AWAY FROM FACE OF CMU WALL BELOW.  
  
8. MISCELLANEOUS:  
  
a. PROVIDE HOLES FOR OTHERS AS NOTED. IF OPENING IS NOT SHOWN ON THE STRUCTURAL DRAWINGS, OBTAIN PRIOR APPROVAL.  
  
b. STEEL SUPPORTING OR CONNECTING TO MECHANICAL AND OTHER EQUIPMENT AS SHOWN ON DRAWINGS IS SHOWN FOR BIDDING PURPOSES ONLY. CONTRACTOR SHALL RECONCILE EXACT SIZE AND LOCATION WITH MECH. AND OTHER REQUIREMENTS BEFORE PROCEEDING WITH HIS WORK.  
  
c. GROUT UNDER BEARING PLATES TO BE NON-SHRINKING, NON-METALLIC TYPE.  
  
d. ALL COLUMN ANCHOR BOLTS TO BE SET BY LICENSED SURVEYOR.  
  
e. PROVIDE HEAVY HEX NUT AND COMPATIBLE WASHER AT ALL ANCHOR BOLTS.  
  
f. MIN. BEAM BEARING ON MASONRY SHALL BE 8".  
  
g. MIN. BEAM BEARING ON STEEL SHALL BE 4".  
  
h. NO CHANGE IN SIZE OR POSITION OF THE STRUCTURAL ELEMENTS SHALL BE MADE AND HOLES, SLOTS, CUTS, ETC., ARE NOT PERMITTED THROUGH ANY MEMBER UNLESS THEY ARE DETAILED ON THE APPROVED SHOP DRAWINGS.  
  
i. FABRICATE ALL BEAMS WITH THE MILL CAMBER UP.  
  
j. ALL EXPOSED STEEL ITEMS SHALL BE GALVANIZED.  
  
G. LIGHT GAUGE STEEL FRAMING:  
  
1. ALL LIGHT GAUGE METAL STUD FRAMING, INCLUDING HEADERS, SILLS, TRACKS AND OTHER ASSOCIATED FRAMING MEMBERS AND ACCESSORIES, AND THEIR CONNECTIONS TO STRUCTURE IS A DELEGATED DESIGN TO BE PROVIDED BY THE LIGHT GAUGE FRAMING CONTRACTOR. ALL LIGHT GAUGE STRUCTURAL MEMBERS SHALL BE DESIGNED IN ACCORDANCE WITH THE LATEST EDITION OF THE AISI "SPECIFICATION FOR THE DESIGN OF COLD-FORMED STEEL STRUCTURAL MEMBERS." SEE SPECIFICATIONS FOR ADDITIONAL INFORMATION AND DESIGN REQUIREMENTS. THE LIGHT GAUGE METAL STUD FRAMING AND THE CONNECTIONS TO STRUCTURE SHOWN ON THE STRUCTURAL DRAWINGS ARE PROVIDED FOR DESIGN INTENT ONLY. THE DEPTH OF THE METAL STUDS SHOWN IN THE DETAILS SHALL BE PROVIDED.  
  
2. THE DESIGN OF ALL LIGHT GAUGE FRAMING MEMBERS AND THEIR CONNECTIONS TO STRUCTURE SHALL BE PERFORMED BY A REGISTERED ENGINEER RETAINED BY THE LIGHT GAUGE FRAMING CONTRACTOR. SUBMIT SEALED STRUCTURAL CALCULATIONS FOR REVIEW ALONG WITH THE LIGHT GAUGE FRAMING SHOP DRAWINGS. CONNECTIONS OF ALL FRAMING MEMBERS SHALL BE WITH SELF-DRILLING GALVANIZED SCREWS OR WELDING. SCREWS AND WELDS SHALL BE OF SUFFICIENT SIZE TO RESIST ALL REQUIRED LOADS INCLUDING WIND. ALL WELDS SHALL BE TOUCHED-UP WITH A ZINC-RICH GALVANIZING PAINT.  
  
3. METAL TRACKS SHALL HAVE 1.50-INCH FLANGES AND MATCH THE MATERIAL GAUGE OF THE IN-FRAMING METAL STUDS, U.N.O. THE IN-FRAMING METAL STUDS SHALL BE CONNECTED TO EACH TRACK FLANGE WITH ONE #10 SCREW. FULL HEIGHT BACK-TO-BACK DOUBLE STUDS SHALL BE PROVIDED AT ALL WALL ENDS, CORNERS AND EACH SIDE OF OPENINGS (JAMBS). ALL BOX BEAM HEADERS SHALL BEAR ON AN 18-GAUGE TRIMMER STUD WITH A NESTED TRACK, MINIMUM, U.N.O.  
  
4. METAL STUDS SHALL BE C-SHAPED WITH 50 KSI YIELD STRENGTH FOR 12, 14 AND 16 GAUGE MATERIALS, AND 33 KSI FOR 18 AND 20 GAUGE MATERIALS. FOR ALL METAL STUDS, THE MINIMUM SECTION PROPERTIES SHALL CONFORM TO SSMA GUIDELINES. BRIDGING SHALL BE PROVIDED IN CONFORMANCE WITH THE MANUFACTURER'S SPECIFICATIONS TO OBTAIN THE FULL FLEXURAL CAPACITY OF THE SECTION.  
  
5. ALL STRUCTURAL MEMBERS SHALL BE FORMED FROM CORROSION RESISTANT STEEL, CORRESPONDING TO THE REQUIREMENTS OF ASTM A653. ALL LIGHT GAUGE STEEL MEMBERS SHALL BE ZINC COATED MEETING THE REQUIREMENTS OF ASTM A924. ALL STRUCTURAL LIGHT GAUGE MEMBERS SHALL BE CONSTRUCTED WITH UNPUNCHED SOLID WEBS, UNLESS OTHERWISE NOTED.  
  
6. CONNECTIONS AT LIGHT GAUGE MATERIAL CONSTRUCTED WITH #10 HILTI KWIK-FLEX OR GRABBER SCREWS, UNLESS OTHERWISE NOTED.  
  
7. ALL FRAMING COMPONENTS SHALL BE CUT SQUARELY FOR TIGHT ATTACHMENT TO PERPENDICULAR MEMBERS, OR, AS REQUIRED, FOR AN ANGULAR FIT AGAINST ABUTTING MEMBERS.  
  
8. SPLICES IN FRAMING MEMBERS, OTHER THAN RUNNING TRACK, SHALL NOT BE PERMITTED.  
  
9. WEB STIFFENERS SHALL BE PROVIDED AT REACTION POINTS, AND/OR AT POINTS OF CONCENTRATED LOADS AS REQUIRED.  
  
10. JOIST BRIDGING SHALL BE PROVIDED TO BRACE MEMBERS AS REQUIRED TO DEVELOP FULL MEMBER STRENGTH.  
  
11. END BLOCKING SHALL BE PROVIDED WHERE JOIST ENDS ARE NOT OTHERWISE RESTRAINED FROM ROTATION.  
  
12. STRUCTURAL MEMBERS NOTED SHALL HAVE SECTION PROPERTIES AS INDICATED IN THE "PRODUCT TECHNICAL INFORMATION" DOCUMENT BY STEEL STUD MANUFACTURERS ASSOCIATION (SSMA).

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GENERAL NOTES

SHEET NO.

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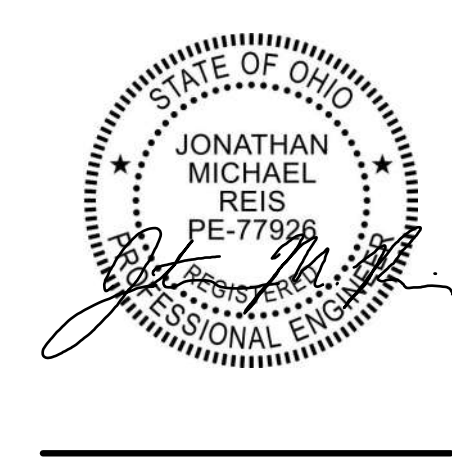
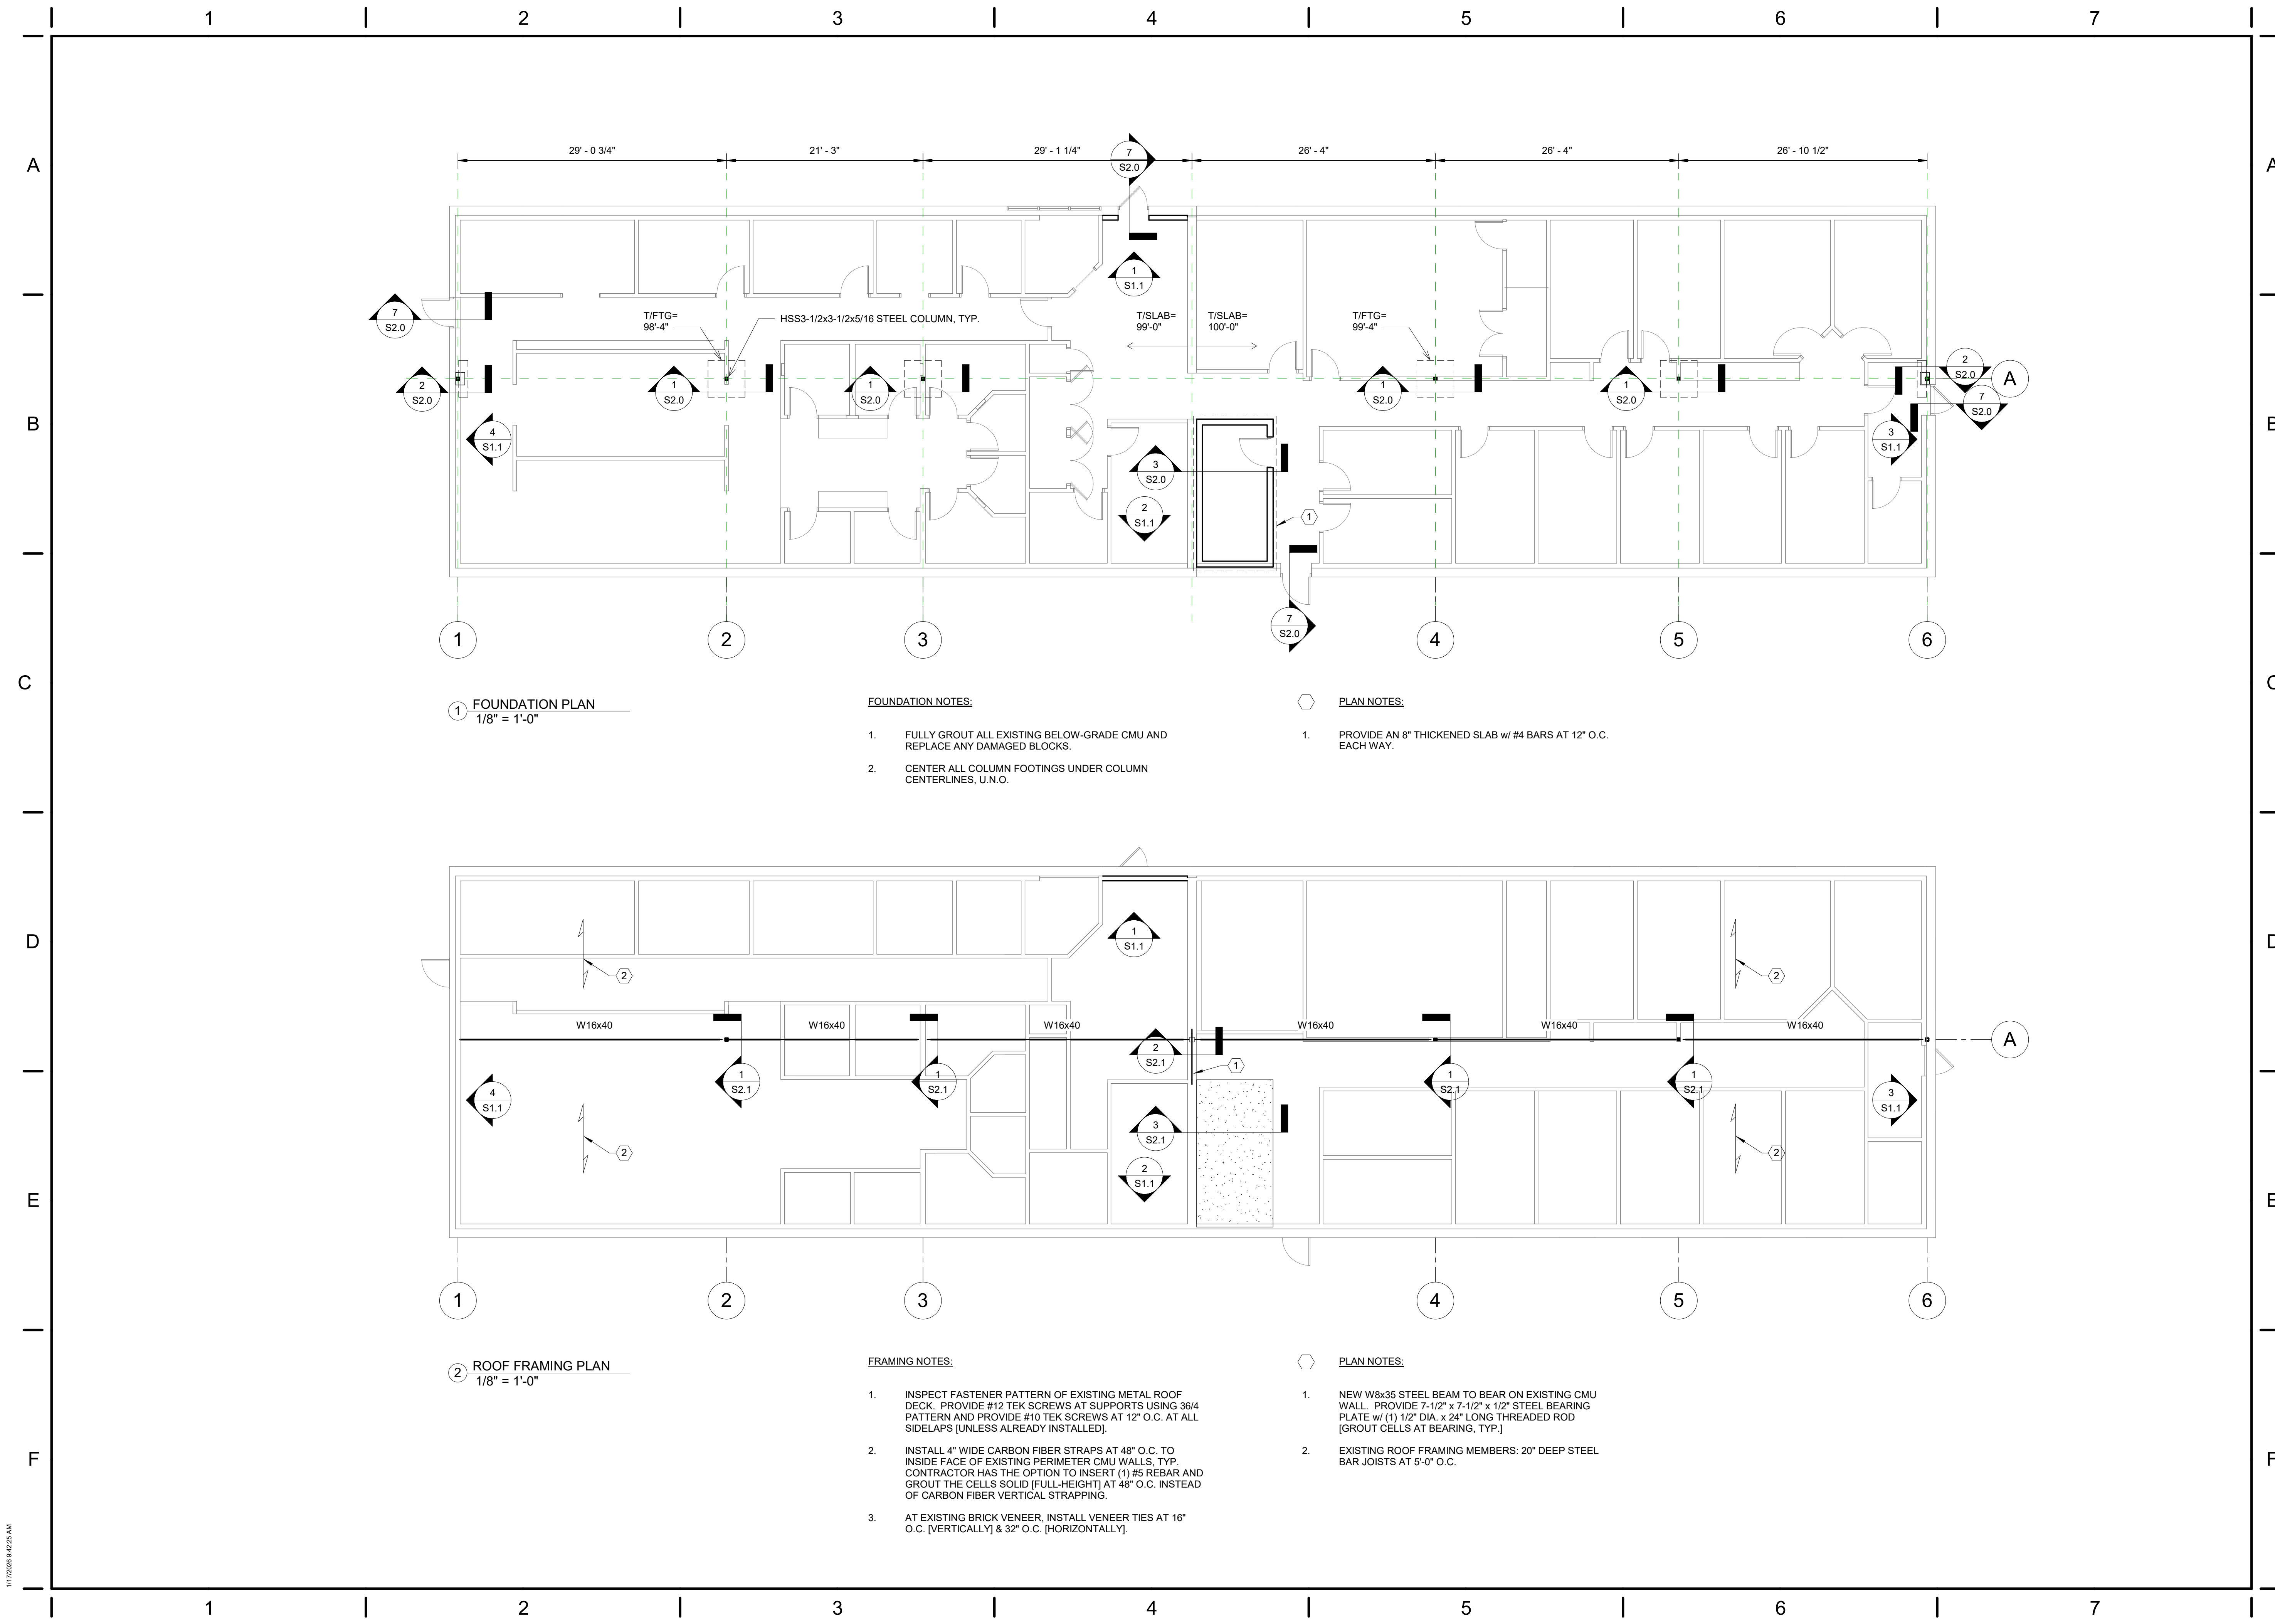
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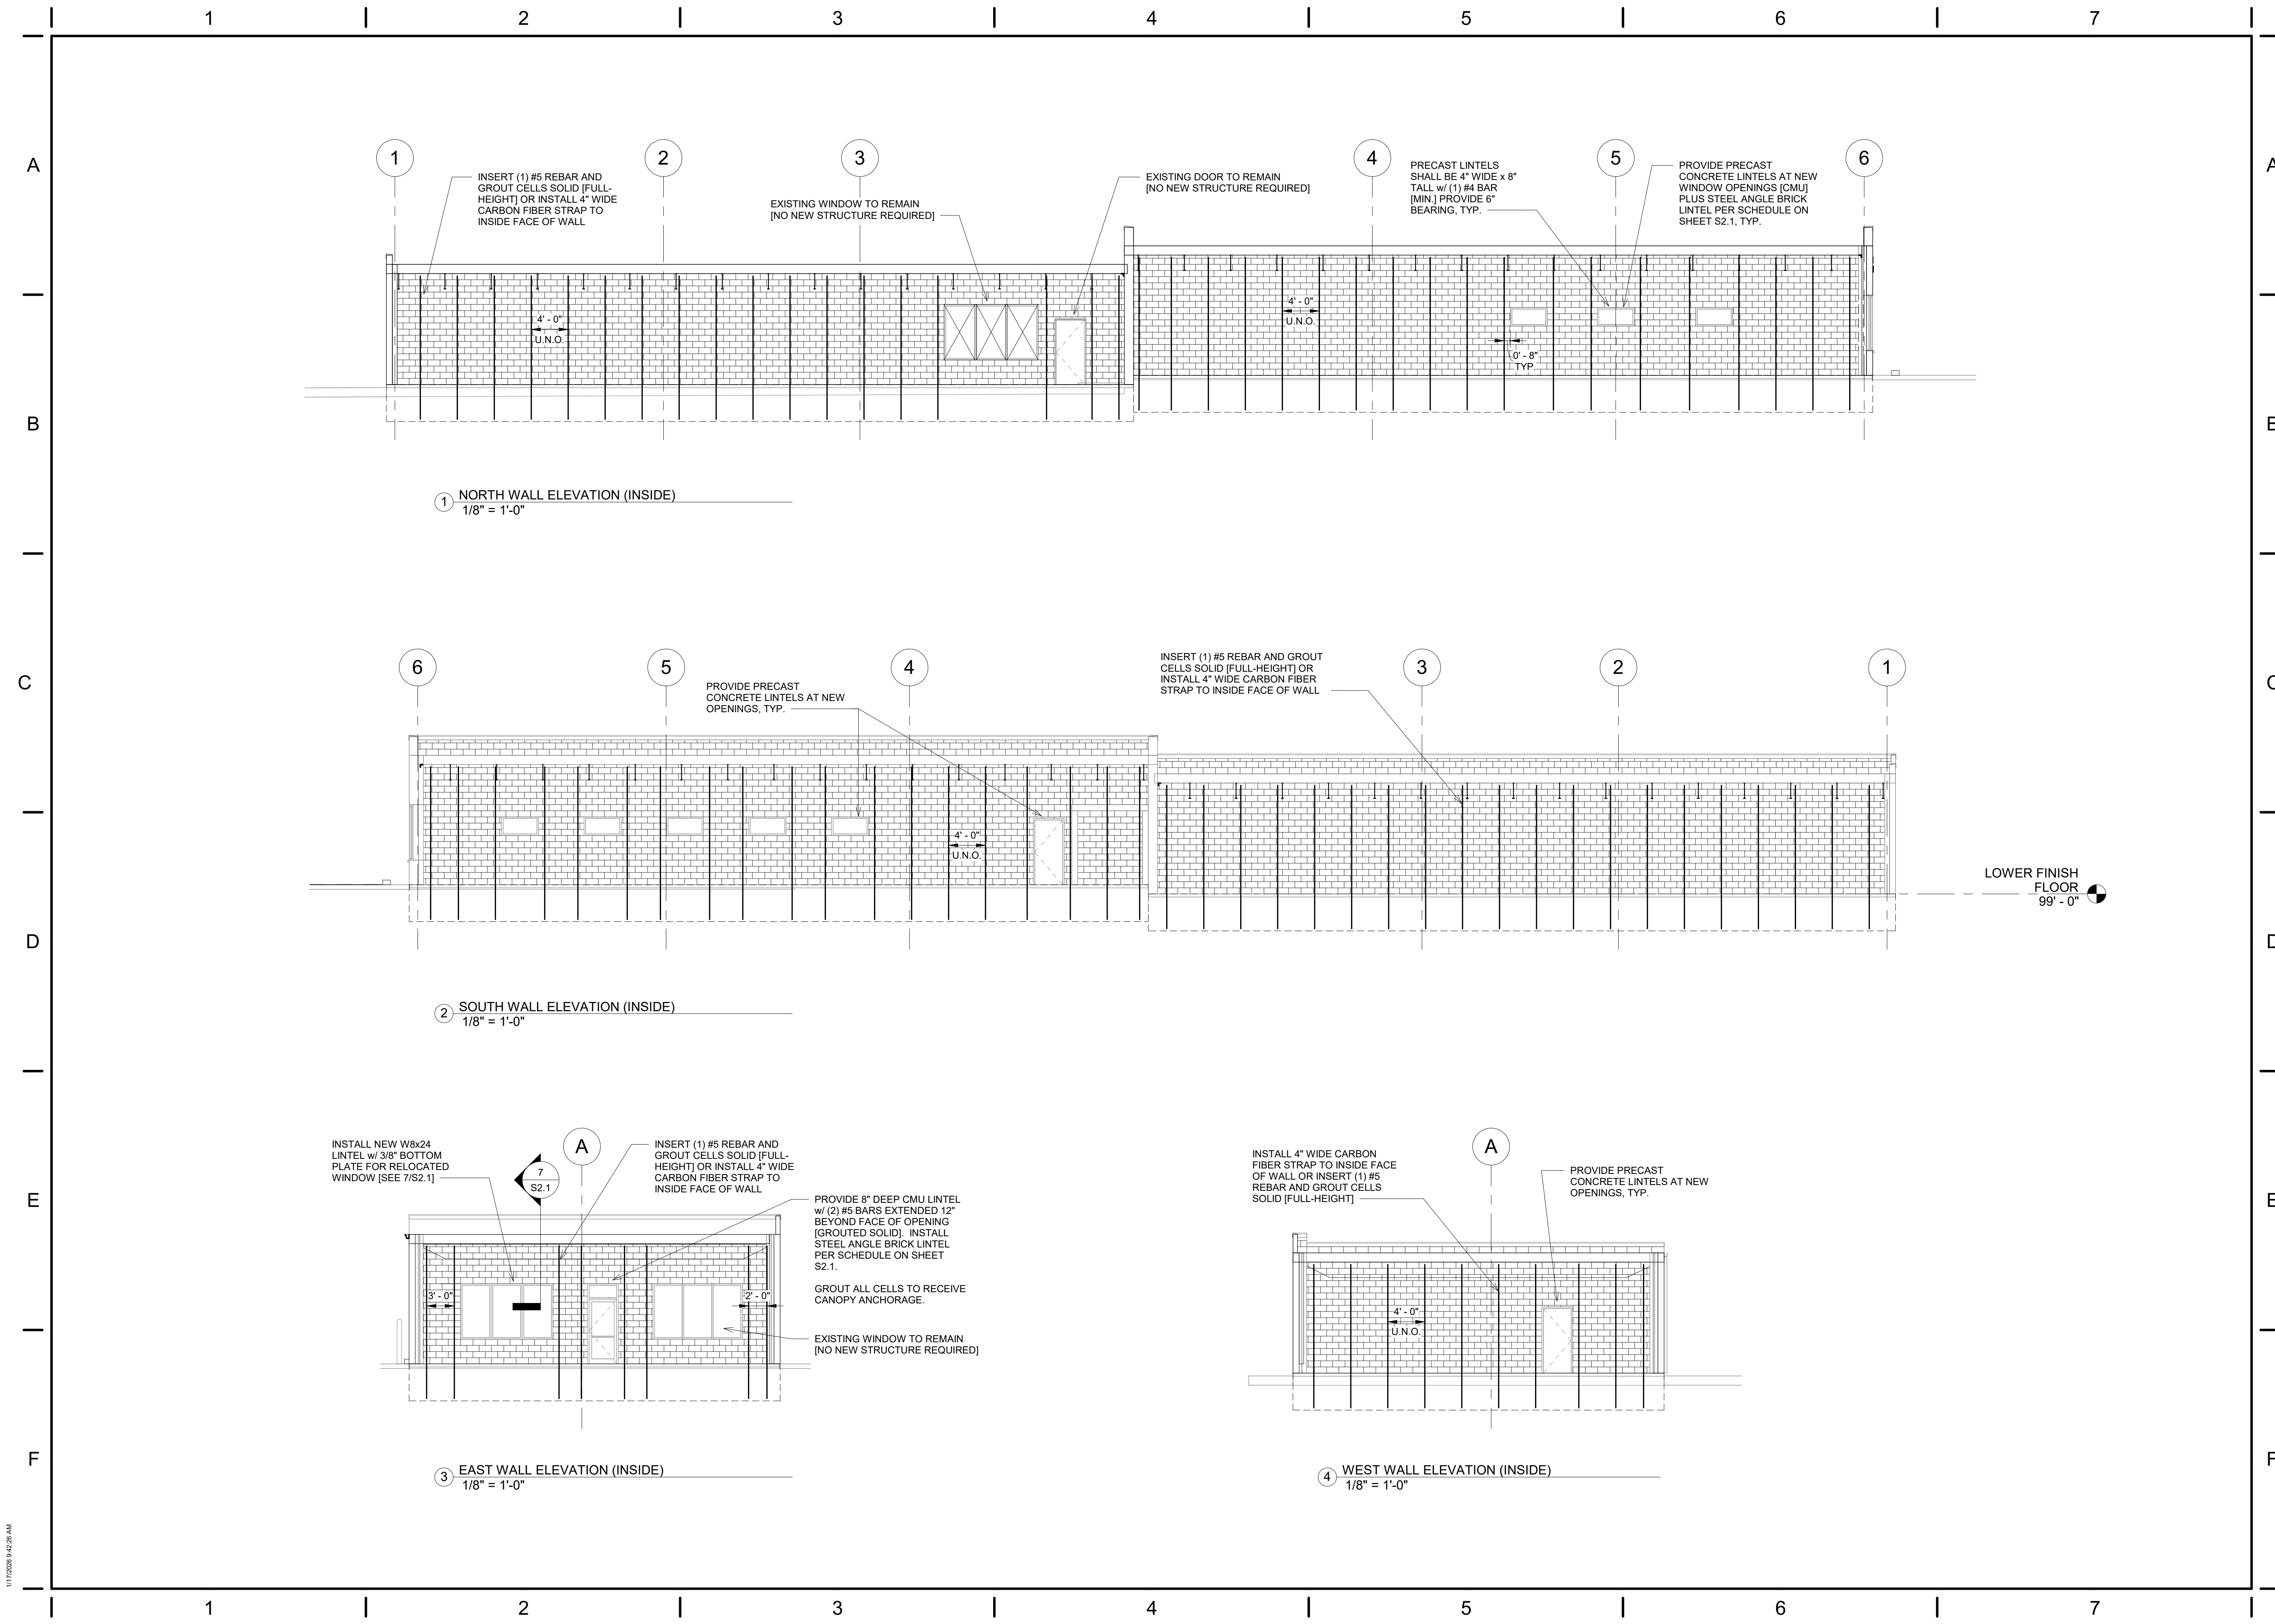
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STRUCTURAL PLANS

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S1.0






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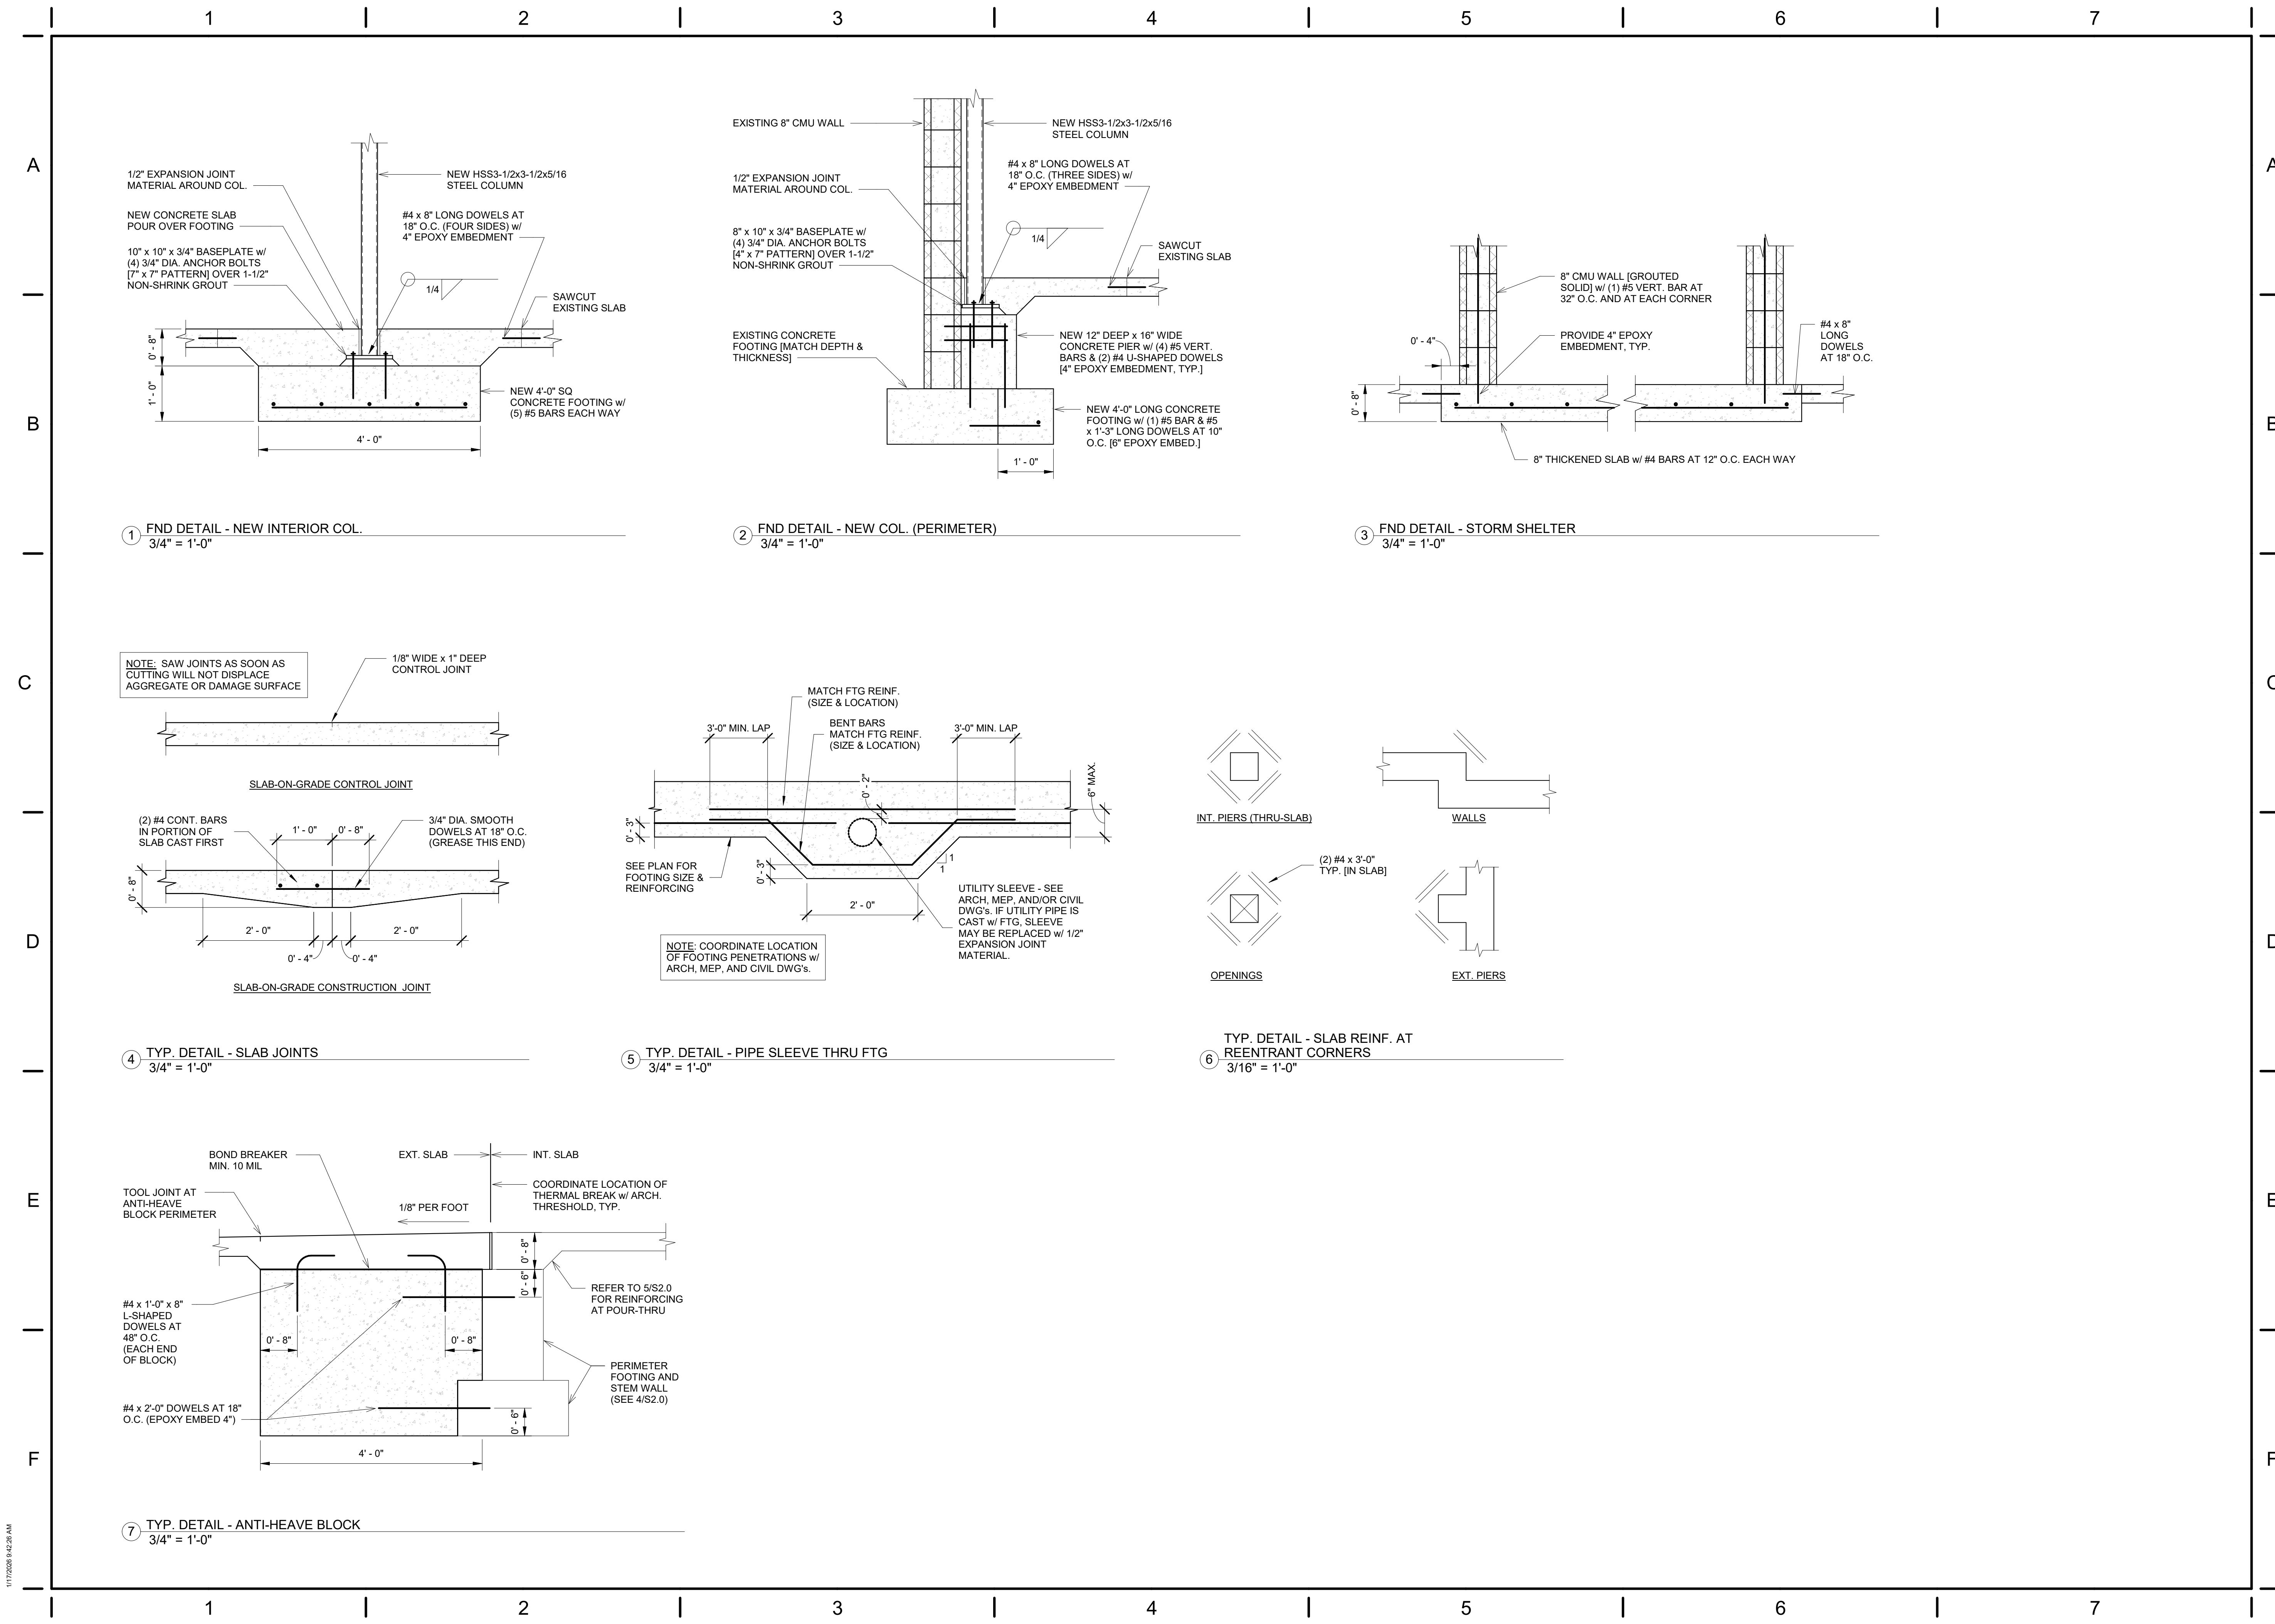
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STRUCTURAL ELEVATIONS

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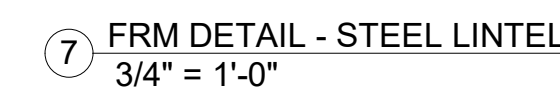
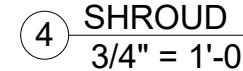
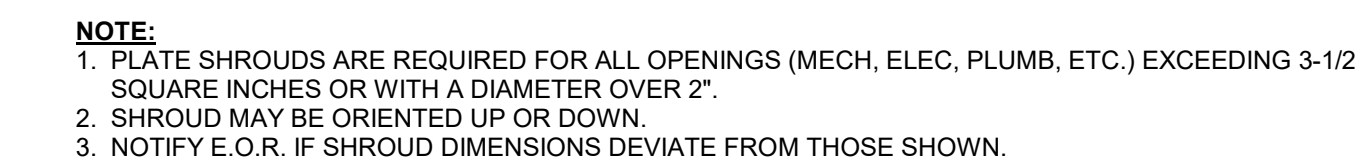
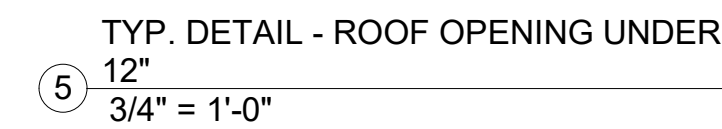
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TITLE STRUCTURAL DETAILS	

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## Harrison Township District 10 Sheriff Substation Renovation
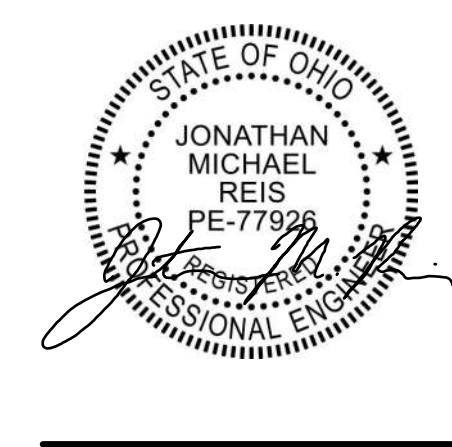
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## STRUCTURAL DETAILS

SHEET NO.

## 32.1









GAS PIPE SIZING	
PIPE SIZE (BLACK STEEL)	MAX CFH
0.5"	40
0.75"	83
1"	157
1.25"	322
1.5"	482
2"	928
2.5"	1,480
3"	2,610
GENERAL NOTES: 1. SIZING BASED ON LESS THAN 2 PSIG PRESSURE, 0.5 PSIG DROP PER TABLE 402.4(2) OF IFGC 2. TOTAL DEVELOPED LENGTH = 150 FT.	

WATER HAMMER ARRESTOR SIZING TABLE (PER PDI)		
CONNECTION SIZE	FIXTURE UNITS	CROSS REF. PDI
0.5"	1-11	A
0.75"	12-32	B
1"	33-60	C
1.25"	61-113	D
1.5"	114-154	E
2"	155-300	F

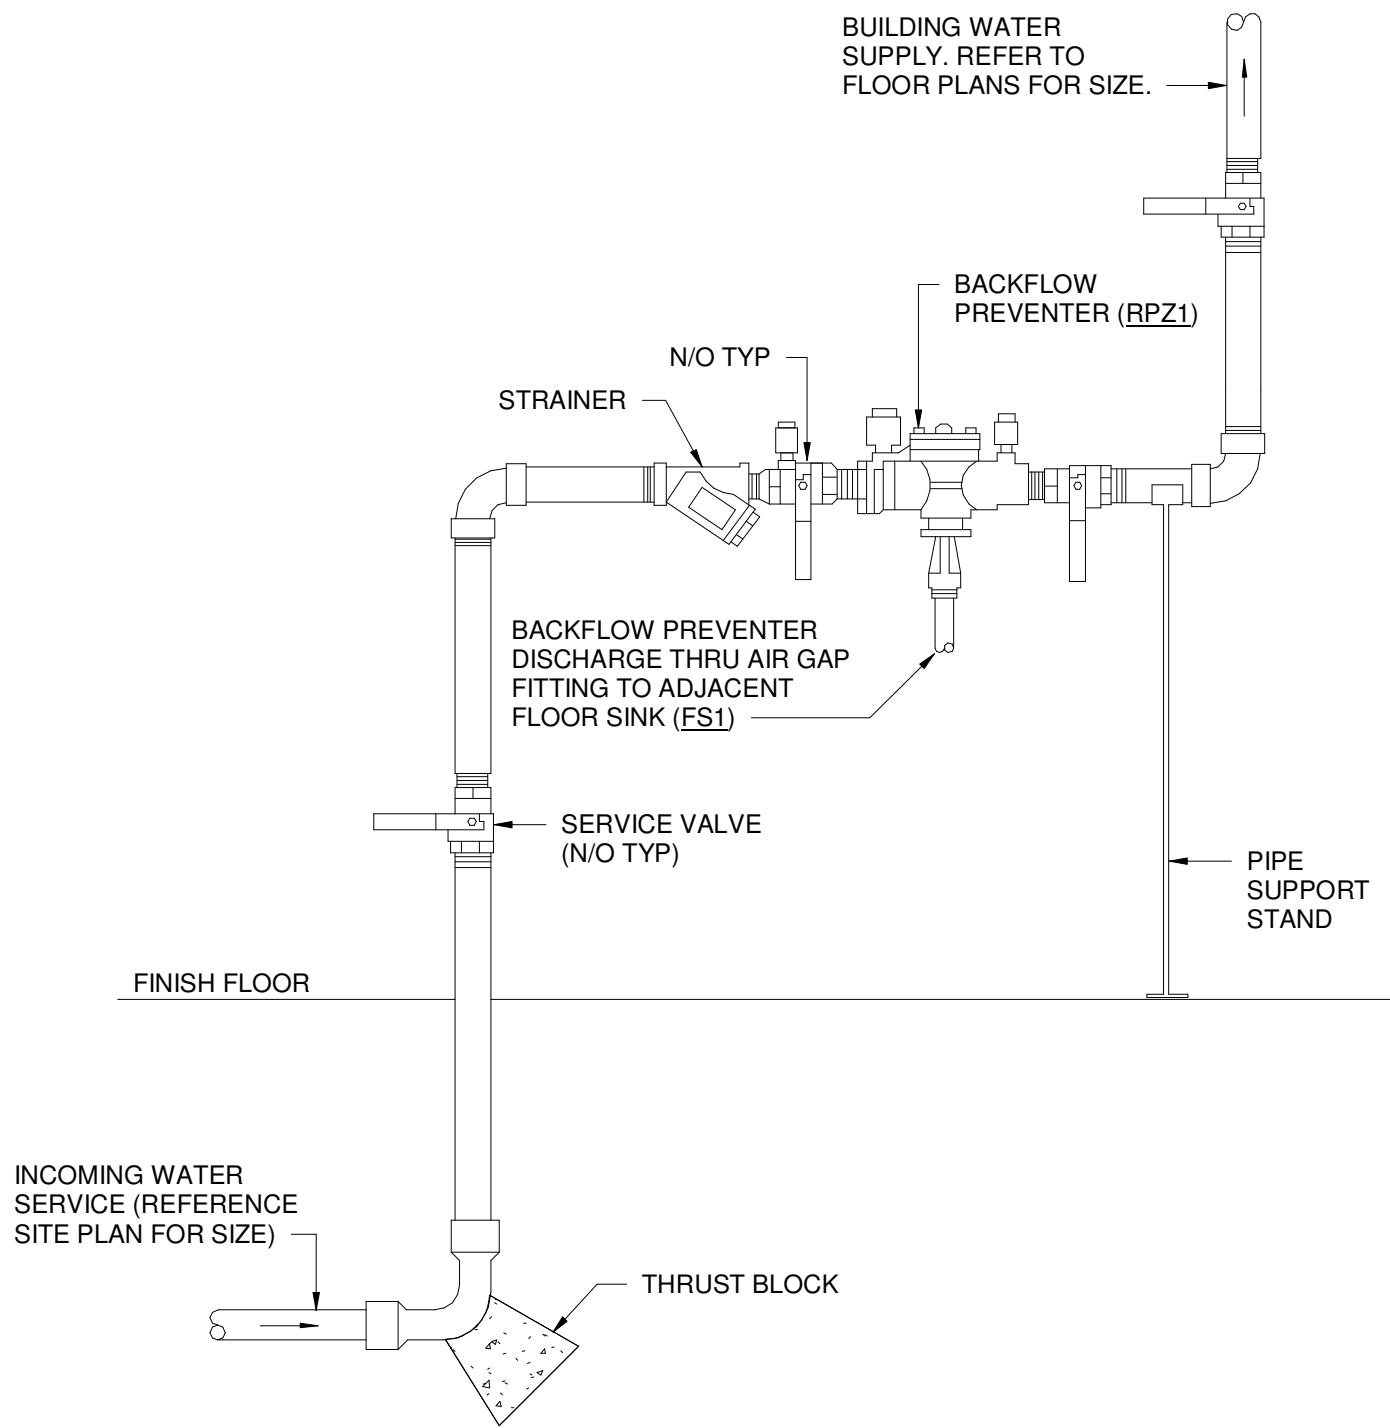

① WATER SERVICE DETAIL  
NTS

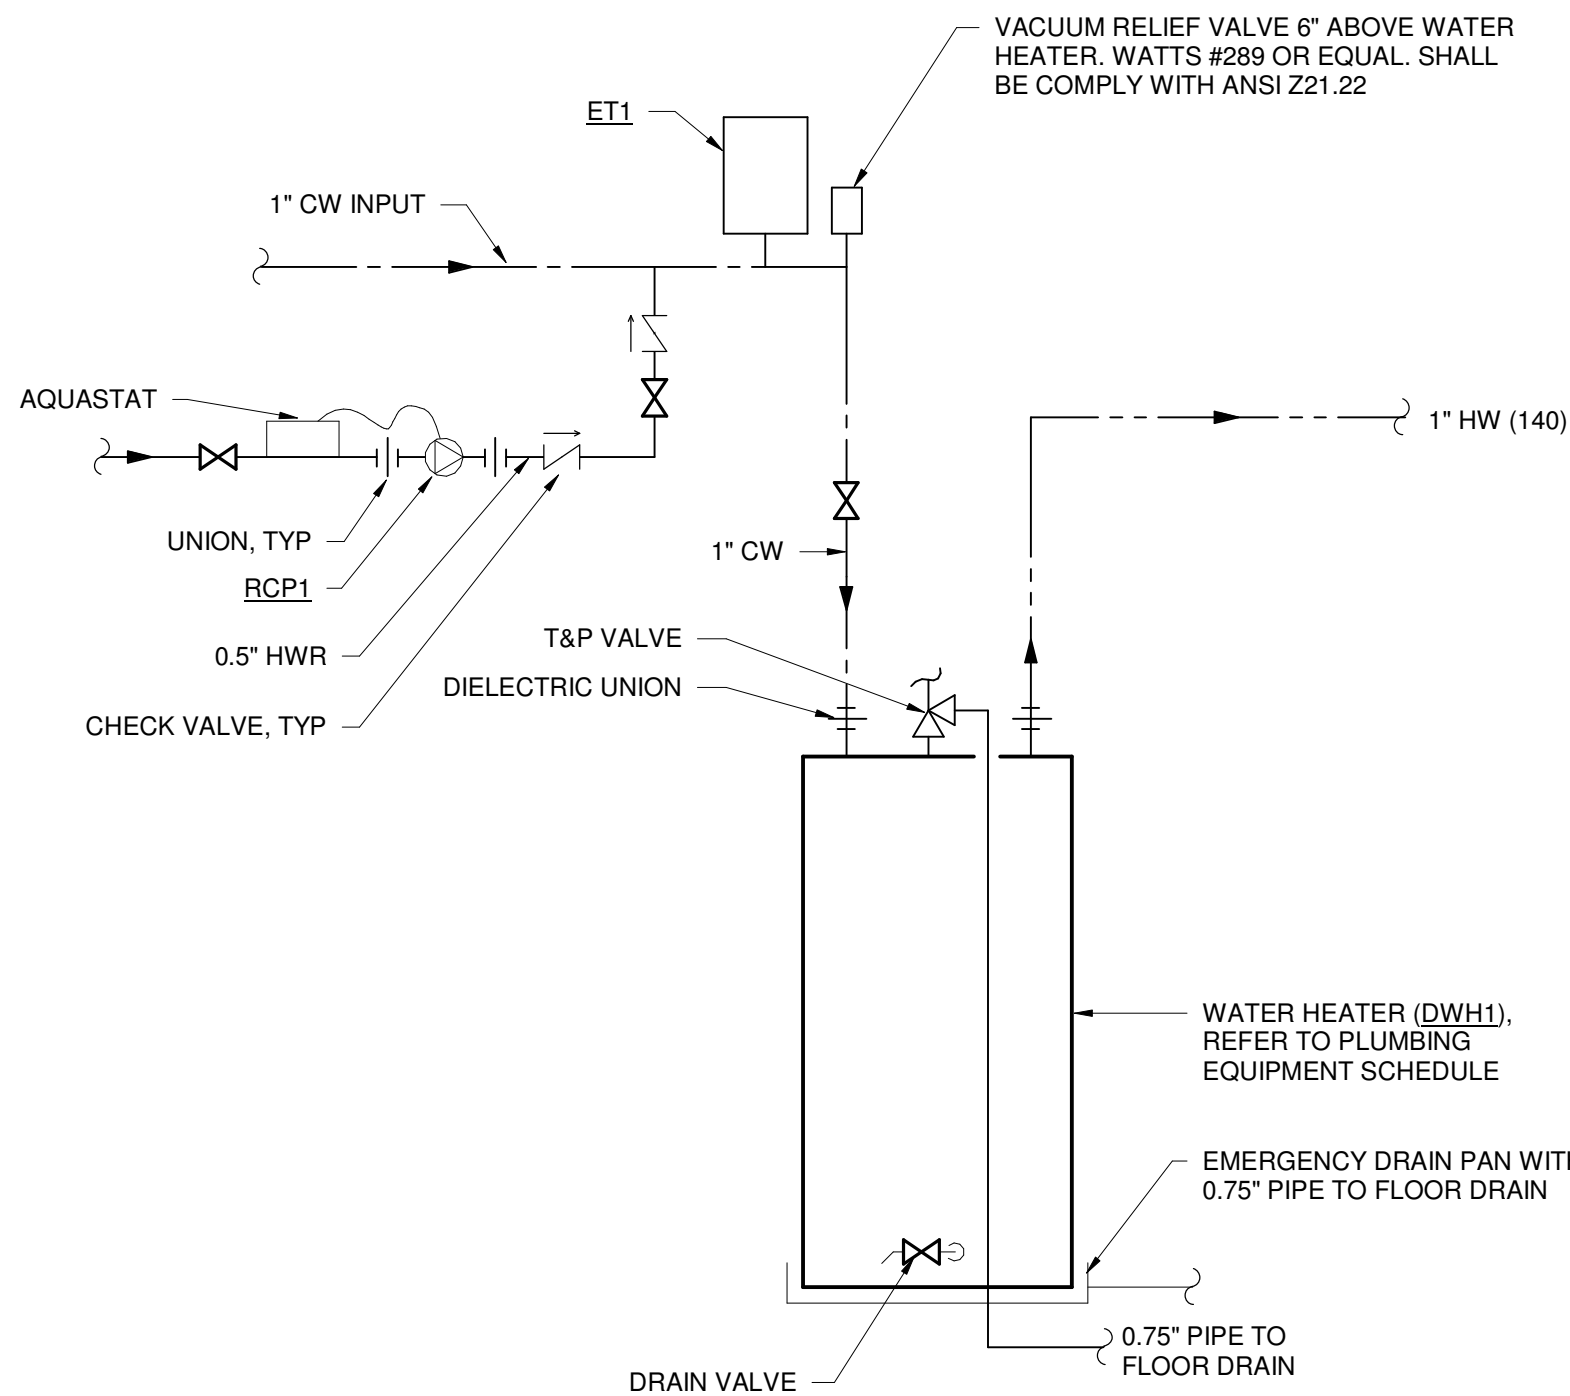


② WATER HEATER DETAIL  
NTS

PLUMBING FIXTURE SCHEDULE									
PLAN MARK	FIXTURE TYPE	DESCRIPTION	SAN	VENT	CW	HW	ACCESSORIES		NOTES
A1	WATER CLOSET - FLOOR SET - FLUSH TANK - ADA	AMERICAN STANDARD MODEL #2467.016 "CADET RIGHT HEIGHT", 16.5" HEIGHT, ELONGATED BOWL, FLOOR SET, 1.6 GPF, FLUSH TANK WATER CLOSET.	3.0"	1.5"	1.00"		PROVIDE (1) SUPPLY STOP AND OPEN FRONT SEAT.		1,2,3,4,5
B1	LAVATORY - VANITY - ADA	AMERICAN STANDARD MODEL #0476.028, "AQUALYN", 4" CENTER, DROP-IN SINK. AMERICAN STANDARD MODEL #7075.056, 0.5" GPM, SINGLE LEVER HANDLE, MANUAL FAUCET.	1.5"	1.5"	0.50"	0.5"	PROVIDE P-TRAP, (2) SUPPLY STOPS, P-TRAP SUPPLY WRAP KIT, AND ASSE 1070 APPROVED THERMOSTATIC MIXING VAVLE AND SET TO 105 DEGREES F.		1,2,3,6,7
B2	LAVATORY - COUNTERTOP - ADA	AMERICAN STANDARD MODEL #0495.221 "OVALYN" 4" CENTER, UNDERCOUNTER SINK. AMERICAN STANDARD MODEL #7075.056, 0.5" GPM, SINGLE LEVER HANDLE, MANUAL FAUCET.	1.5"	1.5"	0.50"	0.5"	PROVIDE P-TRAP, (2) SUPPLY STOPS, P-TRAP SUPPLY WRAP KIT, AND ASSE 1070 APPROVED THERMOSTATIC MIXING VAVLE AND SET TO 105 DEGREES F.		1,2,3,6,7
C1	SHOWER - ADA	SYMMONS MODEL #C-96-500-B30-V-X-1.5 "TEMPITROL COMMERCIAL", SHOWER / HAND SHOWER SYSTEM WITH TEMPITROL PRESSURE BALANCING TU / SHOWER VALVE AND SYMMONS DUAL OUTLET DIVERTER VALVE.	2.0"	1.5"	0.50"	0.5"			
D1	MOP SINK - 24"x24"x10"	MUSTEE MODEL #63M, DURACAST, FLOOR MOUNTED, INTEGRAL DRAIN. T&S BRASS MODEL #B-0655-BSTR SERVICE FAUCET, CHROME PLATED WITH VACUUM BREAKER, INTEGRAL STOPS, PAIL HOOK AND 0.75" HOSE THREADED ON SPOUT.	3.0"	1.5"	0.50"	0.5"	MUSTEE MODEL #65.600 MOP HANGER, BUMPER GUARDS, DURAGUARD WALL GUARDS.		1,2,3,8
E1	SINK - UNDERMOUNT - SINGLE BOWL - ADA	ELKAY MODEL #ELUHAD121255PD "LUSTERTONE", SINGLE BOWL, STAINLESS STEEL, ADA COMPLIANT, 4" CENTERS, UNDERMOUNT SINK. ELKAY MODEL #LK406GN0814, 4" CENTERSET, DECK MOUNT, 8" GOOSENECK SPOUT, 4" WRISTBLADE HANDLES FAUCET.	1.5"	1.5"	0.50"	0.5"	PROVIDE P-TRAP, (2) SUPPLY STOPS, BASKET STRAINER AND BADGER 5 INSINKERATOR GARBAGE DISPOSAL.		1,2,3
NOTES:									
1. REFER TO SPECIFICATIONS, DRAWINGS, DETAILS AND ISOMETRICS FOR ADDITIONAL INFORMATION.									
2. REFER TO ARCHITECTURAL DRAWINGS FOR FIXTURE HEIGHTS AND LOCATION REQUIREMENTS.									
3. CAULK / SEAL AROUND PERIMETER OF FIXTURE UNIT.									
4. FLUSH LEVER TO BE ON WIDE AREA SIDE OF TOILET ROOM PARTITION.									
5. PROVIDE A WATER HAMMER ARRESTOR, SIZE PER TABLE ON THIS SHEET.									
6. LAVATORY MUST BE MOUNTED PER MANUFACTURER ACCESSIBILITY REQUIREMENTS IN ORDER TO COMPLY WITH ADA GUIDELINES FOR PROPER KNEE CLEARANCE.									
7. PROVIDE A GRID STRAINER DRAIN.									
8. COORDINATE MOUNTING OF ACCESSORIES WITH ARCHITECT.									

PLUMBING EQUIPMENT SCHEDULE											
PLAN MARK	DESCRIPTION	COLD WATER	HOT WATER (120°F)	HOT WATER (140°F)	NATURAL GAS (CFH)	NON POTABLE	WASTE	INDIRECT	FLOOR DRAIN	NOTES	
DWH1	AO SMITH MODEL #GCR-40, 40 GALLON GAS WATER HEATER. 40 CFH, 20" DIAMETER x 58.25" HEIGHT	1"	-	1"	40	-	X	X	X	1,2	
ET1	EXPANSION TANK - DOMESTIC WATER SYSTEM - WATTS #PLT-5 - 150 PSI RATING	0.75"	-	-	-	-	-	-	-	1,3	
RCP1	HOT WATER RECIRCULATION PUMP - EQUAL TO BELL & GOSSETT MODEL #634V/BTPRC	-	-	0.75"	-	-	-	-	-	1	
RPZ1	REDUCED PRESSURE BACKFLOW ASSEMBLY - EQUAL TO WATTS MODEL #LF009-QT-S	1.5"	-	-	-	-	-	-	-	1,4	
NOTES: 1. REFER TO MANUFACTURER'S INSTALLATION INSTRUCTIONS FOR INSTALLATION REQUIREMENTS. 2. SET WATER HEATER TEMPERATURE TO 140 DEGREES FAHRENHEIT. 3. INSTALL ON COLD WATER INLET SIDE OF WATER HEATER. 4. PROVIDE WATTS AIR GAP FITTING MODEL #909AG-F AND DISCHARGE TO BUILDING EXTERIOR.											

DRAIN AND CLEANOUT SCHEDULE																																		
PLAN MARK	APPROVED SUPPLIERS - J.R. SMITH, JOSAM, WATTS, ZURN  ZURN CATALOG NO.	TYPE				BODY				OUTLET			STRAINER/GRATE						TOP FINISH				ADDITIONAL FEATURES								SEE NOTE			
		FLOOR	ROOF	WALL	DECK	CAST IRON	BRASS	ACID RESIST.	STAINLESS STEEL	SIZE	BOTTOM	SIDE	SIZE	ADJUSTABLE	FLAT	DOME	RECESSED	FUNNEL	HINGED	1/2 GRATE	NICKEL-BRONZE	CAST IRON	POLYETHYLENE	STAINLESS STEEL	ANCHOR FLANGE	FLASHING CLAMP	DBL DRAINAGE	SED. BUCKET	AUX. STRAINER	GRAVELSTOP		U/DECK CLAMP	TRAP PRIMER	
FD1	Z507	X	-	-	-	X	-	-	-	3"	X	-	7"	-	X	-	-	-	-	-	-	X	-	-	-	-	X	X	X	-	-	-	-	1,2
FS1	Z1751-2	X	-	-	-	-	-	-	X	4"	X	-	12"x12"x8"	-	-	-	-	-	-	X	-	-	-	X	-	-	-	-	-	-	-	-	1,2	
FCO	ZN1400-B	X	-	-	-	X	-	-	-	6"	X	-	7-7/8"	X	-	-	-	-	-	-	X	-	-	-	-	-	-	-	-	-	-	-	1	
NOTES: 1. REFER TO MANUFACTURER'S INSTALLATION INSTRUCTIONS FOR INSTALLATION REQUIREMENTS. 2. PROVIDE TRAP SEAL PROTECTION DEVICE EQUAL TO Z1072.																																		

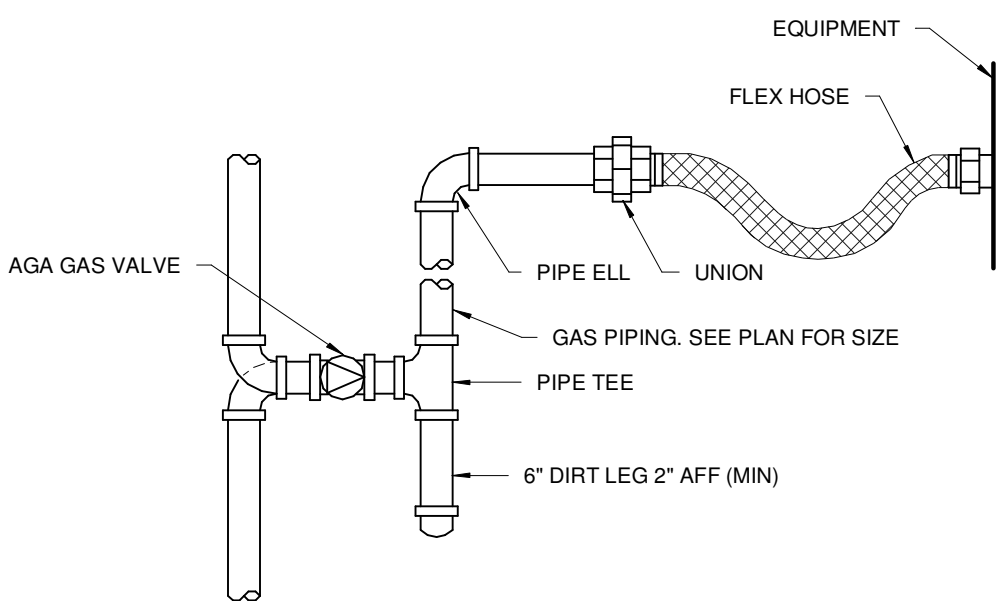

③ GAS EQUIPMENT CONNECTION DETAIL  
NTS




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TITLE PLUMBING DETAILS AND SCHEDULES	





1 BELOW FLOOR PLUMBING PLAN - DEMOLITION  
1/8" = 1'-0"

### DRAWING NOTES

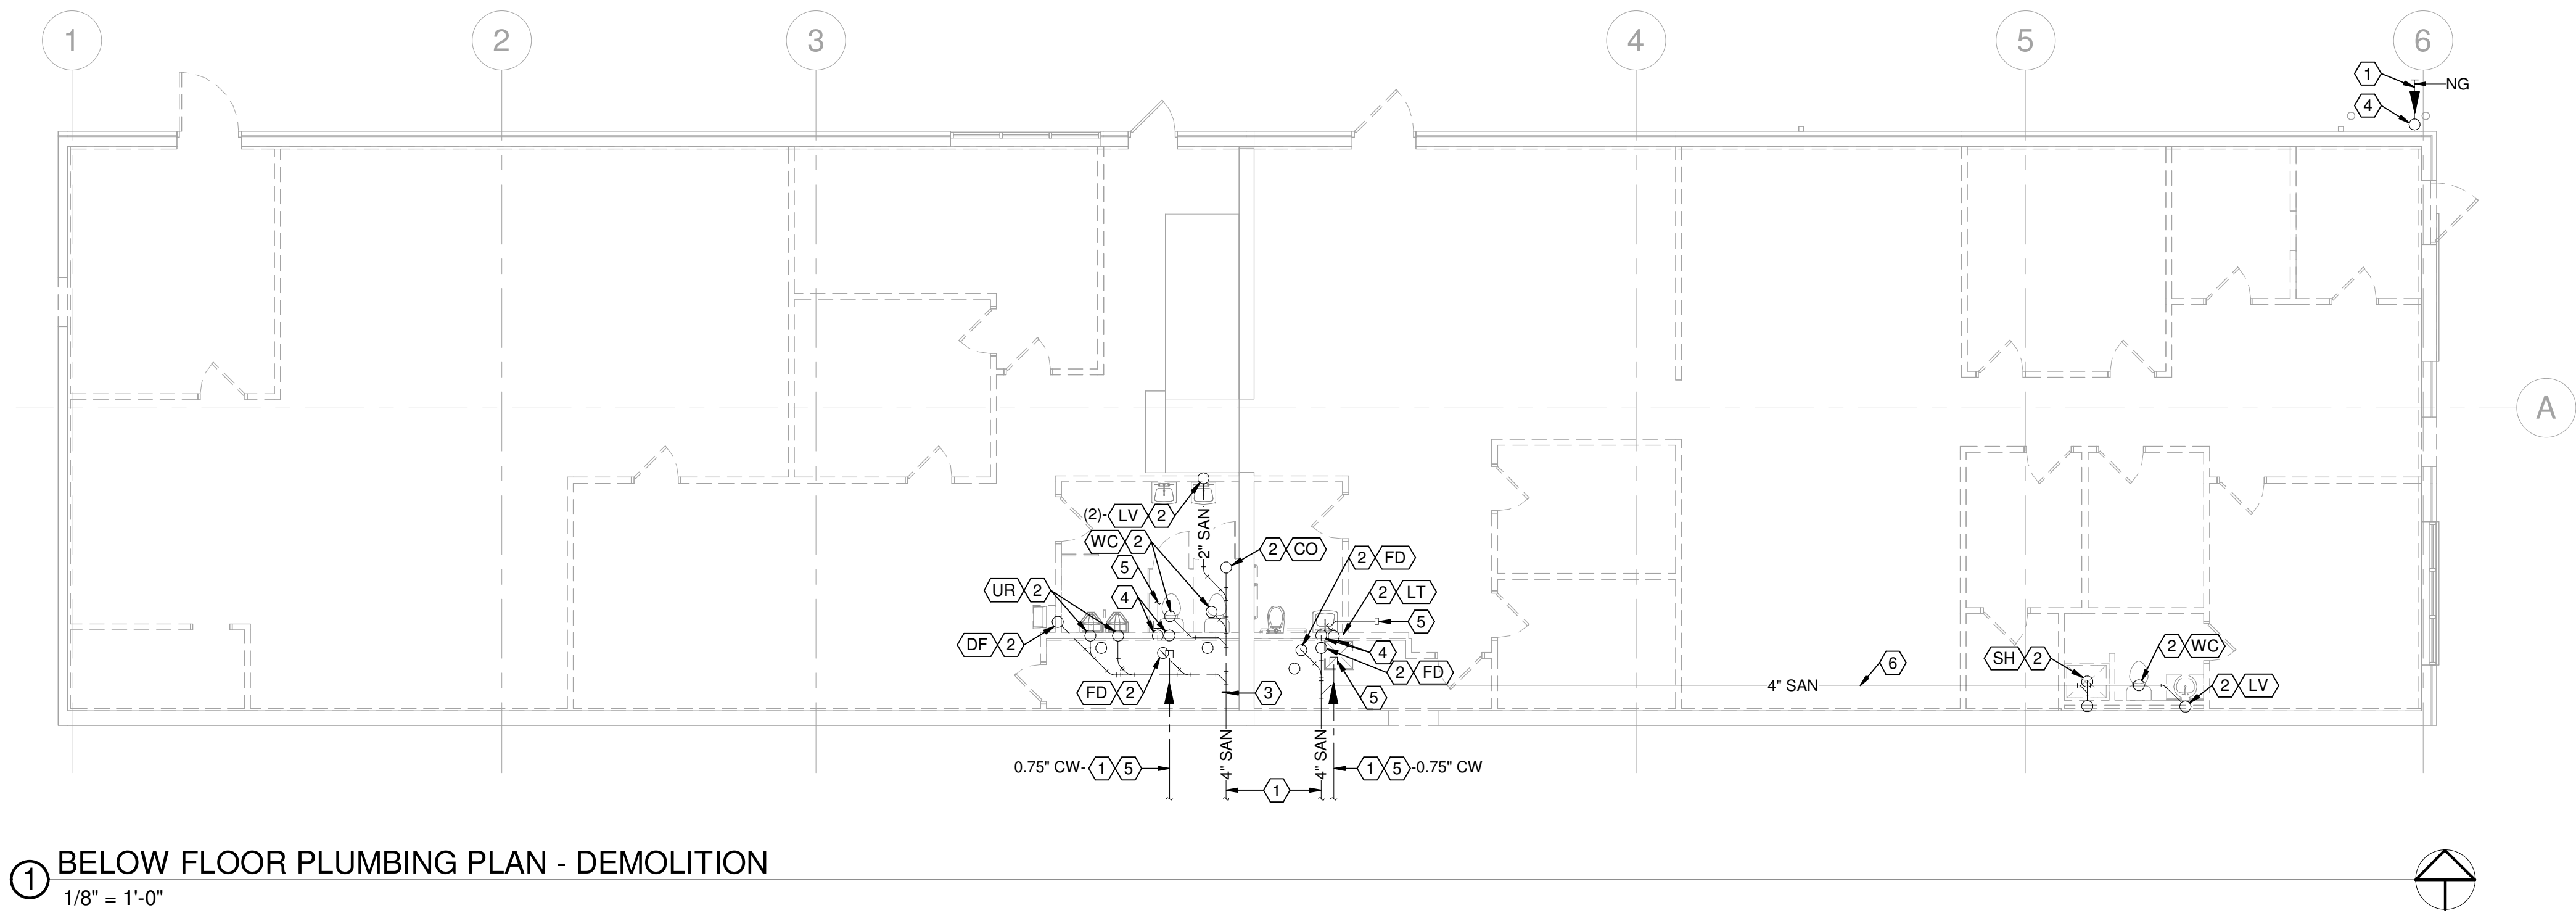
- EXISTING TO REMAIN.
- REMOVE EXISTING PLUMBING FIXTURE IN ITS ENTIRETY AND CAP SANITARY PIPING BELOW GRADE AND PATCH AND REPAIR CONCRETE FLOOR TO SMOOTH FINISH. REFER TO ARCHITECTURAL DRAWINGS FOR FLOOR FINISH AND TO PLUMBING SPECIFICATION NOTE 'E' ON SHEET P0.1 FOR ADDITIONAL INFORMATION.
- POINT OF CONNECTION IN NEW WORK.
- REFER TO SHEET P1.1 FOR CONTINUATION OF PIPING.
- EXISTING PIPING TO BE CAPPED ON BOTH ENDS AND ABANDONED BELOW GRADE.
- EXISTING SANITARY PIPING TO BE CAPPED ON EACH END BELOW FLOOR SLAB AND ABANDONED. PATCH AND REPAIR CONCRETE FLOOR TO SMOOTH FINISH. REFER TO ARCHITECTURAL DRAWINGS FOR FLOOR FINISH AND TO PLUMBING SPECIFICATION NOTE 'E' ON SHEET P0.1 FOR ADDITIONAL INFORMATION.

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TITLE	
PLUMBING BELOW FLOOR PLAN - DEMOLITION	
SHEET NO.	





1 PLUMBING PLAN - DEMOLITION  
1/8" = 1'-0"
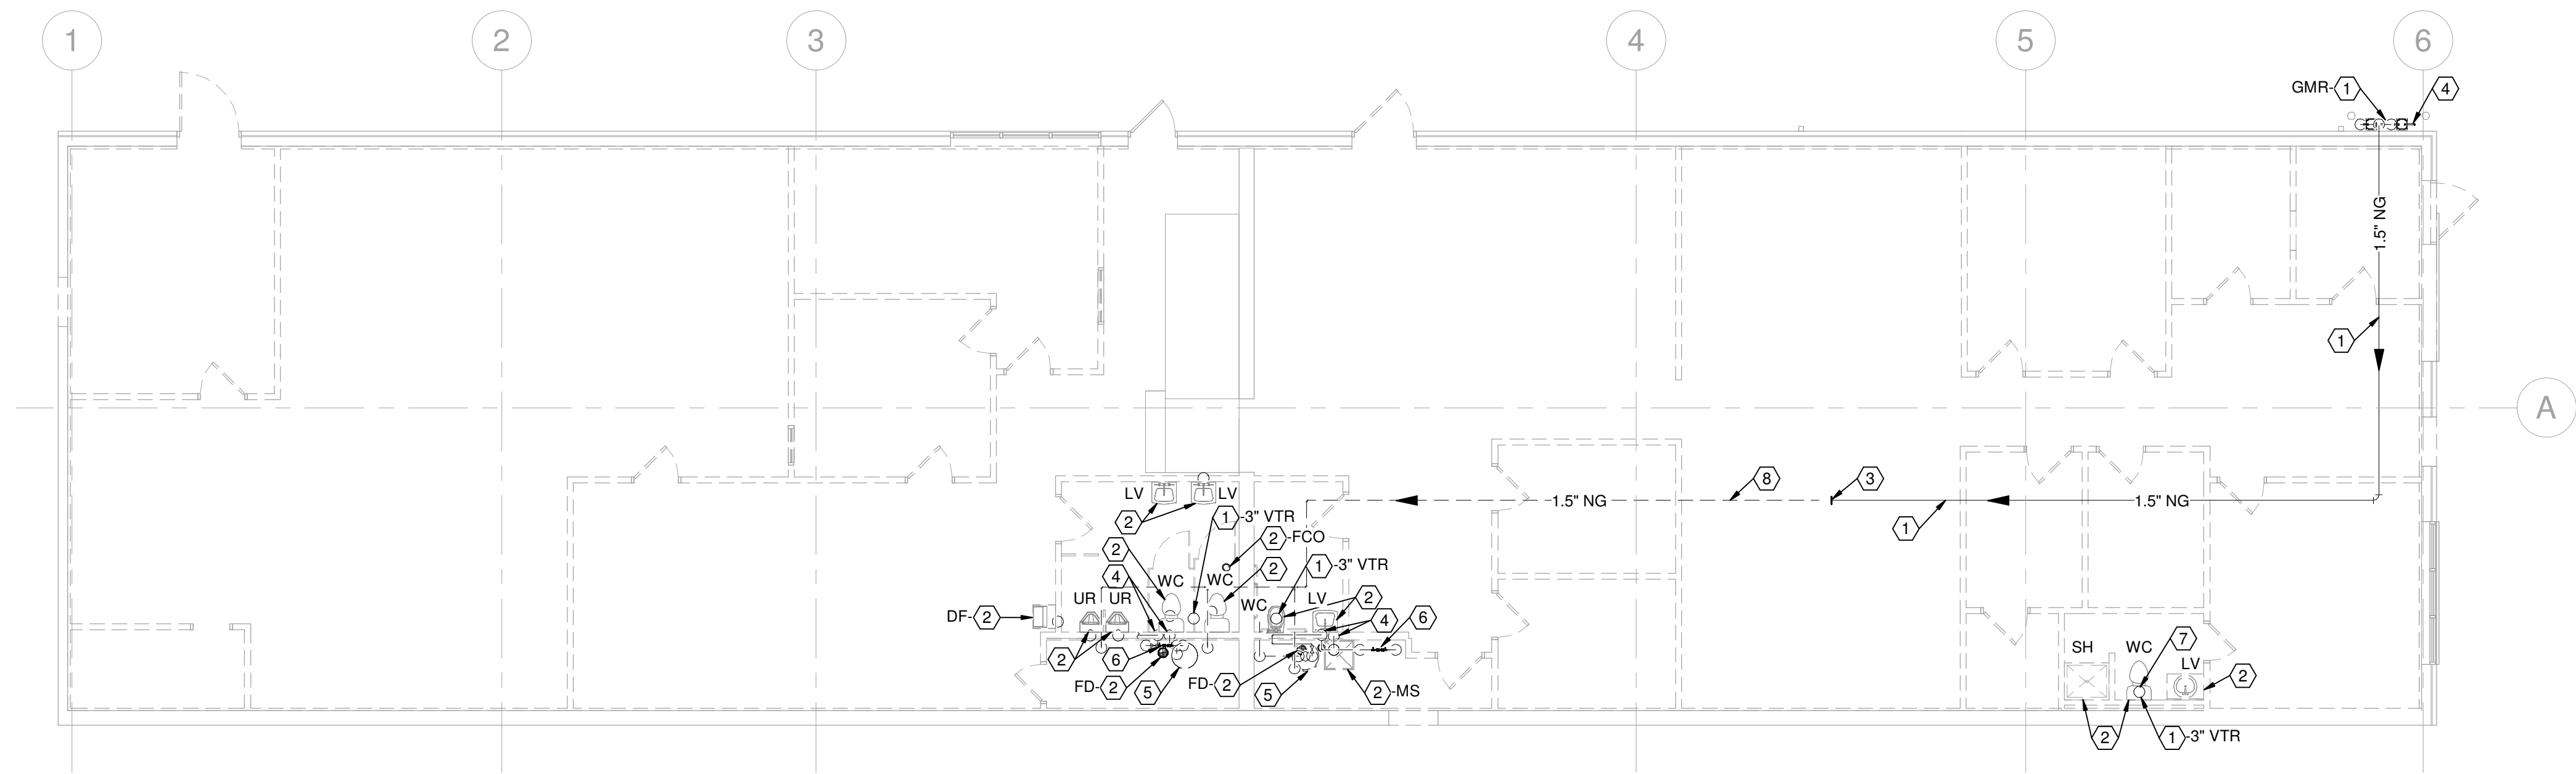
#### DRAWING NOTES

- EXISTING TO REMAIN.
- REMOVE EXISTING PLUMBING FIXTURE IN ITS ENTIRETY.
- POINT OF CONNECTION IN NEW WORK.
- REFER TO SHEET P1.0 FOR CONTINUATION OF PIPING.
- REMOVE EXISTING WATER HEATER IN ITS ENTIRETY.
- REMOVE EXISTING WATER SERVICE BACKFLOW PREVENTER AND ALL PIPING BACK TO POINT OF CONNECTION IN NEW WORK.
- EXISTING VENT THROUGH ROOF TO BE ABANDONED IN PLACE. CAP EXISTING VENT THROUGH ROOF PIPING ON BOTH ENDS.
- REMOVE EXISTING NATURAL GAS PIPING, HANGERS, ETC. BACK TO POINT OF CONNECTION IN NEW WORK.

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TITLE  
**PLUMBING FLOOR PLAN  
- DEMOLITION**

SHEET NO.

**P1.1**




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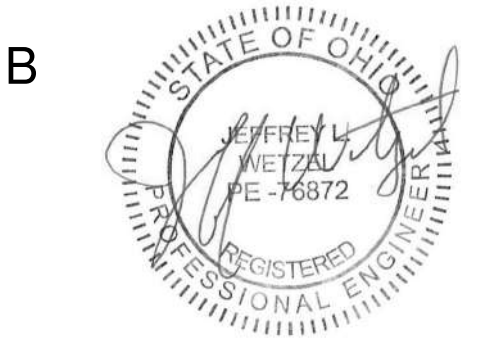
- A. THE PLUMBING BASE BID FOR THE WEST AREA SHALL INCLUDE ALL PLUMBING SCOPE SHOWN ON THIS SHEET.
- B. AS A DEDUCT ALTERNATE, CONTRACTOR SHALL PROVIDE THE COST REDUCTION TO SHELL THE WEST AREA SPACE. THIS INCLUDES NOT INSTALLING THE PLUMBING FIXTURES IN FULL, AND PROVIDING CAPPED STUBS ON THE SANITARY SYSTEM ABOVE THE FINISHED FLOOR. REFER TO SHEET P2.2 FOR ALTERNATE PLUMBING PLAN FOR FURTHER DETAILS.

DRAWING NOTES

- EXISTING TO REMAIN.
- REFER TO SHEET P2.1 FOR CONTINUATION OF PIPING.
- EXISTING WATER METER PIT, PROVIDE NEW 1.5" CONNECTION TO EXISTING WATER METER, COORDINATE WATER METER REQUIREMENTS WITH WATER UTILITY COMPANY.
- EXISTING WATER METER PIT TO BE ABANDONED IN PLACE. PROVIDE 0.75" CAP ON EXISTING WATER SERVICE ON DISCHARGE SIDE OF WATER METER AND ON EXISTING WATER SERVICE TO BUILDING. EXISTING WATER SERVICE PIPE TO BE ABANDONED IN PLACE.

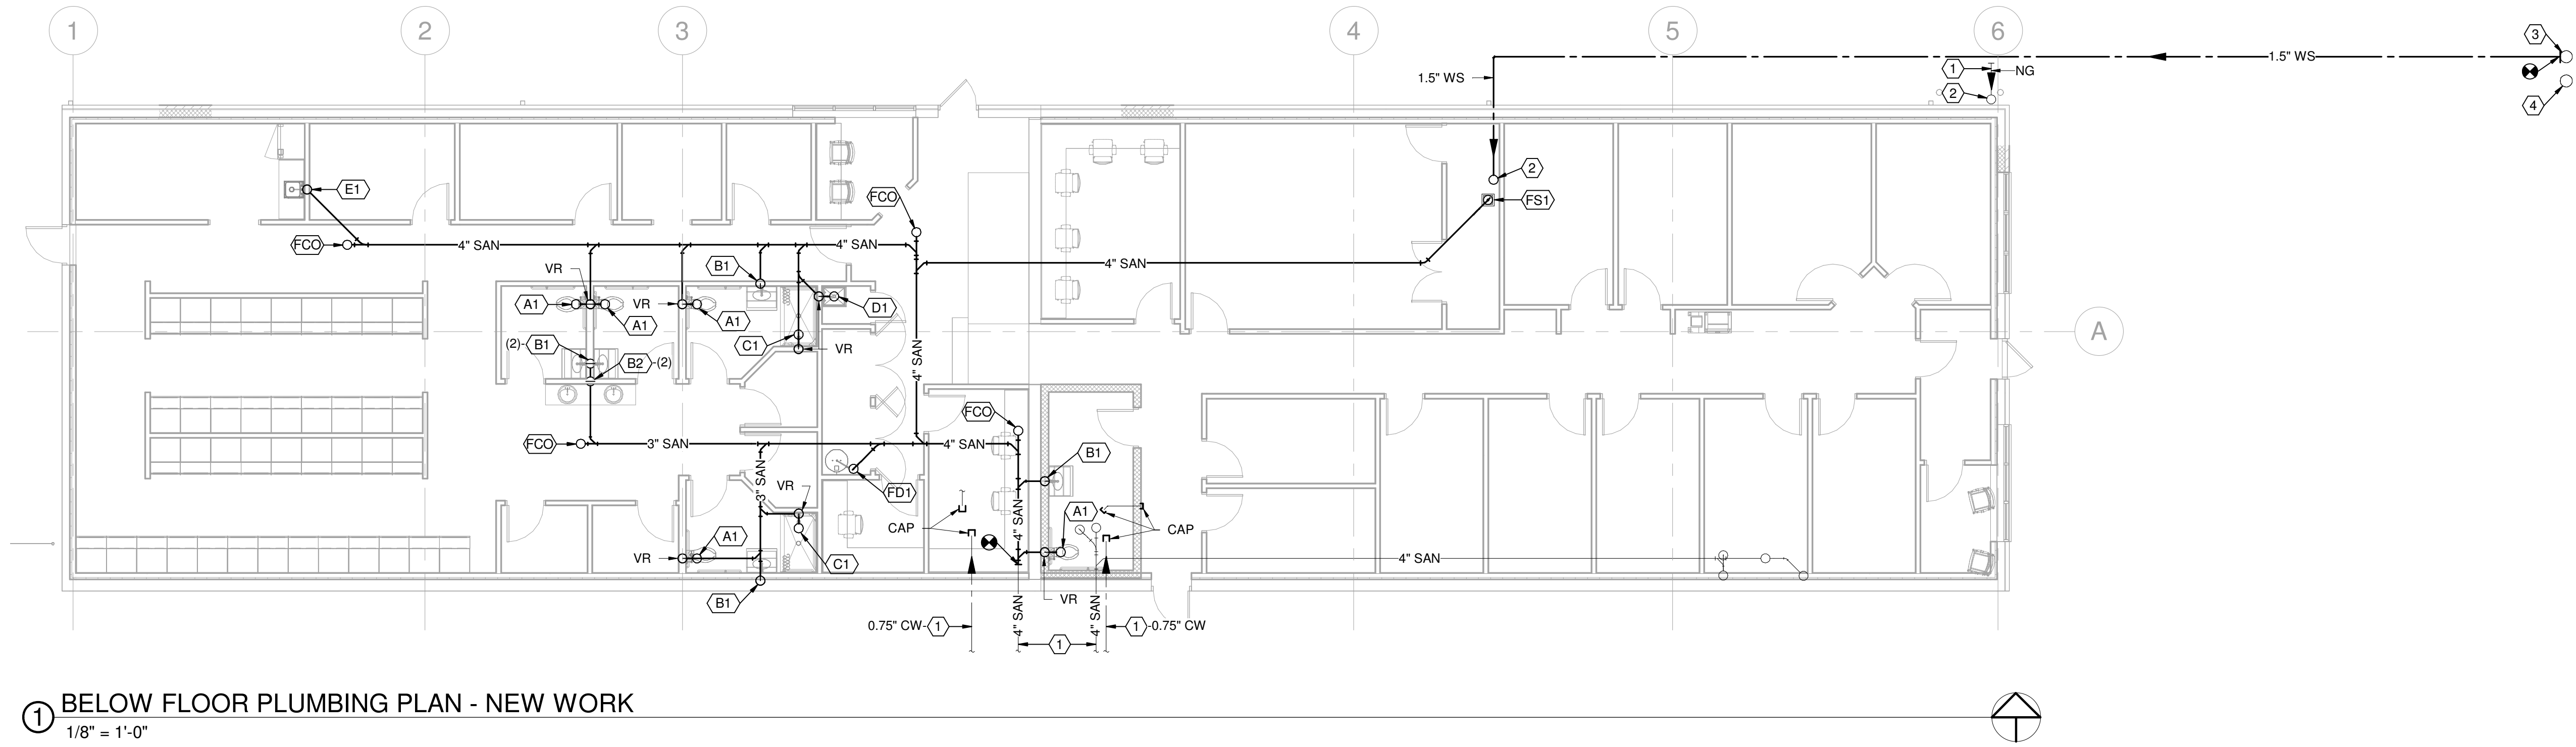

1 BELOW FLOOR PLUMBING PLAN - NEW WORK  
1/8" = 1'-0"



Harrison Township District 10  
Sheriff Substation Renovation

6001 N Dixie Dr, Dayton, OH 45414

ISSUE		
NO.	DATE	DESCRIPTION
01/22/2026 FOR CONSTRUCTION		

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TITLE PLUMBING BELOW FLOOR PLAN - NEW WORK	
SHEET NO.	

P2.0




BASE BID DESCRIPTION

- A. THE PLUMBING BASE BID FOR THE WEST AREA SHALL INCLUDE ALL PLUMBING SCOPE SHOWN ON THIS SHEET.
- B. AS A DEDUCT ALTERNATE, CONTRACTOR SHALL PROVIDE THE COST REDUCTION TO SHELL THE WEST AREA SPACE. THIS INCLUDES NOT INSTALLING THE PLUMBING FIXTURES, ABOVE FLOOR SANITARY WASTE AND VENT PIPING AND COLD AND HOT WATER SUPPLY PIPING, AND PROVIDING CAPPED STUBS ON THE SANITARY SYSTEM ABOVE THE FINISHED FLOOR. REFER TO SHEET P2.3 FOR ALTERNATE PLUMBING PLAN FOR FURTHER DETAILS.

DRAWING NOTES

- EXISTING TO REMAIN.
- REFER TO SHEET P2.0 FOR CONTINUATION OF PIPING.
- ROUTE 0.5" DOMESTIC HOT WATER PIPING DOWN IN WALL AND SERVE BOTH "B1 AND / OR B2" FIXTURES.
- ROUTE 0.5" DOMESTIC COLD WATER PIPING DOWN IN WALL AND SERVE BOTH "B1" AND / OR "B2" FIXTURES.

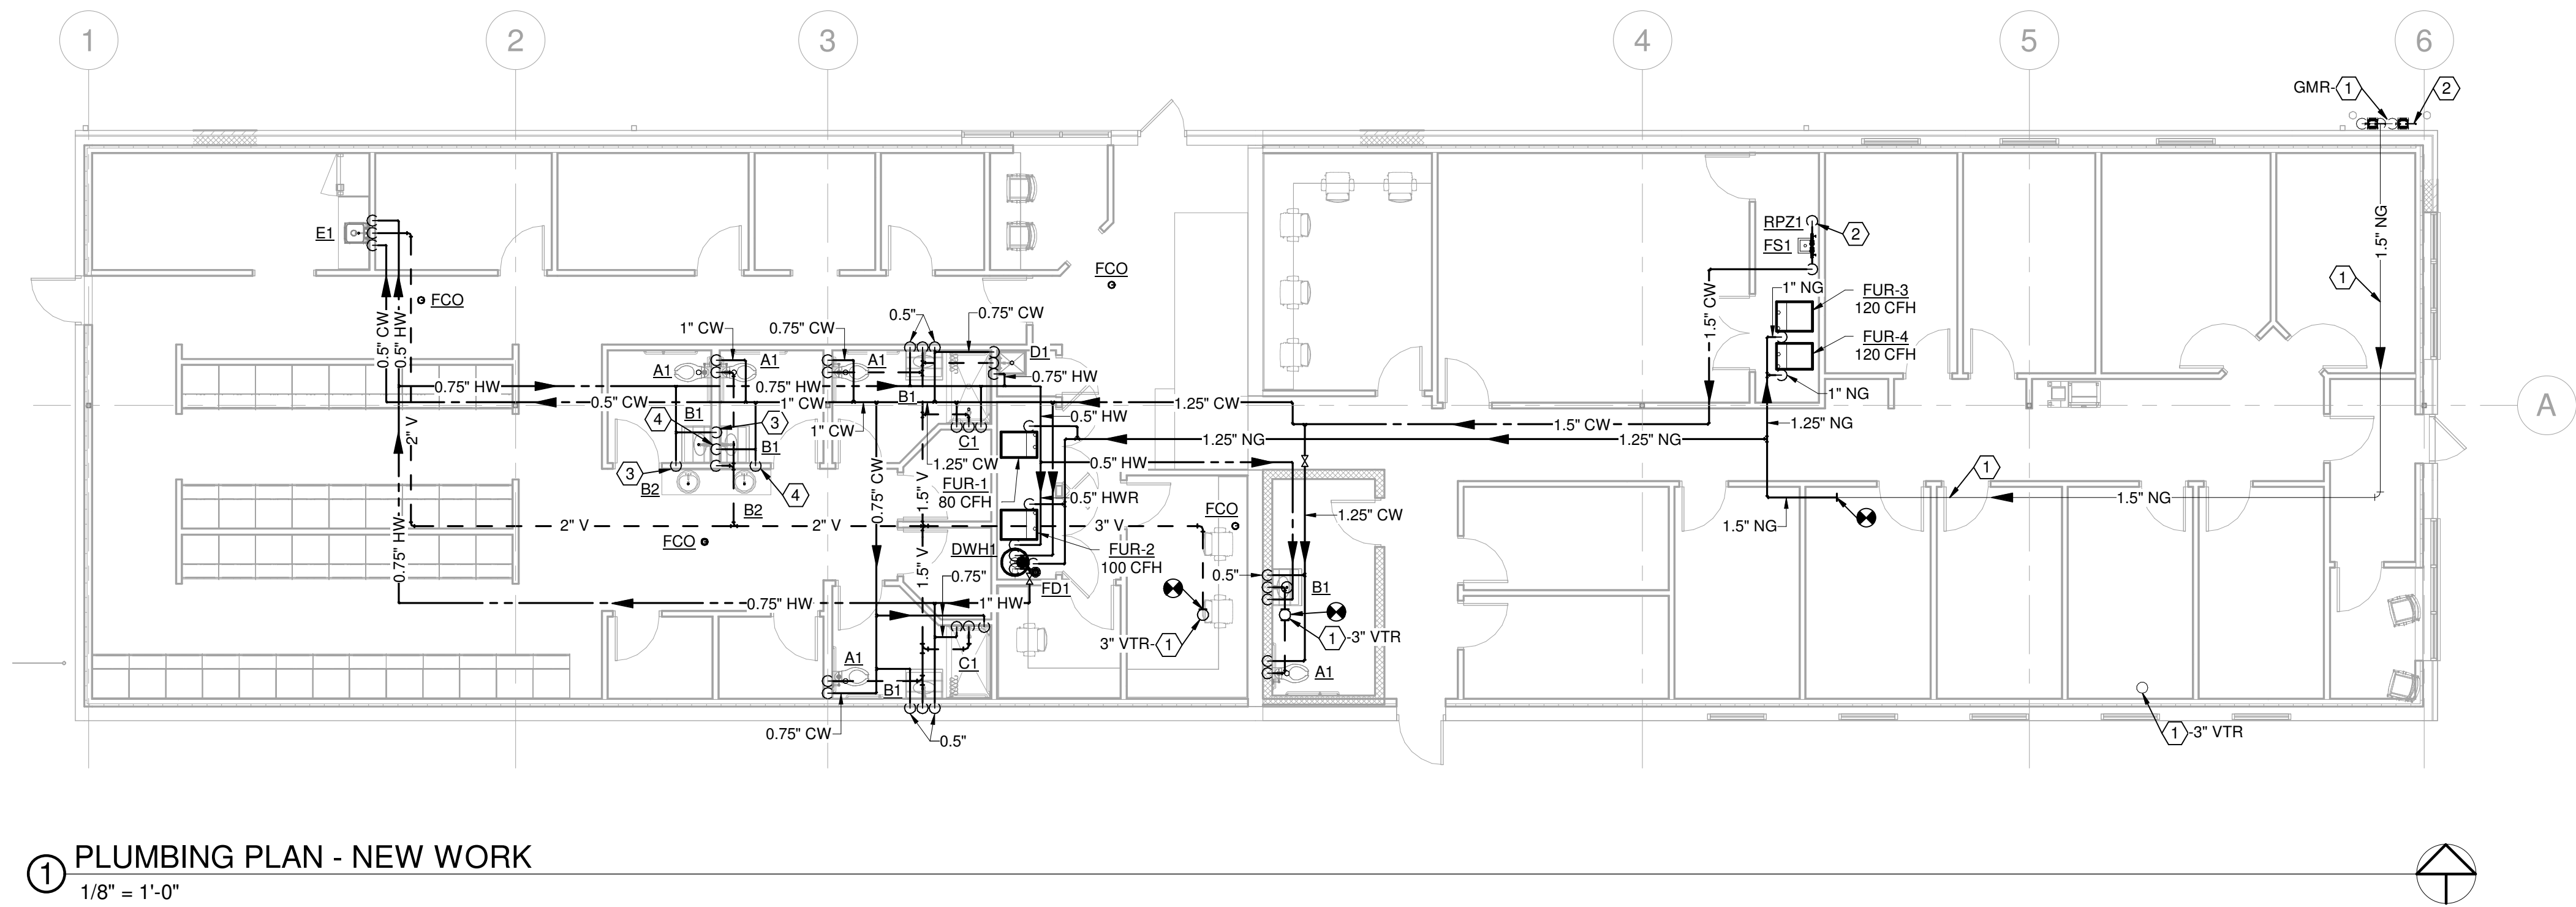

1 PLUMBING PLAN - NEW WORK  
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P2.1




ALTERNATE DESCRIPTION

- A. AS A DEDUCT ALTERNATE, CONTRACTOR SHALL PROVIDE THE COST REDUCTION TO REDUCE THE BASE BID PLUMBING DESIGN FOR THE WEST AREA TO ONLY AS SHOWN ON THIS PLAN. THIS INCLUDES NOT INSTALLING THE PLUMBING FIXTURES IN FULL, AND PROVIDING CAPPED STUBS ON THE SANITARY SYSTEM ABOVE THE FINISHED FLOOR.
- B. REFER TO SHEET P2.0 FOR THE BASE BID PLUMBING SCOPE OF WORK.

DRAWING NOTES

1. EXISTING TO REMAIN.
2. REFER TO SHEET P2.1 FOR CONTINUATION OF PIPING.
3. EXISTING WATER METER PIT, PROVIDE NEW 1.5" CONNECTION TO EXISTING WATER METER, COORDINATE WATER METER REQUIREMENTS WITH WATER UTILITY COMPANY.
4. EXISTING WATER METER PIT TO BE ABANDONED IN PLACE, PROVIDE 0.75" CAP ON EXISTING WATER SERVICE ON DISCHARGE SIDE OF WATER METER AND ON EXISTING WATER SERVICE TO BUILDING. EXISTING WATER SERVICE PIPE TO BE ABANDONED IN PLACE.

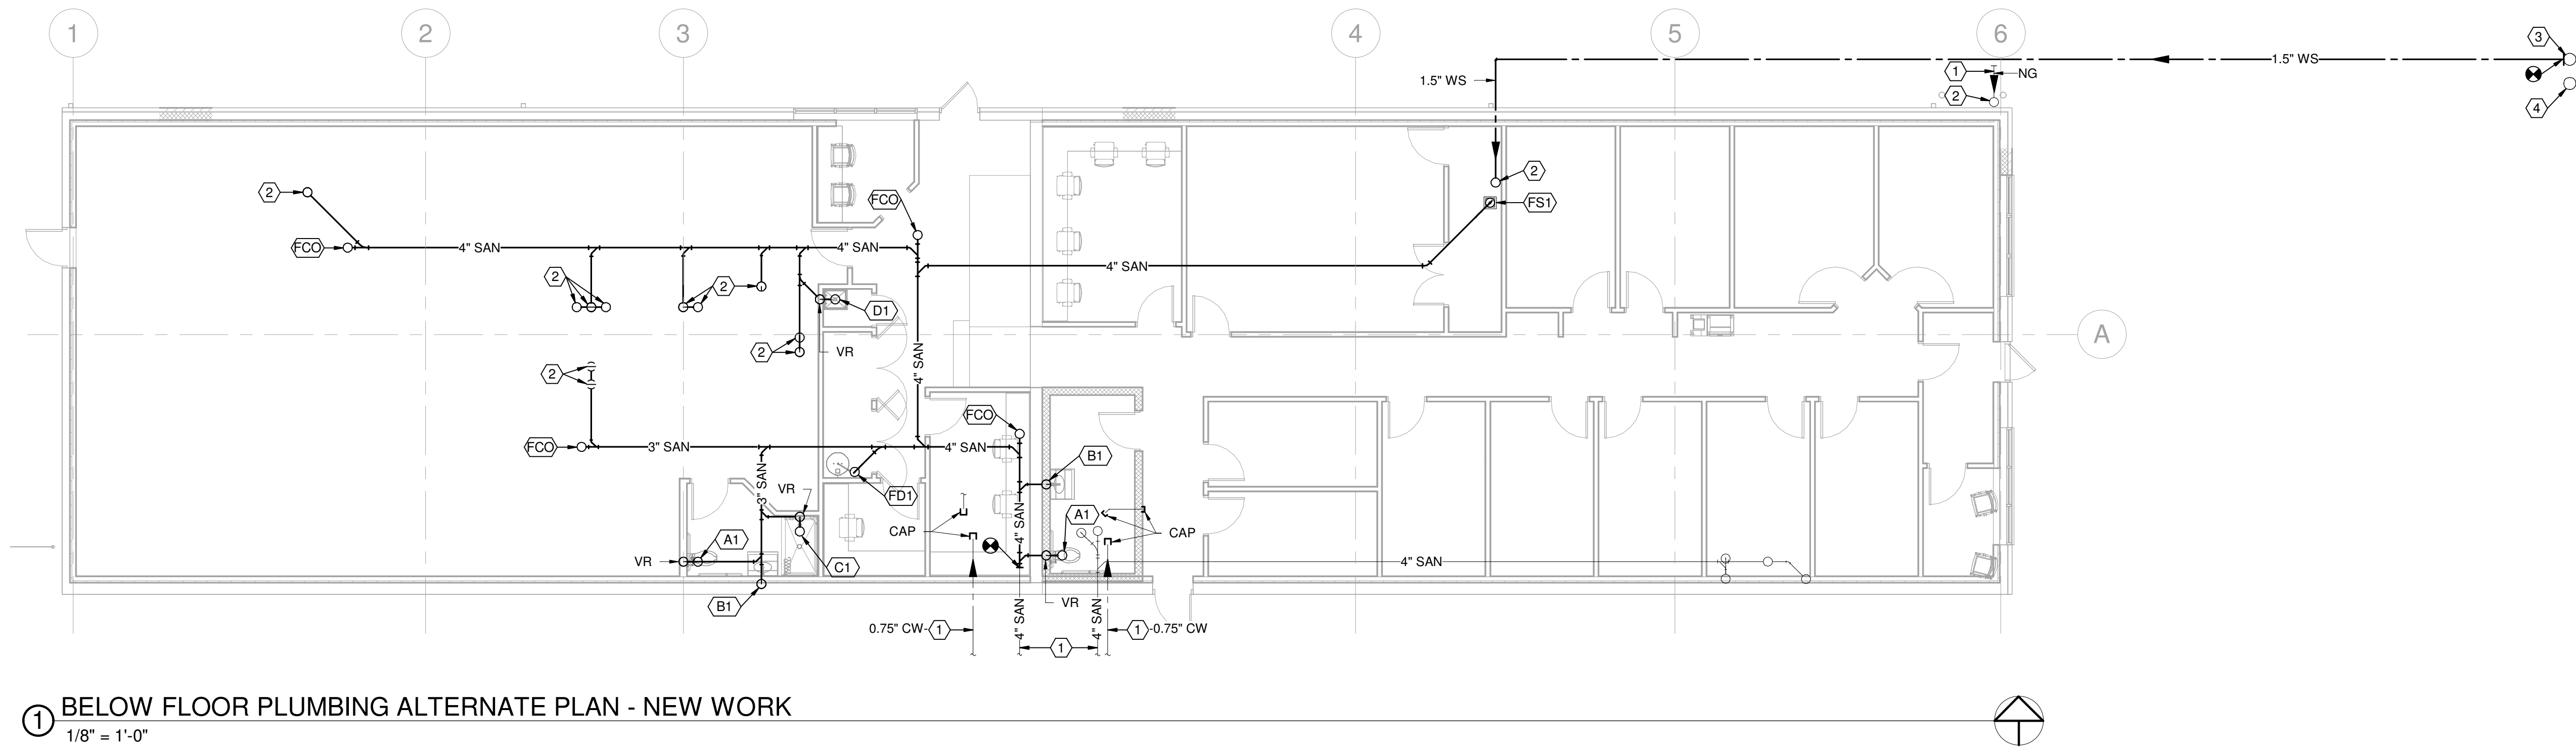

1 BELOW FLOOR PLUMBING ALTERNATE PLAN - NEW WORK  
1/8" = 1'-0"

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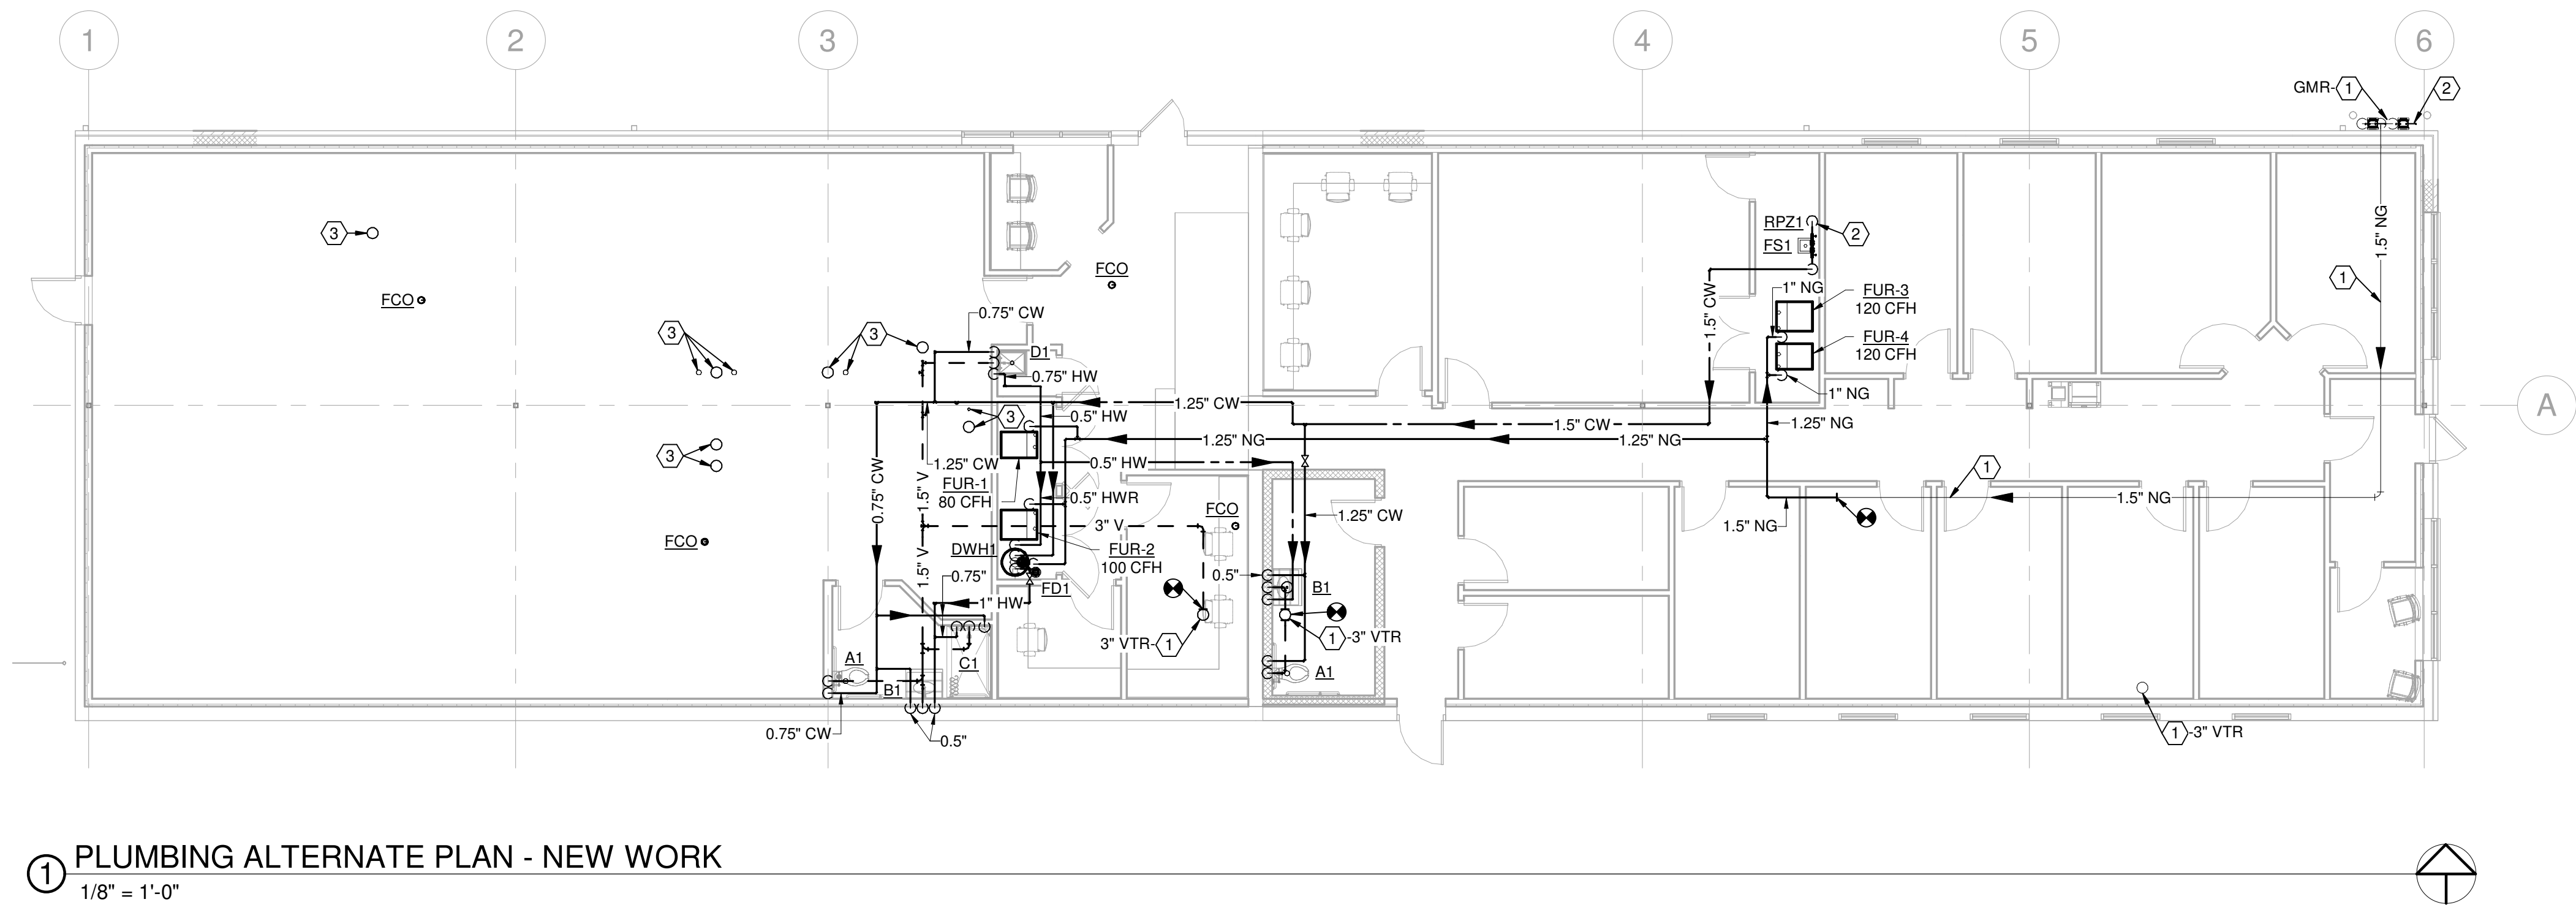
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SHEET NO.	



ALTERNATE DESCRIPTION

- A. AS A DEDUCT ALTERNATE, CONTRACTOR SHALL PROVIDE THE COST REDUCTION TO REDUCE THE BASE BID PLUMBING DESIGN FOR THE WEST AREA TO ONLY AS SHOWN ON THIS PLAN. THIS INCLUDES NOT INSTALLING THE PLUMBING FIXTURES, ABOVE FLOOR SANITARY WASTE AND VENT PIPING, AND COLD AND HOT WATER SUPPLY PIPING.
- B. REFER TO SHEET P2.1 FOR THE BASE BID PLUMBING SCOPE OF WORK.


- DRAWING NOTES
- EXISTING TO REMAIN.
  - REFER TO SHEET P2.0 FOR CONTINUATION OF PIPING.
  - CAP PIPE APPROXIMATELY 6" ABOVE FINISHED FLOOR.



1 PLUMBING ALTERNATE PLAN - NEW WORK  
1/8" = 1'-0"



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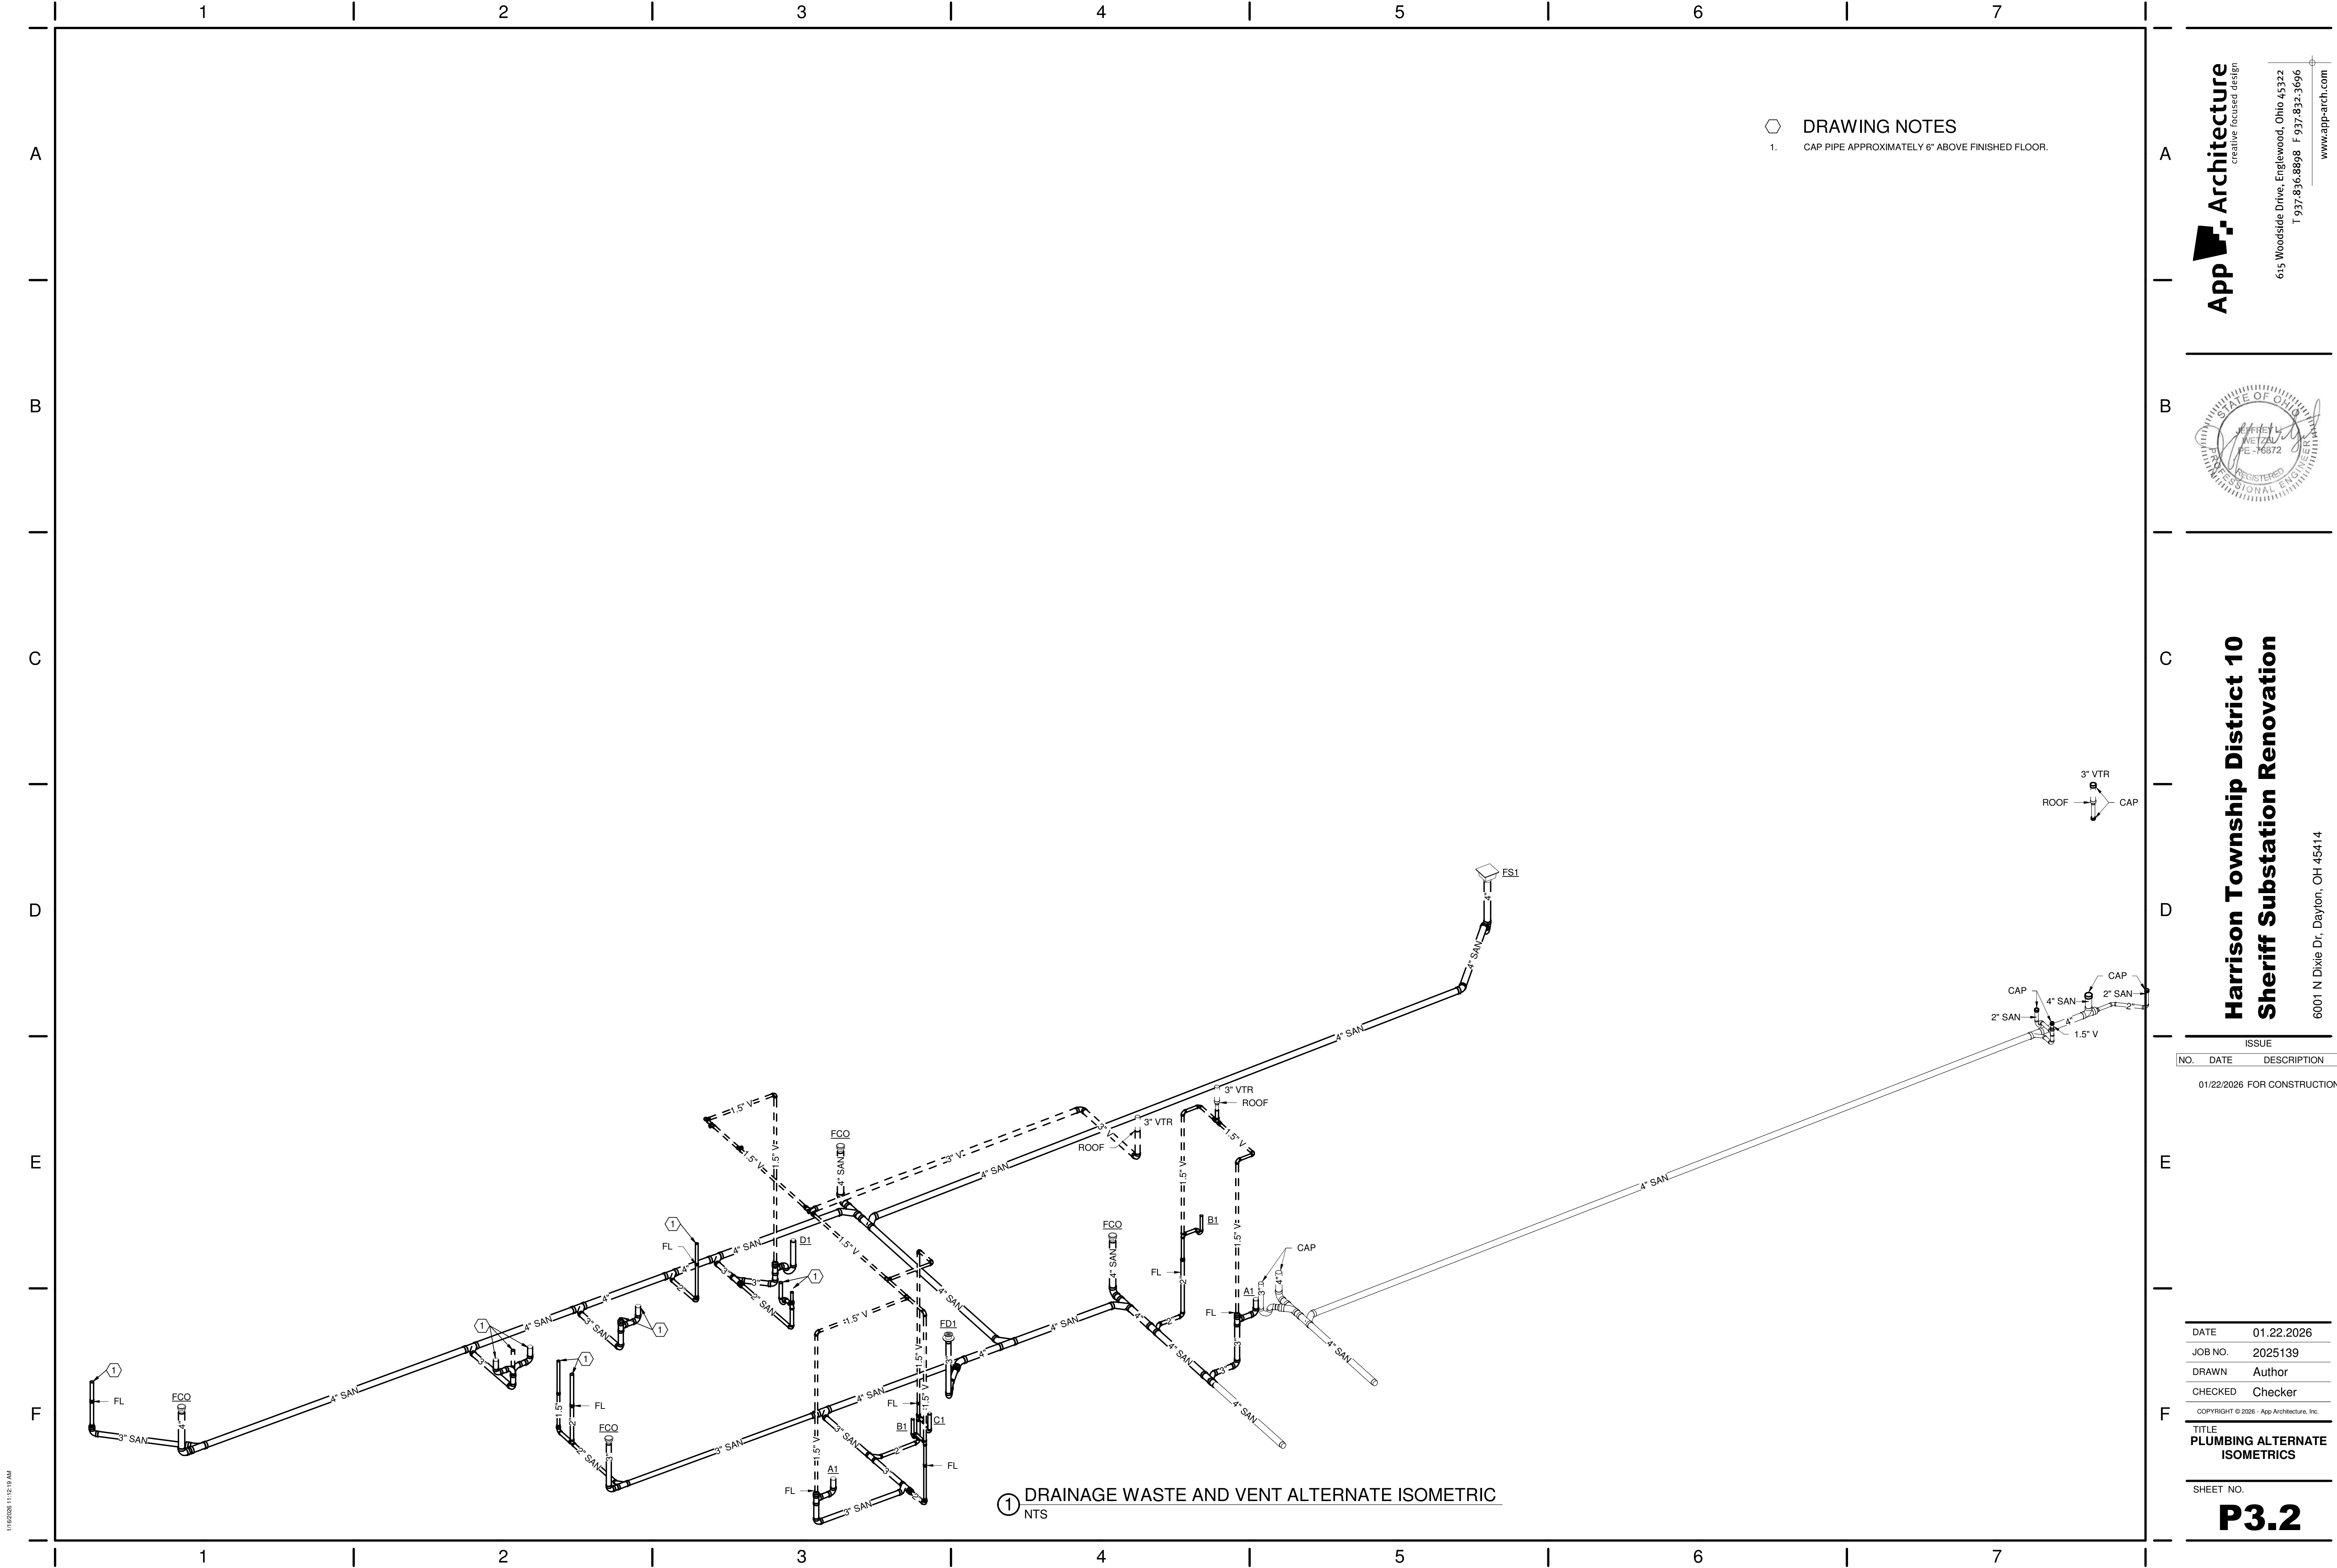
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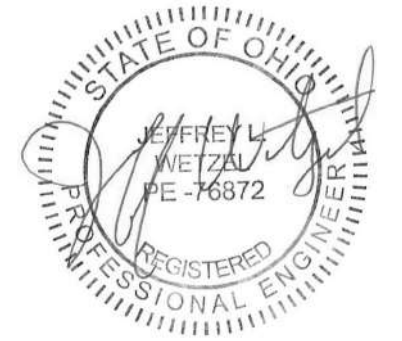
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**DRAWING NOTES**

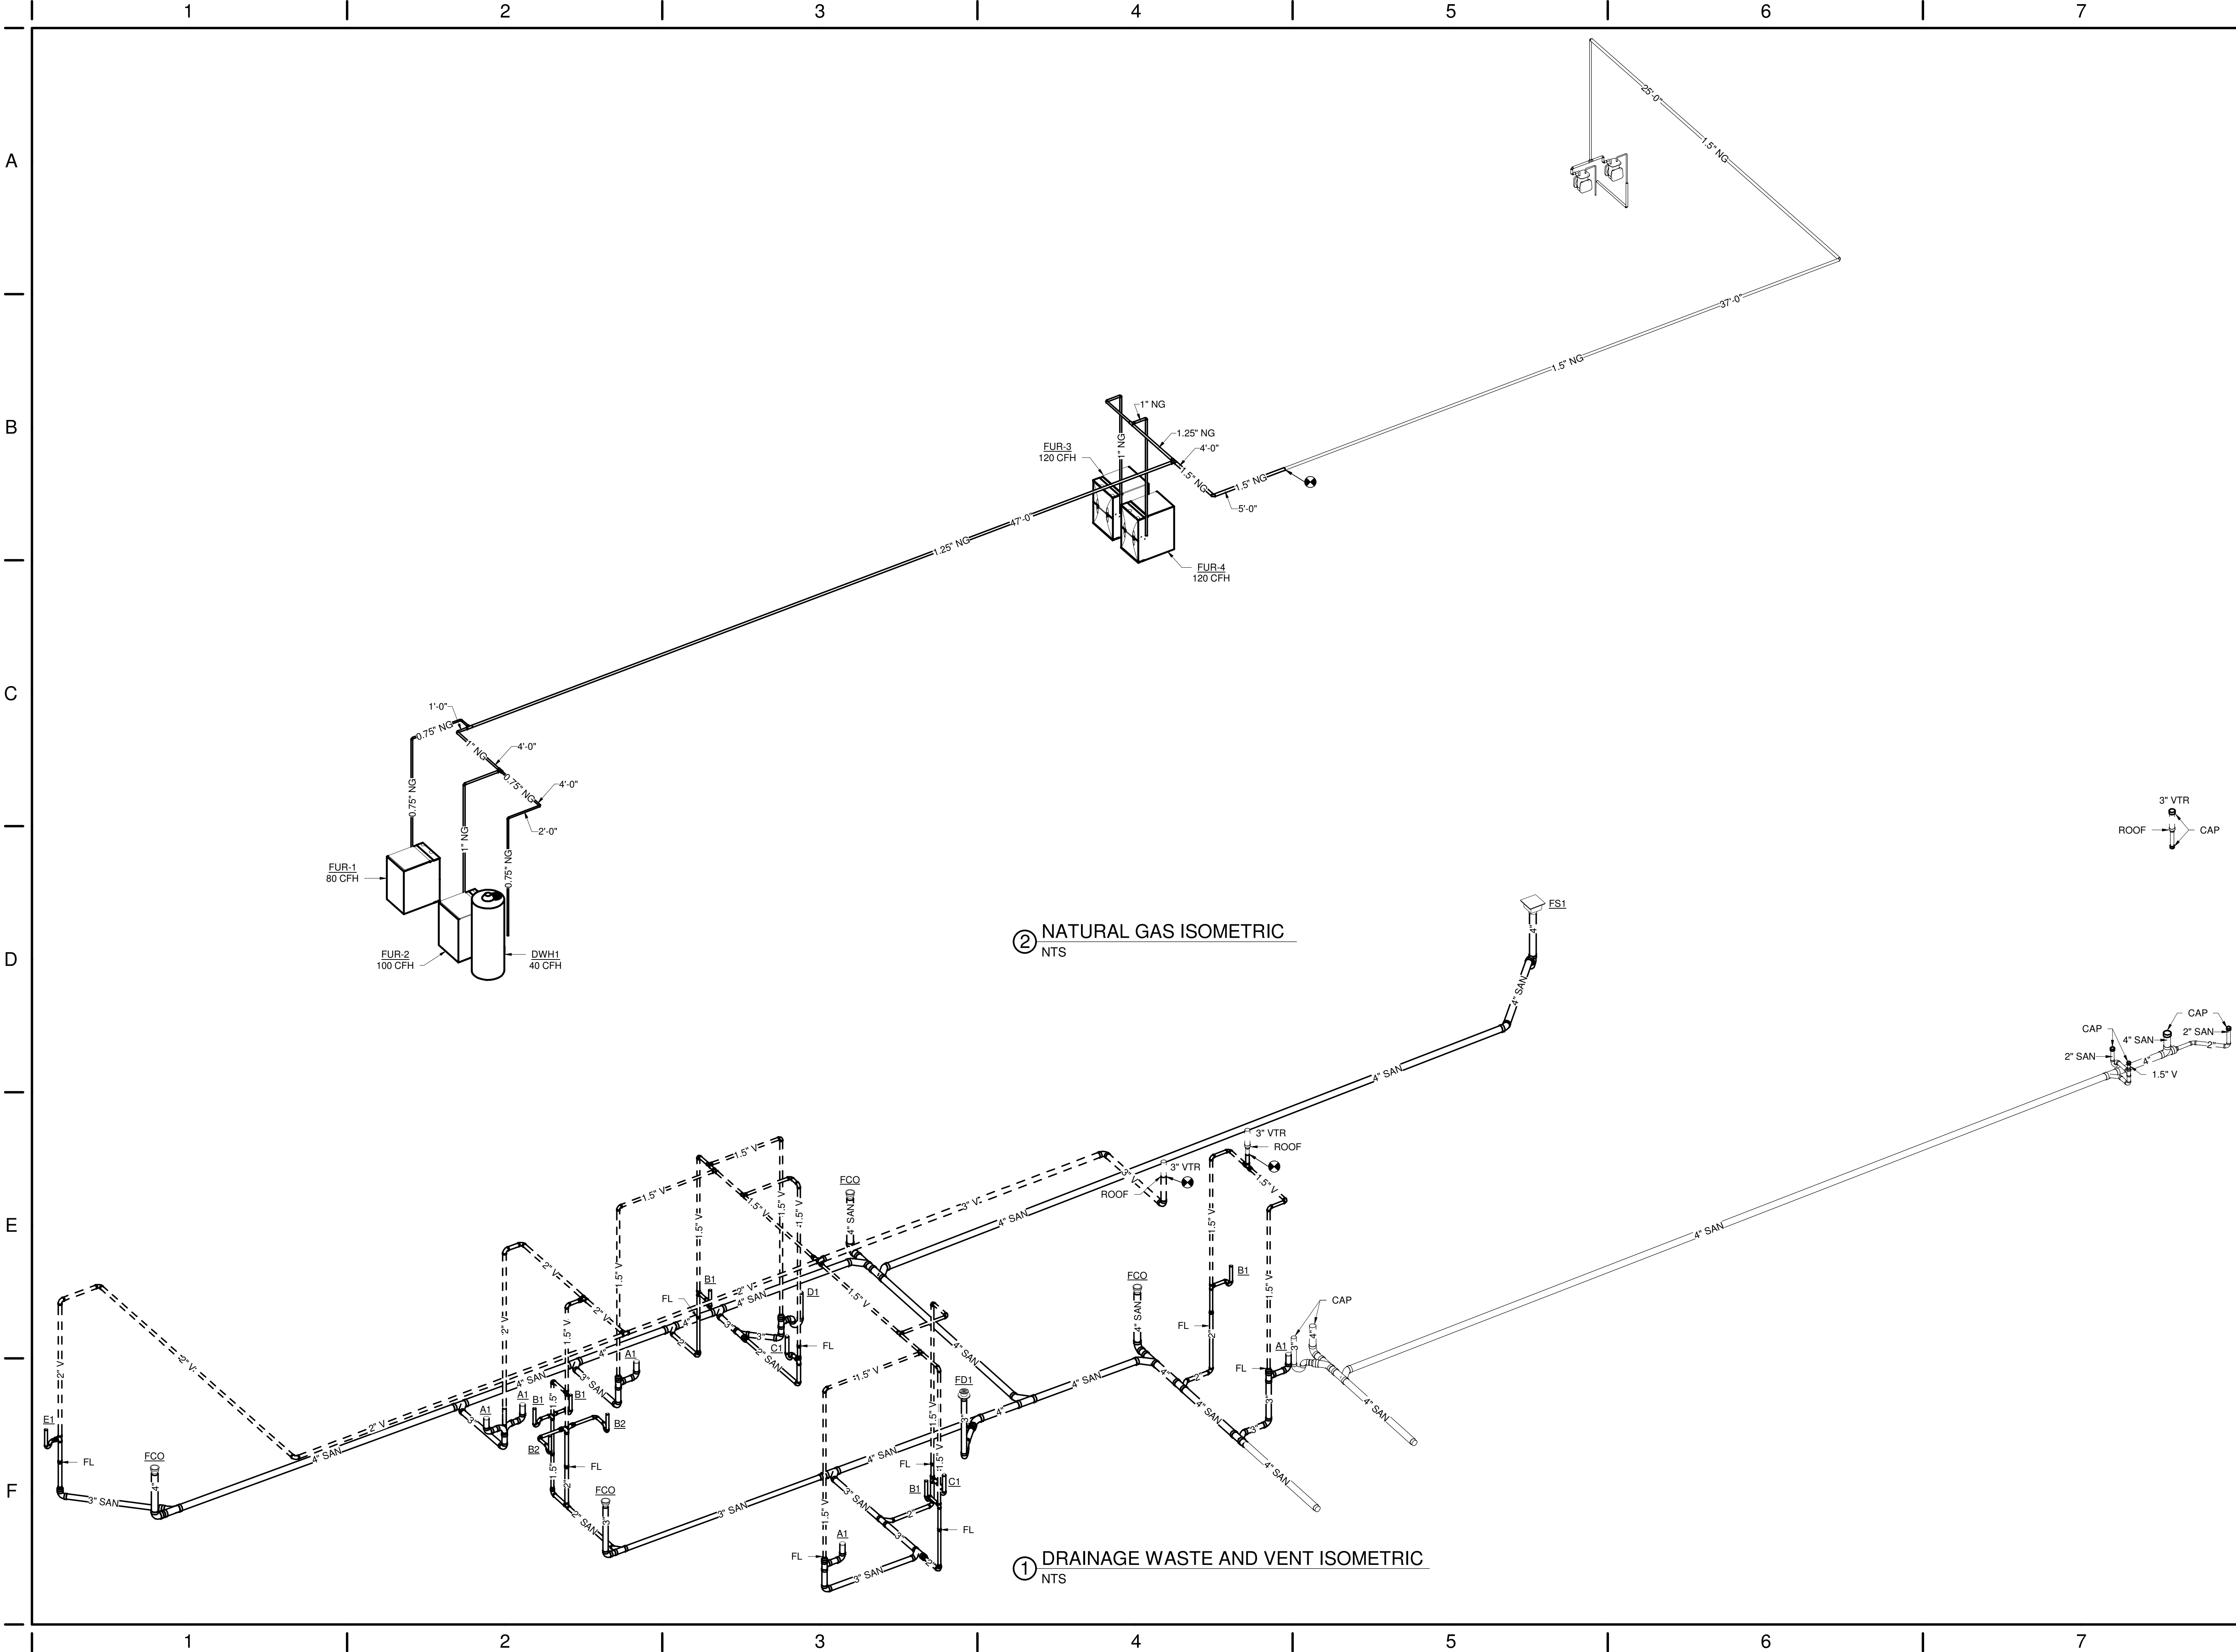1. CAP PIPE APPROXIMATELY 6" ABOVE FINISHED FLOOR.



**Harrison Township District 10  
Sheriff Substation Renovation**

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ISOMETRICS**

SHEET NO.  
**P3.2**



## GENERAL NOTES

- A. DO NOT SCALE DRAWINGS. IF DIMENSIONS CANNOT BE DETERMINED OR DOCUMENTS ARE IN CONFLICT (WITH THEMSELVES OR FIELD CONDITIONS), THE CONTRACTOR MUST OBTAIN CLARIFICATION FROM THE ARCHITECT PRIOR TO CONTINUATION OF WORK.
- B. CONTRACTOR(S) SHALL VISIT THE SITE TO ACQUAINT THEMSELVES WITH THE EXISTING OR NEWLY INSTALLED CONDITIONS. CONTRACTOR(S) SHALL FIELD VERIFY ALL DIMENSIONS, ELEVATIONS, UTILITIES, AND EXISTING OR NEWLY INSTALLED CONDITIONS PRIOR TO CONSTRUCTION.
- C. THE CONSTRUCTION DOCUMENTS AND DRAWING NOTES / SPECIFICATIONS ARE INTENDED TO DESCRIBE AND PROVIDE FOR A FINISHED PIECE OF WORK. THE WORK SHALL BE COMPLETED IN EVERY DETAIL EVEN THOUGH EVERY ITEM NECESSARILY INVOLVED IS NOT PARTICULARLY MENTIONED OR SPECIFIED. ALL WORK SHALL BE INSTALLED AS SHOWN ON THE DRAWINGS AND / OR MANUFACTURER'S SPECIFICATIONS AND INSTALLATION INSTRUCTIONS. IF ANY CONTRACTOR IS IN DOUBT AS TO THE TRUE MEANING OF ANY PART OF THE DOCUMENTS, OR FINDS DISCREPANCIES IN OR OMISSIONS FROM ANY PART OF THE DOCUMENTS, HE MUST CONTACT THE ARCHITECT FOR CLARIFICATION.
- D. ALL DIMENSIONS ARE TO FACE OF STUD, CONCRETE, MASONRY, OR CENTERLINE OF COLUMN, UNLESS NOTED OTHERWISE. WHEN EXISTING CONDITIONS ARE SHOWN, DIMENSIONS ARE TO FACE OF EXISTING FINISH, UNLESS NOTED OTHERWISE
- E. FINISH FLOOR ELEVATIONS ARE FOR GENERAL REFERENCE. REFER TO CIVIL SHEETS FOR ACTUAL FINISH FLOOR ELEVATIONS.
- F. EQUIPMENT AND FURNITURE SHOWN IS FOR REFERENCE ONLY. EQUIPMENT AND FURNITURE PROVIDED BY OWNER (UNLESS NOTED OTHERWISE) COORDINATE EQUIPMENT AND FURNITURE INSTALLATION AND UTILITY CONNECTIONS WITH OWNER AND OWNER'S SUPPLIER.
- G. **DEFINITIONS:**  
**NECESSARY:** WORK NEEDED TO COMPLETE THE WORK TO "MAKE IT OPERATIONAL".

**REQUIRED:** WORK NEEDED TO BE IN COMPLIANCE WITH BUILDING CODE, GOVERNING CODE, OR JURISDICTION HAVING AUTHORITY.

**PROVIDE:** RESPONSIBLE FOR PURCHASE, DELIVERY, RECEIVING, INSPECTION, STORAGE, PREPARATION, AND INSTALLATION OF ITEM(S).

**FURNISH:** RESPONSIBLE FOR PURCHASE AND DELIVERY OF ITEM(S).

**INSTALL:** RESPONSIBLE FOR RECEIVING, INSPECTION, STORAGE, PREPARATION, AND INSTALLATION OF ITEM(S).

**BASIS OF DESIGN:** AN ACCEPTABLE MANUFACTURER OR PRODUCT, DESIGNATED BY THE DESIGN PROFESSIONAL, WHICH EXHIBITS THE INTENDED STANDARDS AND DESIGN CRITERIA THAT MUST BE MET FOR PERFORMANCE. THE ITEM(S) INDICATED MAY BE PROVIDED OR AN ITEM OF EQUIVALENT APPEARANCE, AESTHETIC, QUALITY, MATERIAL, CONSTRUCTION, AND PERFORMANCE MAY BE SUBSTITUTED SUBJECT TO THE ARCHITECT'S OR DESIGN PROFESSIONAL'S APPROVAL. (REFER TO THE "SUBSTITUTIONS" SPECIFICATION FOR ADDITIONAL INFORMATION)

**OR EQUAL:** MAY FOLLOW A "BASIS OF DESIGN" OR OTHER SPECIFIED MANUFACTURER OR PRODUCT AND INDICATES THAT AN ITEM OF EQUIVALENT APPEARANCE, AESTHETIC, QUALITY, MATERIAL, CONSTRUCTION, AND PERFORMANCE MAY BE SUBSTITUTED SUBJECT TO THE ARCHITECT'S OR DESIGN PROFESSIONAL'S APPROVAL. (REFER TO THE "SUBSTITUTIONS" SPECIFICATION FOR ADDITIONAL INFORMATION)

## HVAC GENERAL SPECIFICATIONS

- A. UPON COMPLETION OF ALL HVAC WORK, THE CONTRACTOR SHALL SUBMIT (2) COPIES OF THE MANUFACTURER'S OPERATION AND MAINTENANCE MANUALS FOR ALL EQUIPMENT TO THE OWNER. THE CONTRACTOR SHALL PROVIDE TO THE ARCHITECT A COMPLETE SET OF RECORD DRAWINGS WITH ANY AND ALL CHANGES OR MODIFICATIONS TO THE DESIGN, CONSTRUCTION, SYSTEMS, OR EQUIPMENT CLEARLY INDICATED; SHOP DRAWINGS; INFORMATION ON THE THERMOSTATS, CONTROL WIRING DIAGRAMS, AND OTHER PERTINENT INFORMATION.
- B. **HVAC EQUIPMENT:** ALL EQUIPMENT SHALL BE COMPLETE IN EVERY RESPECT WITH ALL DEVICES, APPURTENANCES, AND ACCESSORIES PROVIDED TO MEET THE DESIGN INTENT AND OPERATION OF THE SYSTEMS SHOWN ON THE DRAWINGS AND SPECIFIED HEREIN. EQUIPMENT SHALL BE INSTALLED IN STRICT ACCORDANCE WITH THE MANUFACTURER'S INSTRUCTIONS. ALL AIR CONDITIONING EQUIPMENT MUST HAVE A CONDENSATE DRAIN AND BE TRAPPED IN ACCORDANCE WITH MANUFACTURER'S DATA. ALL COMPRESSORS ARE TO INCLUDE A 5-YEAR EXTENDED WARRANTY.
- C. **REFRIGERANT LINE SET:** HVAC CONTRACTOR TO SIZE REFRIGERANT LINE SET SIZES PER MANUFACTURER'S RECOMMENDATIONS AND FIELD CONDITIONS. LINES EXCEEDING 150 FEET IN LENGTH REQUIRE A PUMP (SIZED AND PROVIDED BY THE HVAC CONTRACTOR).
- D. **NOISE AND VIBRATION:** MECHANICAL AND ELECTRICAL EQUIPMENT IS TO OPERATE WITHOUT EXCESSIVE NOISE OR VIBRATION. ALL MOTOR OPERATED OR ROTATING EQUIPMENT IS TO BE VIBRATION ISOLATED OR FREE FROM ALL BEAMS, COLUMNS, FLOORS, CEILINGS, JOISTS, WALLS, AND OTHER PARTS OF THE BUILDING STRUCTURE. HANGER RODS FOR ALL PIPING, EQUIPMENT, AND DUCTWORK CONNECTED TO MOTOR OPERATED OR ROTATING EQUIPMENTS IS TO BE PROVIDED WITH KINETICALLY APPROVED EQUAL FIBERGLASS ISOLATOR HANGERS. PROVIDE FLEXIBLE COLLARS IN ALL CONNECTIONS BETWEEN VIBRATING EQUIPMENT (FANS, ROOFTOP UNITS, ETC.) AND DUCTS. THE FLEXIBLE CONNECTION IS TO BE RATED FOR THE OPERATING PRESSURE OF THE SYSTEM.
- E. **CURBS AND STEEL FRAMING FOR SUPPORT:** PROVIDE ALL NECESSARY CURBS AND STEEL FRAMING REQUIRED TO INSTALL ALL HVAC EQUIPMENT AS DESCRIBED OR IMPLIED ON THE DRAWINGS. CURBS SHALL BE OF THE SAME MANUFACTURER OF THE EQUIPMENT SUPPORTED. INSULATE UNDER THE COMPRESSOR SECTION TO PREVENT CONDENSATION. ALL CURBS MUST BE INSTALLED SO THAT TOP OF CURBS ARE LEVEL.
- F. **DUCTWORK:** DUCTWORK IS TO BE FABRICATED WITH GALVANIZED SHEET STEEL (NO FIBERGLASS ALLOWED) IN ACCORDANCE WITH SMACNA "HVAC DUCT CONSTRUCTION STANDARDS-METAL AND FLEXIBLE" AND NAIMA "FIBROUS GLASS DUCT CONSTRUCTION STANDARDS-LATEST EDITION". CONFORMING TO THE REQUIREMENTS IN THE REFERENCED STANDARD FOR METAL THICKNESS, REINFORCING TYPES AND INTERVALS, TIE ROD APPLICATIONS, AND JOINT TYPES AND INTERVALS. ALL JOINTS, SEAMS, AND CONNECTIONS MUST BE SECURELY FASTENED AND SEALED AIRTIGHT IN COMPLIANCE WITH THE INTERNATIONAL ENERGY CONSERVATION CODE AND OHIO MECHANICAL CODE.
- G. **BRANCH DUCTWORK:** ALL DUCT BRANCHES TO DIFFUSERS ARE TO BE RECTANGULAR OR ROUND RIGID DUCT. ALL BRANCH TAKEOFFS FROM RECTANGULAR MAINS TO BE CONNECTED TO SPIN COLLARS WITH SCOOPS AND QUADRANT DAMPERS.
- H. **FLEXIBLE DUCTWORK:** FLEX DUCTWORK IS TO BE NFPA 90 AND 90A APPROVED INDICATING NO VINYL, TESTED IN ACCORDANCE WITH UL 181, AND LISTED AND LABELED AS CLASS 0 OR CLASS 1 DUCT. NO FLEX DUCT RUN TO EXCEED **8'-0"**. **MAXIMUM** TOTAL LENGTH AT ANY ONE LOCATION. ALL FLEX CONNECTIONS TO BE TAPED AND STRAPPED PER MANUFACTURER'S INSTRUCTIONS.
- I. **DUCTWORK INSULATION:** INSTALL INSULATION PRODUCTS IN ACCORDANCE WITH THE MANUFACTURER'S WRITTEN INSTRUCTIONS AND IN ACCORDANCE WITH RECOGNIZED INDUSTRY PRACTICES. INSULATION MUST COMPLY WITH NFPA 90A. DUCT SIZES SHOWN ON DRAWINGS ARE INSIDE CLEAR DIMENSIONS. INSULATE DUCTWORK PER THE DUCT CONSTRUCTION SCHEDULE. PROVIDE DUCTWORK INSULATION WITHOUT INTERRUPTION THROUGH WALLS, FLOORS, AND SIMILAR PENETRATIONS. ALL INSULATION SHALL HAVE A FLAME SPREAD RATING OF NOT MORE THAN 25 AND A SMOKE DEVELOPED RATING OF NO HIGHER THAN 50 WHEN TESTED IN ACCORDANCE WITH ASTM C411, OR AS REQUIRED BY LOCAL CODES.
- J. WHERE ROUND DUCTWORK IS INDICATED ON PLANS, PROVIDE RECTANGULAR DUCTWORK, IF ROUND DUCTWORK CANNOT BE INSTALLED BECAUSE OF OBSTRUCTIONS, INSUFFICIENT CLEARANCES OR OTHER CAUSES DUE TO FIELD CONDITIONS. CONTRACTOR'S OPTION TO INSTALL RECTANGULAR DUCTWORK IN LIEU OF INDICATED ROUND DUCTWORK AT OTHER LOCATIONS. SIZE ALL RECTANGULAR DUCTWORK CONVERSIONS COMPARABLE TO INDICATED DUCTWORK SIZE PER SMACNA "HVAC DUCT CONSTRUCTION STANDARDS-METAL AND FLEXIBLE," LATEST EDITION. SHOULD THE CONTRACTOR BE IN DOUBT OF THE REQUIREMENTS UNDER THIS SECTION, DUCTWORK SIZING, OR SHOULD ANY DISCREPANCY BE REVEALED BASED ON FIELD CONDITIONS, IMMEDIATELY CONTACT THE ARCHITECT FOR CLARIFICATION.
- K. PROVIDE A FLEXIBLE CONNECTION BETWEEN EQUIPMENT AND RIGID DUCT ON ALL SUPPLY AND RETURN DUCTWORK.
- L. **DIFFUSERS, GRILLES, REGISTERS, AND DAMPERS:** PROVIDE DIFFUSERS, GRILLES, AND REGISTERS AS SCHEDULED. DEVICES TO BE COMPLETE WITH BALANCING DAMPERS, FRAMES, AND ALL ACCESSORIES. FINISH AS INDICATED. PROVIDE UL LISTED (UL55) FIRE RATED DAMPERS AT ALL FIRE PARTITION OR FIRE BARRIER PENETRATIONS, WHETHER SHOWN OR NOT SHOWN ON THE PLANS. ALL GRAVITY DAMPERS REQUIRE SEALS.
- M. **SUPPORT AND BRACING:** INSTALL RIGID ROUND AND RECTANGULAR METAL DUCTWORK WITH APPROVED SUPPORT SYSTEMS INDICATED IN SMACNA STANDARDS AND STATE BUILDING CODE. SUPPORT HORIZONTAL DUCTS AT A MAXIMUM INTERVAL OF 10 FEET AND WITHIN 2 FEET OF EACH ELBOW AND WITHIN 4 FEET OF EACH BRANCH INTERSECTION USING DOUBLE STRAP HANGERS ON EACH SIDE OF FITTING. SUPPORT VERTICAL DUCTS AT A MAXIMUM INTERVAL OF 10 FEET AND AT EACH FLOOR. FLEXIBLE AND OTHER FACTORY MADE DUCTS SHALL BE SUPPORTED IN ACCORDANCE WITH THE MANUFACTURER'S INSTALLATION INSTRUCTIONS. NO WOOD SHALL BE USED TO SUPPORT OR BRACE DUCTS. PROVIDE SWAY AND SEISMIC BRACING AS REQUIRED BY STATE AND LOCAL CODES. PROVIDE FIXED ANCHORS AT EACH MECHANICAL DIFFUSER OR GRILLE TO CEILING GRID. CEILING GRID CONTRACTOR TO PROVIDE SUPPORT WIRES AT OPPOSITE CORNERS OF LIGHT FIXTURES, MECHANICAL DIFFUSERS, AND GRILLES TO STRUCTURE ABOVE.

## HVAC GENERAL SPECIFICATIONS CONT'D

- N. **CONTROLS:** EACH UNIT TO BE CONTROLLED BY THERMOSTAT WITH PROPER STAGES OF HEATING AND COOLING - MOUNTED AT 48" AFF (REFER TO MECHANICAL SHEETS FOR MODEL NO. AND LOCATION); CONTROL WIRING IS TO BE FURNISHED AND INSTALLED BY THE HVAC CONTRACTOR. POWER WIRING IS TO BE FURNISHED AND INSTALLED BY THE ELECTRICAL CONTRACTOR. THERMOSTAT SHALL BE 7-DAY PROGRAMMABLE AND SHALL BE SETUP TO INCLUDE 5 DEGREE DEADBAND, TEMPERATURE OVERLAP RESTRICTION AND TEMPERATURE SETBACK DURING UNOCCUPIED HOURS.
- O. **POWER AND CONTROL WIRING:** ELECTRICAL CONTRACTOR TO PROVIDE ALL NECESSARY POWER WIRING FOR HVAC EQUIPMENT FROM SUITABLE FUSED DISCONNECT SOURCE TO UNIT WITH FUSED DISCONNECT TO MEET NATIONAL ELECTRIC CODE (NEC), STATE AND LOCAL CODES. HVAC CONTRACTOR TO PROVIDE 24 VOLT OR LESS CONTROL WIRING.
- P. **STARTUP:** HVAC CONTRACTOR TO PROVIDE STARTUP PER MANUFACTURER'S WRITTEN RECOMMENDATIONS.
- Q. **AIRFLOW AND TESTING:** ALL DUCT AS PER SMACNA GUIDELINES. THE SYSTEM TO BE BALANCED AND TESTED BY AN INDEPENDENT, "NEBB" CERTIFIED, BALANCING CONTRACTOR PER "NEBB"
- a. **PROCEDURES.** THE HVAC CONTRACTOR SHALL INCLUDE THE COST OF THE BALANCING AND TESTING IN HIS BID. THE BALANCING CONTRACTOR SHALL FURNISH ALL LABOR, MATERIALS, TRANSPORTATION, AND EQUIPMENT NECESSARY TO COMPLETELY BALANCE THE AIR FLOW FOR THE HVAC SYSTEMS AS SHOWN ON THE DRAWINGS. HVAC CONTRACTOR SHALL INSTALL NEW FILTERS IN ALL UNITS PRIOR TO THE AIR BALANCE. THE COMPLETE AIR BALANCE SHALL TAKE PLACE WITH OUTSIDE AIR DAMPERS IN MINIMUM POSITION. BALANCE THE SYSTEM TO WITHIN +/-5 PERCENT OF THE DESIGN REQUIREMENTS. THE HVAC CONTRACTOR AT NO ADDITIONAL COST SHALL PERFORM ANY REQUIRED CHANGES REQUIRED TO ACHIEVE SPECIFIED FLOW RATES. ALL CONTROL SEQUENCES SHALL BE TESTED (INTERLOCKED EQUIPMENT, SMOKE DETECTORS, SMOKE EVACUATION, ECONOMIZER, CO2 SENSORS, ETC.) AND OPERATING STATUS RECORDED IN THE REPORT. A DIGITAL OR THREE (3) PRINTED COPIES OF THE BALANCE AND TESTING REPORT SHALL BE PROVIDED TO THE OWNER, OWNER'S REPRESENTATIVE, OR ARCHITECT BEFORE PROJECT CLOSE OUT FOR REVIEW. THE BALANCING CONTRACTOR SHALL RECHECK ANY ITEMS THAT THE OWNER OR ARCHITECT DEEMS REASONABLY NECESSARY AT NO ADDITIONAL COST TO THE OWNER.
- R. VENTILATION AND COMBUSTION AIR INTAKE: PROVIDE OUTSIDE VENTILATION AIR BY NATURAL VENTILATION OR MECHANICAL EQUIPMENT AS REQUIRED BY THE MECHANICAL CODE (REFER TO OUTSIDE AIR VENTILATION SCHEDULE). IF GAS-FIRED EQUIPMENT IS USED, VERIFY THAT THE MECHANICAL ROOM AND / OR MECHANICAL EQUIPMENT ARE PROVIDED WITH ADEQUATE COMBUSTION AND DILUTION AIR IN COMPLIANCE WITH THE MECHANICAL CODE, PROVIDE ADDITIONAL AIR AS REQUIRED. PROVIDE A VENT DESIGNED FOR THE TYPE OF APPLIANCE BEING VENTED FOR ALL GAS-FIRED EQUIPMENT TO THE EXTERIOR. PROVIDE VENTS DIRECTLY TO THE EXTERIOR FOR ALL EXHAUST FANS. ALL EXHAUST AND INTAKE OPENINGS MUST BE LOCATED A MINIMUM OF 10 FEET FROM LIT LINES OR BUILDINGS ON THE SAME LOT.
- S. PROVIDE A SMOKE DETECTOR IN RETURN AIR SYSTEMS WITH A DESIGN CAPACITY GREATER THAN 2,000 CFM IN THE RETURN AIR DUCT OR PLENUM UPSTREAM OF ANY FILTERS, EXHAUST AIR CONNECTIONS, OUTDOOR AIR CONNECTIONS, OR DECONTAMINATION EQUIPMENT AND APPLIANCES (PER OMC SECTION 606.2.1). WHERE TWO OR MORE UNITS SHARE THE SAME RETURN, THE COMBINED AMOUNT OF CFM SHALL BE USED IN DETERMINING WHETHER A DUCT SMOKE DETECTOR IS REQUIRED. COORDINATE THESE REQUIREMENTS BETWEEN THE HVAC AND THE ELECTRICAL OR FIRE ALARM CONTRACTORS.
- T. PROVIDE ACCESS TO ALL DAMPERS, CONTROLS, AND OTHER ITEMS IN DUCTWORK THAT REQUIRE SERVICE OR INSPECTION. IF THE ACCESS PANEL LOCATION IS EXPOSED, THE OWNER OR THE ARCHITECT MUST APPROVE IT PRIOR TO INSTALLATION. ACCESS PANELS ARE NOT REQUIRED ABOVE LAY-IN GRID TYPE CEILINGS.
- U. ALL HVAC EVAPORATORS AND COOLING COILS REQUIRE A CONDENSATE DRAIN, WHICH IS CONVEYED TO AN APPROPRIATE PLACE OF DISPOSAL (TYPICALLY INDIRECTLY INTO A FLOOR DRAIN). A SECONDARY DRAIN OR AUXILIARY DRAIN PAN (WITH A SEPARATE DRAIN OR A WATER LEVEL DETECTION DEVICE CONFORMING TO UL 508 THAT WILL SHUT OFF THE EQUIPMENT SERVED PRIOR TO OVERFLOW OF THE AUXILIARY DRAIN PAN) IS REQUIRED FOR ANY EQUIPMENT THAT PRODUCES CONDENSATE AND WHERE DAMAGE MAY OCCUR AS A RESULT OF OVERFLOW FROM THE EQUIPMENT DRAIN PAN OR STOPPAGE IN THE CONDENSATE DRAIN (PER OMC SECTION 307.2.3). COORDINATE THESE REQUIREMENTS BETWEEN THE HVAC AND PLUMBING CONTRACTORS AND THE ARCHITECT.
- V. ALL ROOF AND/OR EXTERIOR WALL PENETRATIONS ARE TO BE SEALED AIR AND WATER TIGHT, COORDINATE WITH THE GENERAL CONTRACTOR AND OTHER SUB-CONTRACTORS. ALL EQUIPMENT, PIPES, DUCTS, ETC. ARE TO BE INSTALLED CONCEALED ABOVE THE CEILING UNLESS SHOWN OTHERWISE.
- W. VERIFY ALL SUSPENDED MECHANICAL LOADS WITH ARCHITECT PRIOR TO ORDERING NEW MECHANICAL EQUIPMENT.
- X. HVAC CONTRACTOR TO COORDINATE ROUTING AND LOCATION OF ALL DEVICES WITH BUILDING STRUCTURE AND OTHER CEILING MOUNTED DEVICES.
- Y. HVAC CONTRACTOR TO REVIEW DRAWINGS FOR COMPLIANCE WITH LOCAL CODES AND WITH AUTHORITIES HAVING JURISDICTION OVER THIS PROJECT. CONTACT ARCHITECT WITH ANY QUESTIONS OR CONCERNS.

## DUCTWORK SYMBOL LEGEND

	SUPPLY OR OUTSIDE AIR DUCT UP		RADIUS RECTANGULAR ELBOW
	RETURN OR EXHAUST AIR DUCT UP		SUPPLY OR OUTSIDE AIR ROUND DUCT UP
	SUPPLY OR OUTSIDE AIR DUCT DOWN		RETURN OR EXHAUST AIR ROUND DUCT UP
	RETURN OR EXHAUST AIR DUCT DOWN		ROUND DUCT DOWN
	SUPPLY OR OUTSIDE AIR DUCT OFFSET		ROUND OFFSET
	RETURN AIR DUCT OFFSET		ROUND ELBOW
	MANUAL BALANCING DAMPER		ROUND WYE
	MOTORIZED DAMPER		RECTANGULAR BRANCH TAKEOFF
	FIRE DAMPER		RECTANGULAR DUCT TERMINATION
	RECTANGULAR TO ROUND TRANSITION		ROUND DUCT TERMINATION
	RECTANGULAR TRANSITION		
	STANDARD RECTANGULAR ELBOW		

## ANNOTATION SYMBOL LEGEND

	THERMOSTAT OR TEMP. SENSOR		SECTION SYMBOL
	HUMIDISTAT		EQUIPMENT PLAN MARK
	SWITCH		DETAIL SYMBOL
	KEYED NOTE SYMBOL		
	CONNECT TO EXISTING		
	VAV TERMINAL UNIT MARK		
	EQUIPMENT MARK		
	AIR DEVICE MARK - NECK SIZE		
	ROUND DUCT SIZE		
	RECTANGULAR DUCT SIZE		

## AIR DEVICE AND DUCT ACCESS. LEGEND

	RETURN AIR GRILLE		SUPPLY AIR DIFFUSER (HARD CONNECTION)
	SUPPLY AIR DIFFUSER WITH FLEXIBLE RUNOUT AND DAMPER		RETURN OR EXH. GRILLE (HARD CONNECTION)
	SIDEWALL DIFFUSER		14X14 TRANSFER OPENING IN WALL
	SUPPLY AIR DIFFUSER (HARD CONNECTION)		TRANSFER OPENING IN WALL
	RETURN OR EXH. GRILLE (HARD CONNECTION)		

## PIPE SYMBOL LEGEND

	PIPE DOWN
	PIPE UP
	TEE DOWN
	TEE UP
	PIPE BREAK (FOR CLARITY)
	CAPPED PIPE
	REFRIGERANT SUCTION PIPE
	REFRIGERANT HOT GAS PIPE

## HVAC DESIGN CRITERIA

### GENERAL DESIGN INFORMATION

BUILDING LOCATION: DAYTON, OHIO

### OUTDOOR DESIGN INFORMATION

SUMMER DRY BULB: 90.3°F (ASHRAE 0.4%)  
SUMMER WET BULB: 73.6°F (ASHRAE 0.4%)  
WINTER DRY BULB: 0.6°F (ASHRAE 99.6%)

### INDOOR DESIGN INFORMATION


INDOOR SUMMER DRY BULB: 75°F  
INDOOR SUMMER RH%: 60% MAX.  
INDOOR WINTER DRY BULB: 70°F  
INDOOR WINTER RH%: AMBIENT

### APPLICABLE CODES

MECHANICAL: OHIO MECHANICAL CODE 2024  
PLUMBING: OHIO PLUMBING CODE 2024  
ENERGY: ASHRAE 90.1-2019  
VENTILATION: ASHRAE 62.1-2019

## HVAC INDEX OF DRAWINGS

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### ISSUE

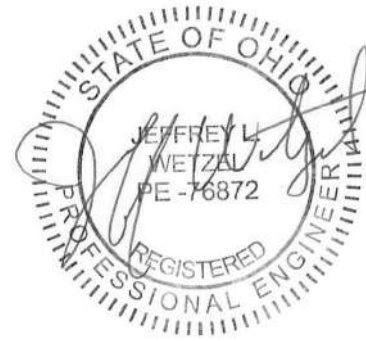NO. DATE DESCRIPTION

01/22/2026 FOR CONSTRUCTION

DATE 01.22.2026

JOB NO. 2025139

DRAWN JLW

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TITLE  
HVAC LEGEND AND  
GENERAL NOTES

SHEET NO.

H0.1



FURNACE SCHEDULE

BASIS OF DESIGN				VENT. AIR (CFM)	E.S.P. (IN.WC)	HEATING		NOM. COOL CAPACITY (TONS)	DIMENSION			ELECTRICAL				NOTES
PLAN MARK	MANUFACTURER	MODEL	CFM			INPUT (BTUH)	OUTPUT (BTUH)		WIDTH	LENGTH	HEIGHT	VOLTAGE	PHASE	MCA	MOCP	
FUR-1	CARRIER	59SP6080V21	1200	200	0.5	80,000	75,000	3	29.5"	21"	35"	120 V	1	16.9 A	20 A	1,2,3,4,5,6
FUR-2	CARRIER	59SP6100V21	1600	300	0.5	100,000	93,000	4	29.5"	21"	35"	120 V	1	16.7 A	20 A	1,2,3,4,5
FUR-3	CARRIER	59SP6120V24	1950	225	0.5	120,000	111,000	5	29.5"	24"	35"	120 V	1	16.7 A	20 A	1,2,3,4,5
FUR-4	CARRIER	59SP6120V24	1950	175	0.5	120,000	111,000	5	29.5"	24"	35"	120 V	1	16.7 A	20 A	1,2,3,4,5

- GENERAL NOTES:  
A. ACCEPTABLE ALTERNATE MANUFACTURERS: TRANE OR DAIKIN.  
B. REFRIGERANT PIPING TO BE SIZED BY MANUFACTURER.
- NOTES:  
1. PROVIDE WITH NON-FUSED DISCONNECT SWITCH.  
2. PROVIDE MATCHED EVAPORATOR COIL AND CONDENSING UNIT.  
3. PROVIDE WITH FILTER RACK AND 1" PLEATED SPARE SET OF FILTERS.  
4. PROVIDE CONCENTRIC VENT KIT.  
5. PROVIDE WITH 7-DAY PROGRAMMABLE THERMOSTAT.  
6. **UNIT TO BE PROVIDED UNDER BASE BID AND EXCLUDED UNDER DEDUCT ALTERNATE.**

AIR CONDITIONING UNIT SCHEDULE

PLAN MARK	ASSOCIATED INDOOR UNIT	BASIS OF DESIGN		NOM. COOL CAPACITY (TONS)	MIN. SEER	DIMENSION			ELECTRIC				NOTES
		MANUFACTURER	MODEL			WIDTH	LENGTH	HEIGHT	VOLTAGE	PHASE	MCA	MOCP	
CU-1	FUR-1	CARRIER	26SPA636	3	16	35"	35"	29"	208 V	1	17.6 A	30 A	1
CU-2	FUR-2	CARRIER	26SPA648	4	16	35"	35"	32"	208 V	1	29.1 A	40 A	
CU-3	FUR-3	CARRIER	26SPA660	5	16	35"	35"	46"	208 V	1	31.1 A	50 A	
CU-4	FUR-4	CARRIER	26SPA660	5	16	35"	35"	46"	208 V	1	31.1 A	50 A	

- GENERAL NOTES:  
A. ACCEPTABLE ALTERNATE MANUFACTURER BY TRANE OR DAIKIN.  
B. CAPACITIES LISTED ARE BASED ON AHRI CONDITIONS.
- NOTES:  
1. **UNIT TO BE PROVIDED UNDER BASE BID AND EXCLUDED UNDER DEDUCT ALTERNATE.**

FUR-1 VENTILATION SCHEDULE

ROOM NUMBER	ROOM NAME	OCCUPANCY TYPE	AREA (SF)	VENTILATION AIR				MINIMUM OA. AIRFLOW (CFM)	PLUMBING FIXTURE COUNT	EXHAUST AIR		MINIMUM EXHAUST REQ'D
				OCCUPANT DENSITY (#/1000SF)	PEOPLE AIR RATE (CFM/PERSON)	AREA AIR RATE (CFM/SF)	NUMBER OF PEOPLE			EXHAUST RATE PER FIXTURE (CFM)	AREA EXHAUST RATE (CFM/SF)	
126	IT	OFFICE	56	5	5	0.06	1	8				
127	WEAPONS CLEAN	UNOCC. STORAGE	65									
128	EQUIPMENT BAGS	UNOCC. STORAGE	103									
129	FILE STORAGE	UNOCC. STORAGE	95									
130	BREAK ROOM	BREAK	150	25	5	0.06	4	29				
140	CORRIDOR	CORRIDOR	297	0	0	0.06	0	18				
			766					55				0

FUR-2 VENTILATION SCHEDULE

ROOM NUMBER	ROOM NAME	OCCUPANCY TYPE	AREA (SF)	VENTILATION AIR				MINIMUM OA. AIRFLOW (CFM)	PLUMBING FIXTURE COUNT	EXHAUST AIR		MINIMUM EXHAUST REQ'D
				OCCUPANT DENSITY (#/1000SF)	PEOPLE AIR RATE (CFM/PERSON)	AREA AIR RATE (CFM/SF)	NUMBER OF PEOPLE			EXHAUST RATE PER FIXTURE (CFM)	AREA EXHAUST RATE (CFM/SF)	
131	TLT	N/A	54						1	50	0	50
132	TLT	N/A	54						1	50	0	50
133	TLT/SHWR	N/A	70						2	50	0	100
134	CHANGE 1	N/A	34									
135	CHANGE 2	N/A	34									
136	CHANGE 3	N/A	40									
137	CHANGE 4	N/A	40									
138	PERSONAL GEAR	LOCKER	786						0	0	0.5	393
139	PERSONAL GEAR CHANGING ROOM	N/A	155									
			1266					0				593

FUR-3 VENTILATION SCHEDULE

ROOM NUMBER	ROOM NAME	OCCUPANCY TYPE	AREA (SF)	VENTILATION AIR				MINIMUM OA. AIRFLOW (CFM)	PLUMBING FIXTURE COUNT	EXHAUST AIR		MINIMUM EXHAUST REQ'D
				OCCUPANT DENSITY (#/1000SF)	PEOPLE AIR RATE (CFM/PERSON)	AREA AIR RATE (CFM/SF)	NUMBER OF PEOPLE			EXHAUST RATE PER FIXTURE (CFM)	AREA EXHAUST RATE (CFM/SF)	
101	VESTIBULE		74									
103	OFFICE	OFFICE	135	5	5	0.06	1	13				
104	CAPTAIN	OFFICE	166	5	5	0.06	1	15				
105	SERGEANT	OFFICE	135	5	5	0.06	1	13				
106	SERGEANT	OFFICE	135	5	5	0.06	1	13				
109	CONFERENCE/ROLL CALL	CONFERENCE	360	50	5	0.06	18	112				
110	DEPUTIES	OFFICE	186	5	5	0.06	1	16				
123	BREATH	OFFICE	61	5	5	0.06	1	9				
125	CORRIDOR	CORRIDOR	438	0	0	0.06	0	26				
			1689					217				0

FUR-4 VENTILATION SCHEDULE

ROOM NUMBER	ROOM NAME	OCCUPANCY TYPE	AREA (SF)	VENTILATION AIR				MINIMUM OA. AIRFLOW (CFM)	PLUMBING FIXTURE COUNT	EXHAUST AIR		MINIMUM EXHAUST REQ'D
				OCCUPANT DENSITY (#/1000SF)	PEOPLE AIR RATE (CFM/PERSON)	AREA AIR RATE (CFM/SF)	NUMBER OF PEOPLE			EXHAUST RATE PER FIXTURE (CFM)	AREA EXHAUST RATE (CFM/SF)	
102	SAFE ROOM	OFFICE	52	5	5	0.06	1	8				
111	DETECTIVE 1	OFFICE	123	5	5	0.06	1	12				
112	DETECTIVE 2	OFFICE	123	5	5	0.06	1	12				
113	DETECTIVE 3	OFFICE	123	5	5	0.06	1	12				
114	DETECTIVE 4	OFFICE	123	5	5	0.06	1	12				
115	DETECTIVE 5	OFFICE	123	5	5	0.06	1	12				
116	INTERVIEW 1	OFFICE	98	5	5	0.06	1	11				
117	INTERVIEW 2	OFFICE	98	5	5	0.06	1	11				
118	STORM SHLT/TLT	STORM SHELTER	103	140	5	0	15	75	1	50	0	50
119	COP	OFFICE	126	5	5	0.06	1	13				
120	TRAFFIC	OFFICE	65	5	5	0.06	1	9				
124	TLT/SHWR		70									
125	CORRIDOR	CORRIDOR	335	0	0	0.06	0	20				
			1558					207				50

AIR INLETS AND OUTLETS SCHEDULE

PLAN MARK	DESCRIPTION	BASIS OF DESIGN		MOUNTING	FINISH	MATERIAL	ACCESSORIES	NOTES
		MANUF.	MODEL					
A1	SQUARE FACE CEILING DIFFUSER, 24x24 FACE	TITUS	TMS	LAY-IN	WHITE	STEEL	-	
A2	SQUARE FACE CEILING DIFFUSER, 24x24 FACE	TITUS	TMS	SURFACE	WHITE	STEEL	OPP. BLADE DMPR.	
A3	SQUARE FACE CEILING DIFFUSER, 12x12 FACE	TITUS	TMS	LAY-IN	WHITE	STEEL	-	
B1	EGGCRATE RETURN GRILLE	TITUS	50F	LAY-IN	WHITE	STEEL	-	
B2	EGGCRATE RETURN GRILLE	TITUS	50F	SURFACE	WHITE	STEEL	OPP. BLADE DMPR.	
C1	DOUBLE DEFLECTION SUPPLY GRILLE	TITUS	272RL	SURFACE	WHITE	STEEL	OPP. BLADE DMPR.	
D1	RETURN GRILLE	TITUS	350RL	SURFACE	WHITE	STEEL	OPP. BLADE DMPR.	

- GENERAL NOTES:  
A. LAY-IN AIR DEVICES SHALL BE DESIGNED TO INSTALL INTO A 24"x24" OR 24"x48" ACT CEILING SYSTEM  
B. ACCEPTABLE ALTERNATE MANUFACTURERS: PRICE, KREUGER AND TUTTLE & BAILEY  
C. PROVIDE AUXILIARY MOUNTING FRAME FOR DEVICES INSTALLED WITHIN GYPSUM, PLASTER, TILE OR OTHER SIMILAR SURFACE  
D. UNLESS OTHERWISE DESIGNATED ON PLANS, SUPPLY DIFFUSERS SHALL BE 4-WAY DIRECTIONAL DISCHARGE.

- NOTES:  
1. .

FAN SCHEDULE

PLAN MARK	DESCRIPTION	BASIS OF DESIGN		CFM	E.S.P. (IN.WC)	DRIVE	ELECTRICAL			APPROX. ROOF/WALL OPENING (IN.)	NOTES
		MANUF.	MODEL				HP	VOLTAGE	PHASE		
EF-1	CEILING EXHAUST	GREENHECK	SP-A125	110	0.25	DIRECT	0.1	120 V	1		2,4,5
EF-2	CEILING EXHAUST	GREENHECK	SP-A125	110	0.25	DIRECT	0.1	120 V	1		2,4,5
EF-3	CEILING EXHAUST	GREENHECK	SP-A125	110	0.25	DIRECT	0.1	120 V	1		2,4,5
EF-4	CEILING EXHAUST	GREENHECK	SP-A125	110	0.25	DIRECT	0.1	120 V	1		2,4
EF-5	CENTRIFUGAL DOWNBLAST	GREENHECK	G-090-D	400	0.3	DIRECT	0.1	120 V	1	13.5"x13.5"	1,3,5
EF-6	INLINE CENTRIFUGAL	GREENHECK	SQ-70	130	0.2	DIRECT	0.1	120 V	1		2,4

- GENERAL NOTES:  
A. ACCEPTABLE ALTERNATE MANUFACTURERS: COOK, CARNES & PENNBARRY

- NOTES:  
1. PROVIDE WITH MINIMUM 12" HIGH ROOF CURB, DISCONNECT SWITCH, GRAVITY BACKDRAFT DAMPER AND BIRDSCREEN.  
2. PROVIDE WITH INTEGRAL DISCONNECT SWITCH, SOLID STATE SPEED CONTROLLER AND GRAVITY BACKDRAFT DAMPER.  
3. FAN SHALL BE CONTROLLED BY WALL SWITCH.  
4. FAN CONTROLLED BY OCCUPANCY SENSOR.  
5. **UNIT TO BE PROVIDED UNDER BASE BID AND EXCLUDED UNDER DEDUCT ALTERNATE.**

DUCTWORK CONSTRUCTION SCHEDULE

DUCT SYSTEM	SHAPE	PRESS. CLASS W.G.	MATERIAL	LINER			INSULATION				NOTES
				THK.	TYPE	D	THK.	TYPE	D	JACKET	
CONCEALED SUPPLY	RND/RECT	-/+2"	GS	-	-	-	1.5"	FGW	-	FFJ	2
CONCEALED RETURN	RND/RECT	-/+2"	GS	-	-	-	1.5"	FGW	-	FFJ	
CONCEALED SUPPLY AIR DEVICE RUNOUT	RND	+1"	IFD	-	-	-	1.5"	IFD	-	FFJ	1
OUTSIDE AIR	RND/RECT	-1"	GS	-	-	-	1.5"	FGW	-	FFJ	
EXHAUST	RND/RECT	-1"	GS	-	-	-	-	-	-	-	
TRANSFER AIR DUCT	RECT	-/+1"	GS	1"	PFL	-	-	-	-	-	3

- GENERAL NOTES:  
A. ALL PAINTING BY GENERAL CONTRACTOR.  
B. ALL DUCT JOINTS AND SEAMS SHALL BE SEALED PER OMC CHAPTER 5.
- SCHEDULE NOTES:  
1. ROUND RUNOUTS TO AIR DEVICES SHALL BE EXTERNALLY INSULATED.  
2. INCLUDES DUCTWORK ROUTED IN ABOVE CEILING PLENUM SPACES.  
3. IN LIEU OF RIGID DUCT AND LINER, INSULATED DUCTBOARD MAY BE USED WHEN NOT PASSING THROUGH WALL ASSEMBLY.


ABBREVIATIONS: AIFD ACOUSTICAL INSULATED FLEX-DUCT ALUM ALUMINUM ABA ADHESIVE BACKED ALUMINUM ASJ ALL SERVICE JACKET CS CARBON STEEL D DENSITY (PCF) DWI DOUBLEWALL INSULATED ETPS EXTRUDED POLYSTYRENE FB FIBERGLASS BOARD	FFJ FIBERGLASS WRAP FGW FIRE WRAP GS GALVANIZED STEEL GSSP GALVANIZED STEEL SPIRAL PIPE IFD INSULATED FLEXIBLE DUCT MFF MATT FACED FIBERGLASS PFD PERFORATED FABRIC DUCT PFL PREFORMED LINER	PGGS PVCGS RECT RECTANGULAR RND ROUND SS STAINLESS STEEL TH THICKNESS UFD UNISULATED FLEXIBLE DUCT	PAINTGRIP GALVANIZED STEEL PVC COATED GALVANIZED STEEL RECTANGULAR ROUND STAINLESS STEEL THICKNESS UNISULATED FLEXIBLE DUCT
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GRAVITY VENTILATOR SCHEDULE

PLAN MARK	BASIS OF DESIGN		SERVICE	CFM	E.S.P. (IN)	DUCT SIZE	THROAT AREA (SF)	NOTES
	MANUF.	MODEL						
GRV-1	GREENHECK	GRSI-10	RELIEF	330	0.01	12"x12"	0.82	1,2,3
GIV-2	GREENHECK	GRSI-10	INTAKE	500	0.01	12"x12"	0.82	1,2
GIV-3	GREENHECK	GRSI-10	INTAKE	400	0.01	12"x12"	0.82	1,2

- GENERAL NOTES:  
A. ACCEPTABLE ALTERNATE MANUFACTURERS: COOK, CARNES & PENNBARRY
- NOTES:  
1. PROVIDE GRAVITY BACKDRAFT DAMPER.  
2. PROVIDE 14" HIGH ROOF CURB FOR FLAT ROOF.  
3. **UNIT TO BE PROVIDED UNDER BASE BID AND EXCLUDED UNDER ALTERNATE #1.**




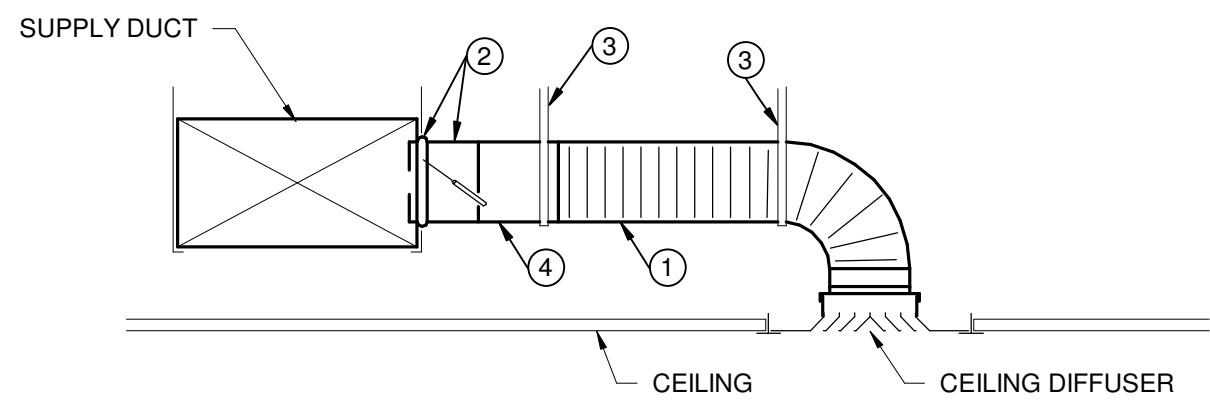

#### NOTES

- INSULATED FLEXIBLE DUCT SAME DIAMETER AS BRANCH DUCT, 6 FT. MAXIMUM TOTAL LENGTH PER AIR DEVICE. STRETCH FLEXIBLE DUCT TO AT LEAST 90% OF FULLY EXTENDED LENGTH.
- BRANCH TAP FITTING, STRAIGHT SIDE WITH MANUAL DAMPER. DAMPER SHAFT IN HORIZONTAL. INTEGRAL INSULATION GUARD SLEEVE REQUIRED FOR TAP FITTING TO MAIN DUCT WITH INTERNAL INSULATION, AND EXTENDED DAMPER SHAFT AND HANDLE WITH STAND-OFF TO ACCOMMODATE EXTERNAL INSULATION.
- DUCT STRAP HANGER. ATTACH TO STRUCTURE.
- ROUND SHEET METAL BRANCH DUCT, SAME SIZE AS DIFFUSER INLET UNLESS NOTED OTHERWISE.


#### 1 CEILING DIFFUSER CONNECTION NTS

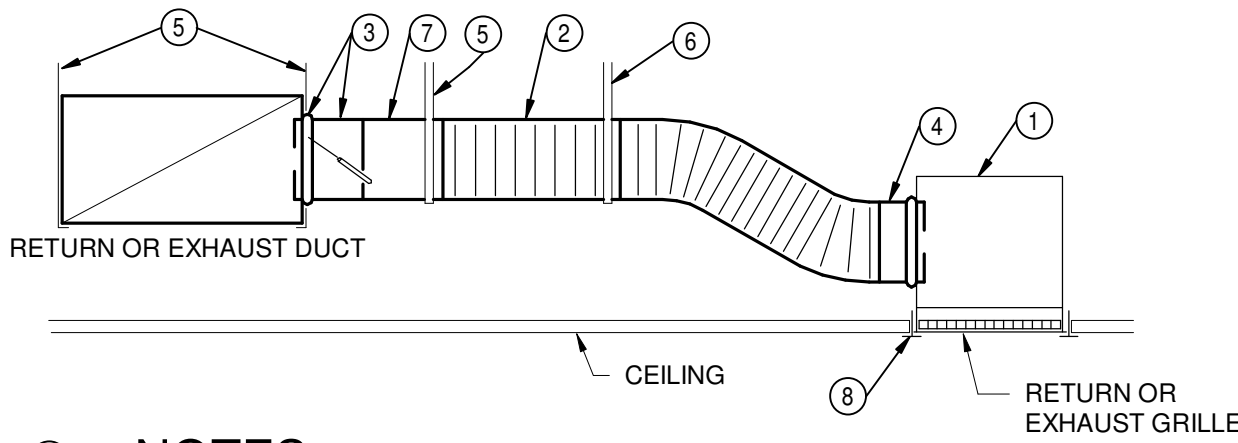

#### NOTES

- SHEET METAL PLENUM, FULL SIZE OF GRILLE NECK, MINIMUM 4" TALLER THAN DUCT RUNOUT SIZE, WITH SAME INTERNAL OR EXTERNAL INSULATION AS RETURN OR EXHAUST DUCT, CONNECT TO GRILLE.
- FLEXIBLE DUCT, SAME DIAMETER AS BRANCH DUCT, 7 FT. MAXIMUM TOTAL LENGTH PER AIR DEVICE. STRETCH FLEXIBLE DUCT TO AT LEAST 90% OF FULLY EXTENDED LENGTH.
- BRANCH TAP FITTING, STRAIGHT SIDE WITH MANUAL DAMPER. DAMPER SHAFT IN HORIZONTAL. INTEGRAL INSULATION GUARD SLEEVE REQUIRED FOR TAP FITTING TO MAIN DUCT WITH INTERNAL INSULATION. EXTENDED DAMPER SHAFT AND HANDLE WITH STAND-OFF REQUIRED FOR EXTERNALLY INSULATED DUCTWORK.
- TAP FITTING, NO DAMPER.
- DUCT STRAP HANGER. ATTACH TO STRUCTURE.
- STRAP HANGER REQUIRED IF LENGTH OF FLEXIBLE DUCT IS LONGER THAN 4 FT.
- ROUND SHEET METAL BRANCH DUCT, SIZE AS INDICATED IN ADJACENT SCHEDULE UNLESS NOTED OTHERWISE ON PLANS.
- CEILING T-BAR SUPPORT (FOR LAY-IN APPLICATIONS). COORDINATE AND VERIFY T-BAR TYPE FOR COMPATIBILITY WITH GRILLE.


#### 2 RETURN/EXHAUST GRILLE DUCTED CONNECTION NTS

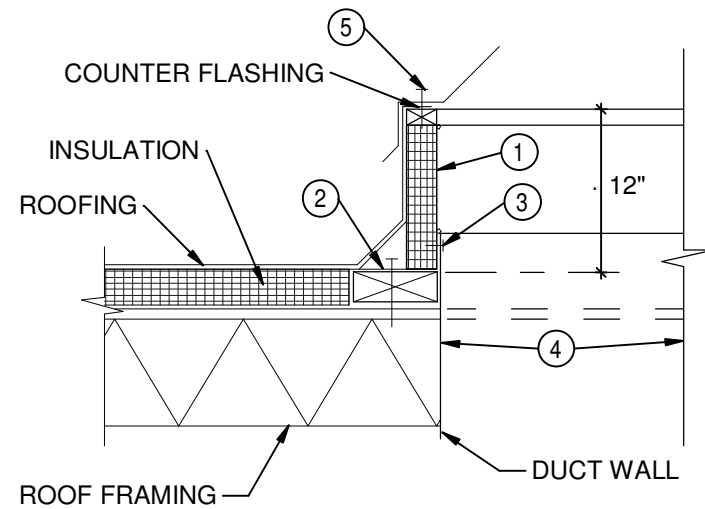

#### NOTES

- INSULATED STEEL CURB.
- PROVIDE PRESSURE TREATED RIGID WOOD BLOCK FRAME SAME THICKNESS AS ROOF INSULATION. SECURE CURB MOUNTING FLANGE AND BLOCKING TO ROOF DECK WITH 1/4" x 3" LAG SCREW, EVERY 8".
- #8 SHEET METAL SCREW.
- ROOF DECK OPENING. COORDINATE REQUIRED OPENING SIZE.
- SECURE FAN TO CURB USING 1/4"x2" GALVANIZED LAG SCREW MINIMUM 8" O/C.
- SECURE CURB TO ROOF DECK USING 1/4"x3" GALVANIZED LAG SCREW MINIMUM 8" O/C.


#### 3 ROOF EQUIPMENT CURB MOUNTING DETAIL NTS

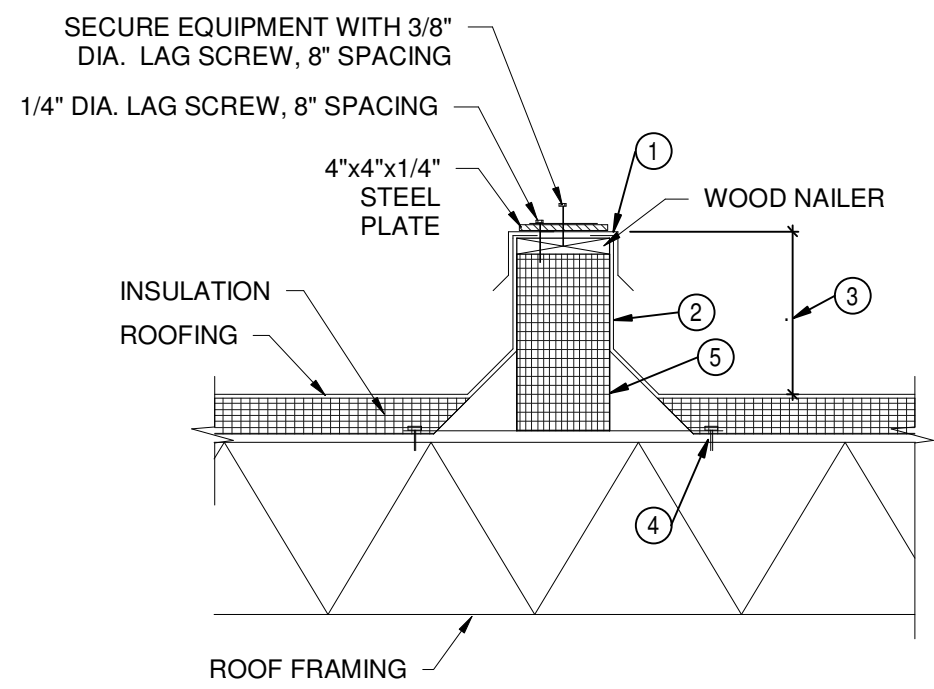

#### NOTES


- PROVIDE COUNTER-FLASHING.
- HEAVY GAUGE CONTINUOUS SUPPORT EXTENDS 6" BEYOND LAST EQUIPMENT LEG. SCREW ATTACHMENT TO DECK.
- MINIMUM 12 INCHES.
- 1/4" DIA. LAG SCREW TO DECK, SPACED EVERY 8".
- 18" HIGH INSULATED STEEL CURB.

#### 4 ROOF EQUIPMENT SUPPORT NTS

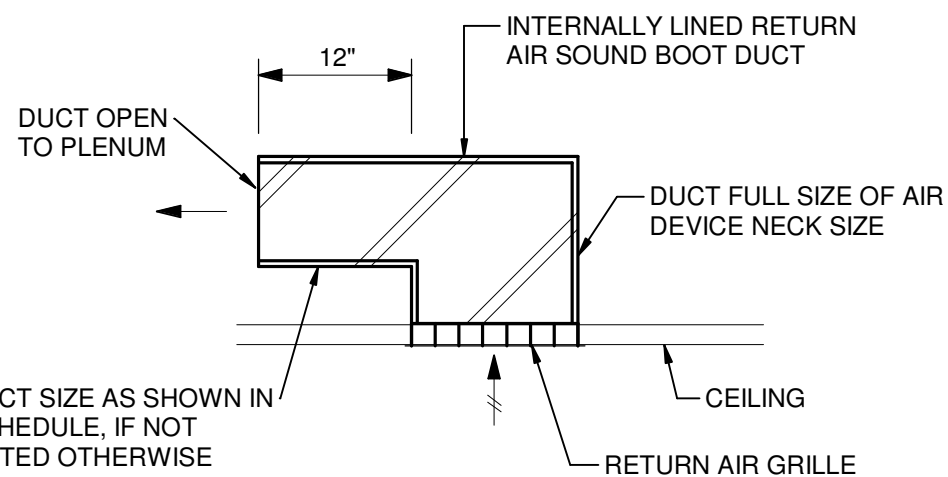

AIR DEVICE SIZE	DUCT SIZE
12x12	12x10
24x12	12x12
24x24	24x12

#### 5 TRANSFER AIR SOUND BOOT NTS

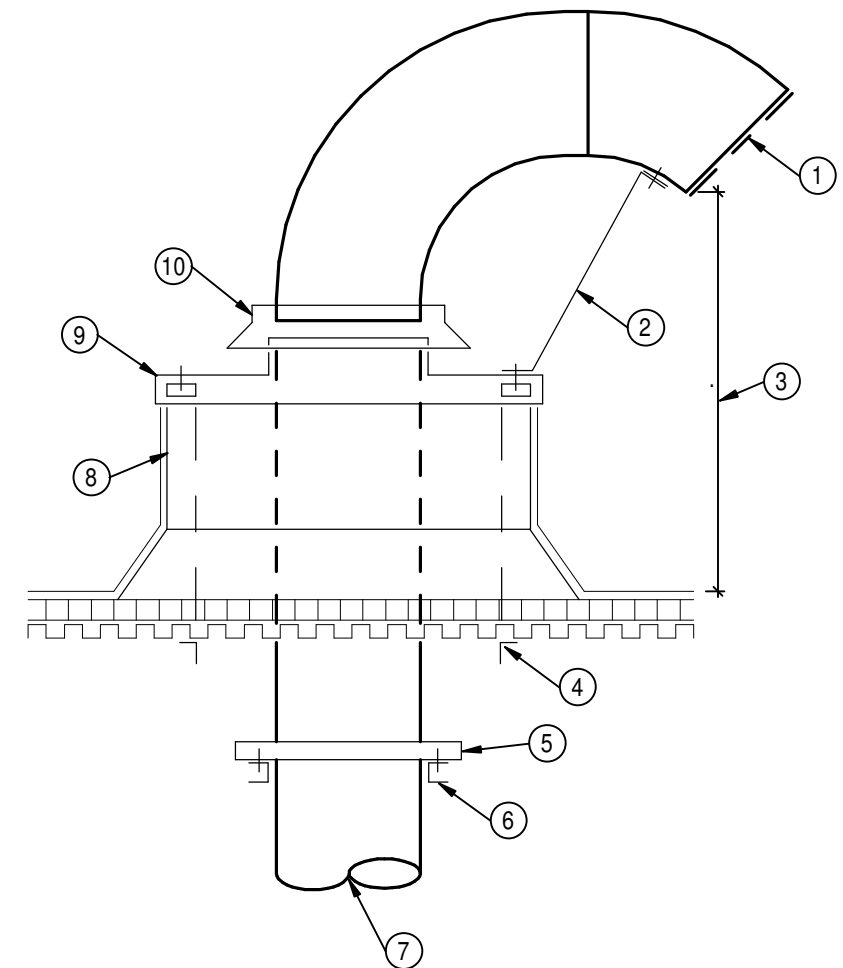


#### NOTES

- 1/2" MESH BIRDSCREEN.
- 2" WIDE x 1/8" THICK STEEL SUPPORTS.
- 3'-0" CLEARANCE TYPICAL ALL VENTS.
- STRUCTURAL FRAMING FOR OPENING. COORDINATE REQUIRED OPENING DIMENSIONS.
- SUPPORT RING. FASTEN TO DUCTWORK AND CHANNEL.
- CHANNEL SUPPORT FROM ADJACENT JOISTS.
- FROM LAUNDRY EQUIPMENT.
- 16" HIGH CURB. REFER TO CURB DETAIL THIS SHEET FOR INSTALLATION.
- FLASHING COLLAR FASTEN TO DUCTS.
- STORM COLLAR FASTEN TO DUCT.

#### GENERAL NOTES

- A. PAINT ALL EXTERIOR DUCTWORK AND DEVICES WITH TWO COATS OF ENAMEL. ALL EXTERIOR SHEET METAL SHALL BE "PAINT-GRIP" CONSTRUCTION.

#### 6 VENT DUCTS THROUGH ROOF NTS

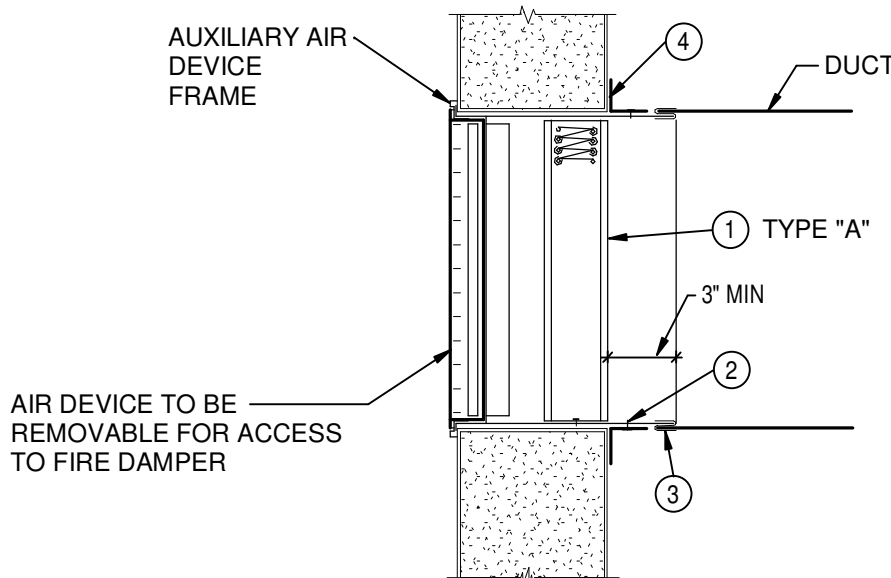

#### 7 FIRE DAMPER AT AIR DEVICE - WALL NTS

#### FIRE DAMPER NOTES

#### GENERAL NOTES

- A. FIRE DAMPERS SHALL BE UL LABELED.
- B. INSTALLATION OF FIRE DAMPERS AND ACCESSORIES SHALL CONFORM TO NFPA 90A, SMACNA AND MANUFACTURER'S INSTRUCTIONS.
- C. DETAILS SHOW INSTALLATION OF FIRE DAMPER IN WALL. DAMPER INSTALLATION IN FLOOR SIMILAR. COORDINATE REQUIRED ACCESS LOCATIONS.
- D. INSULATE RETAINING ANGLES FOR SYSTEMS REQUIRED TO BE INSULATED.

#### NOTES

- FIRE DAMPER, FOLDED BLADE CURTAIN TYPE, EXCEPT AS NOTED. VERTICAL MOUNT, GRAVITY DROP; HORIZONTAL MOUNT, SPRING LOADED TO CLOSE. REFER TO SPECS FOR VELOCITY LIMITATIONS OF EACH TYPE. REFER TO DRAWINGS FOR STATIC OR DYNAMIC REQUIREMENTS.  
  
TYPE "A" - BLADES STORED IN AIR STREAM. RECTANGULAR, ROUND OR OVAL DUCT CONNECTION.
- SHEET METAL WALL SLEEVE, SAME MATERIAL AS DUCT (EXCEPT GALVANIZED SHEET METAL FOR FIBERGLASS DUCT). SHEET METAL GAUGE PER SMACNA. USE EXTENDED HEAVY GAUGE SLEEVES WHEN INSTALLED CONDITION REQUIRES.
- DUCT/SLEEVE CONNECTION. BREAKAWAY TYPE SHOWN. CONNECTION MAY BE RIGID TYPE IF ALLOWED BY CODE AUTHORITY.
- RETAINING ANGLE ALL FOUR SIDES, GAUGE PER SMACNA. 1" MINIMUM OVERLAP OF WALL OPENING. LONGER LEG MAY BE REQUIRED TO ATTAIN REQUIRED OVERLAP. BOLT, SCREW OR TACK WELD TO WALL SLEEVE. SPACING OF FASTENERS PER SMACNA.



A

B

C

D

E

F

1

2

3

4


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6

7

DRAWING NOTES

- EXISTING ROOF MOUNTED AIR CONDITIONER AND ASSOCIATED REFRIGERANT PIPING, SUPPORTS, CONTROL WIRING, ETC. TO BE REMOVED. EXISTING ROOF SHALL BE REPAIRED CONSISTENT WITH EXISTING MATERIALS AND METHODS.
- EXISTING EXHAUST FAN AND ASSOCIATED DUCTWORK, WIRING, CONTROLS ETC. TO BE REMOVED.
- EXISTING DUCTWORK TO BE REMOVED AS INDICATED.
- EXISTING GAS FURNACE AND ASSOCIATED WIRING, CONTROLS SUPPORTS, ETC. TO BE REMOVED.
- EXISTING THERMOSTAT AND WIRING TO BE REMOVED.
- EXISTING AIR DEVICE AND ASSOCIATED DUCTWORK TO BE REMOVED.

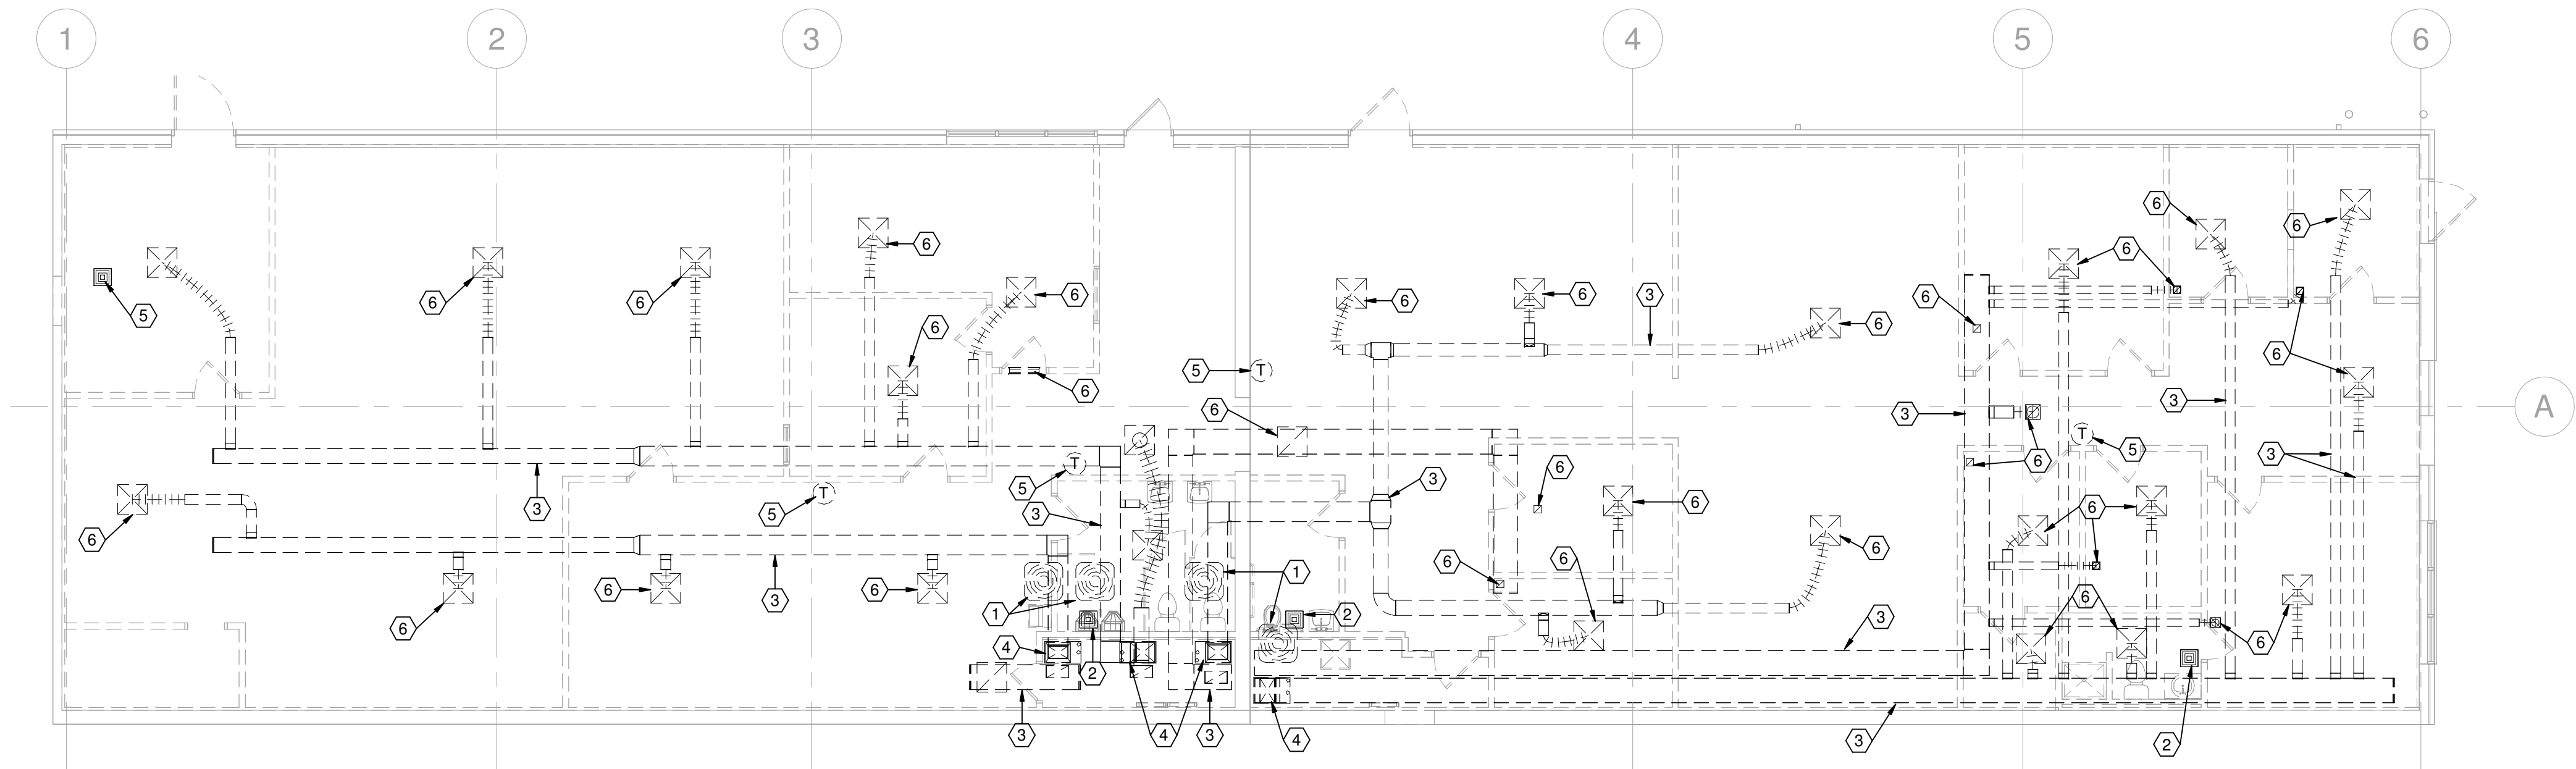

1 FLOOR PLAN - DEMOLITION

1/8" = 1'-0"



A

B

C

D

E

F

ISSUE

NO.	DATE	DESCRIPTION
01	01/22/2026	FOR CONSTRUCTION

DATE 01.22.2026

JOB NO. 2025139

DRAWN JLW

CHECKED -

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TITLE  
HVAC FLOOR PLAN -  
DEMOLITION

SHEET NO.

H1.1



BASE BID DESCRIPTION


- A. THE HVAC BASE BID FOR THE WEST AREA SHALL INCLUDE ALL HVAC SCOPE SHOWN ON THIS SHEET.
- B. AS A DEDUCT ALTERNATE, CONTRACTOR SHALL PROVIDE THE COST REDUCTION TO SHELL THE WEST AREA SPACE. THIS INCLUDES NOT INSTALLING THE FUR-1 FULL SYSTEM, EXHAUST FAN SYSTEMS EF-1, EF-2, EF-3 AND EF-5, GRAVITY VENTILATOR GRV-1 AND PORTION OF FUR-2 DUCT SYSTEM. REFER TO SHEET H2.4 FOR ALTERNATE HVAC PLAN FOR FURTHER DETAILS.

GENERAL NOTES

- A. ALL DUCTWORK AND PIPING SHALL BE SEISMICALLY BRACED AND SUPPORTED FROM THE STRUCTURE BASED ON THE BUILDING BEING AN ESSENTIAL FACILITY. ALL SEISMIC BRACING CALCULATIONS AND DESIGN SHALL BE DELEGATED DESIGN AND THE RESPONSIBILITY OF THIS CONTRACTOR.

DRAWING NOTES

- DUCT UP TO EXHAUST FAN ON ROOF. REFER TO ROOF PLAN FOR CONTINUATION.
- DUCT UP TO ROOF MOUNTED GRAVITY RELIEF VENTILATOR. REFER TO ROOF PLAN FOR CONTINUATION.
- GRILLE OPEN TO RETURN AIR PLENUM.
- DUCT UP THROUGH ROOF. TERMINATE WITH GOOSENECK WITH BIRDSCREEN.
- DUCT OPEN TO PLENUM SPACE.
- VENTILATION AIR INTAKE DUCT UP THROUGH ROOF TO INTAKE VENTILATOR. CONTRACTOR SHALL PATCH AND SEAL PENETRATION WEATHERTIGHT.
- PROVIDE VENTILATION AIR DUCT TO RETURN MAIN DUCT. PROVIDE WITH MANUAL BALANCE DAMPER. BALANCE VENTILATION AIR TO AIRFLOW INDICATED IN VENTILATION SCHEDULE.
- PROVIDE DUCT MOUNTED SMOKE DETECTOR. PROVIDE WITH VISUAL ALARM INDICATOR. INDICATOR SHALL BE MOUNTED IN CEILING OR WALL IN CORRIDOR FOR VISIBILITY. ALL WIRING BY E.C.
- PROVIDE SUPPLY DUCT PLENUM FROM UNIT UP INTO PLENUM SPACE.
- PROVIDE TRANSFER AIR DUCT WITH 1" LINER UP FROM GRILLE THROUGH PLENUM AND ROOM WALL. REFER TO DETAIL ON SHEET H0.3 FOR SIZE.
- PROVIDE TRANSFER AIR DUCT ABOVE CEILING THROUGH WALL. SIZE AS INDICATED.
- PROVIDE GAS FURNACE. UTILIZE UNIT FULL SIZE SIDE RETURN CONNECTION. PROVIDE WITH 2" WIDE FILTER. PROVIDE FLEXIBLE DUCT CONNECTION IN RETURN MAIN AND AT UNIT SUPPLY CONNECTION. ROUTE SCHEDULE 40 PVC VENT PIPING UP THROUGH ROOF AND TERMINATE PER MANUFACTURER GUIDELINES.
- PROVIDE TRANSFER AIR GRILLE AND SOUND BOOT. REFER TO DETAIL ON SHEET H0.3.
- DUCT TO RISE OVER STRUCTURAL BEAM AND BACK DOWN WITHIN ROOF JOIST SPACE

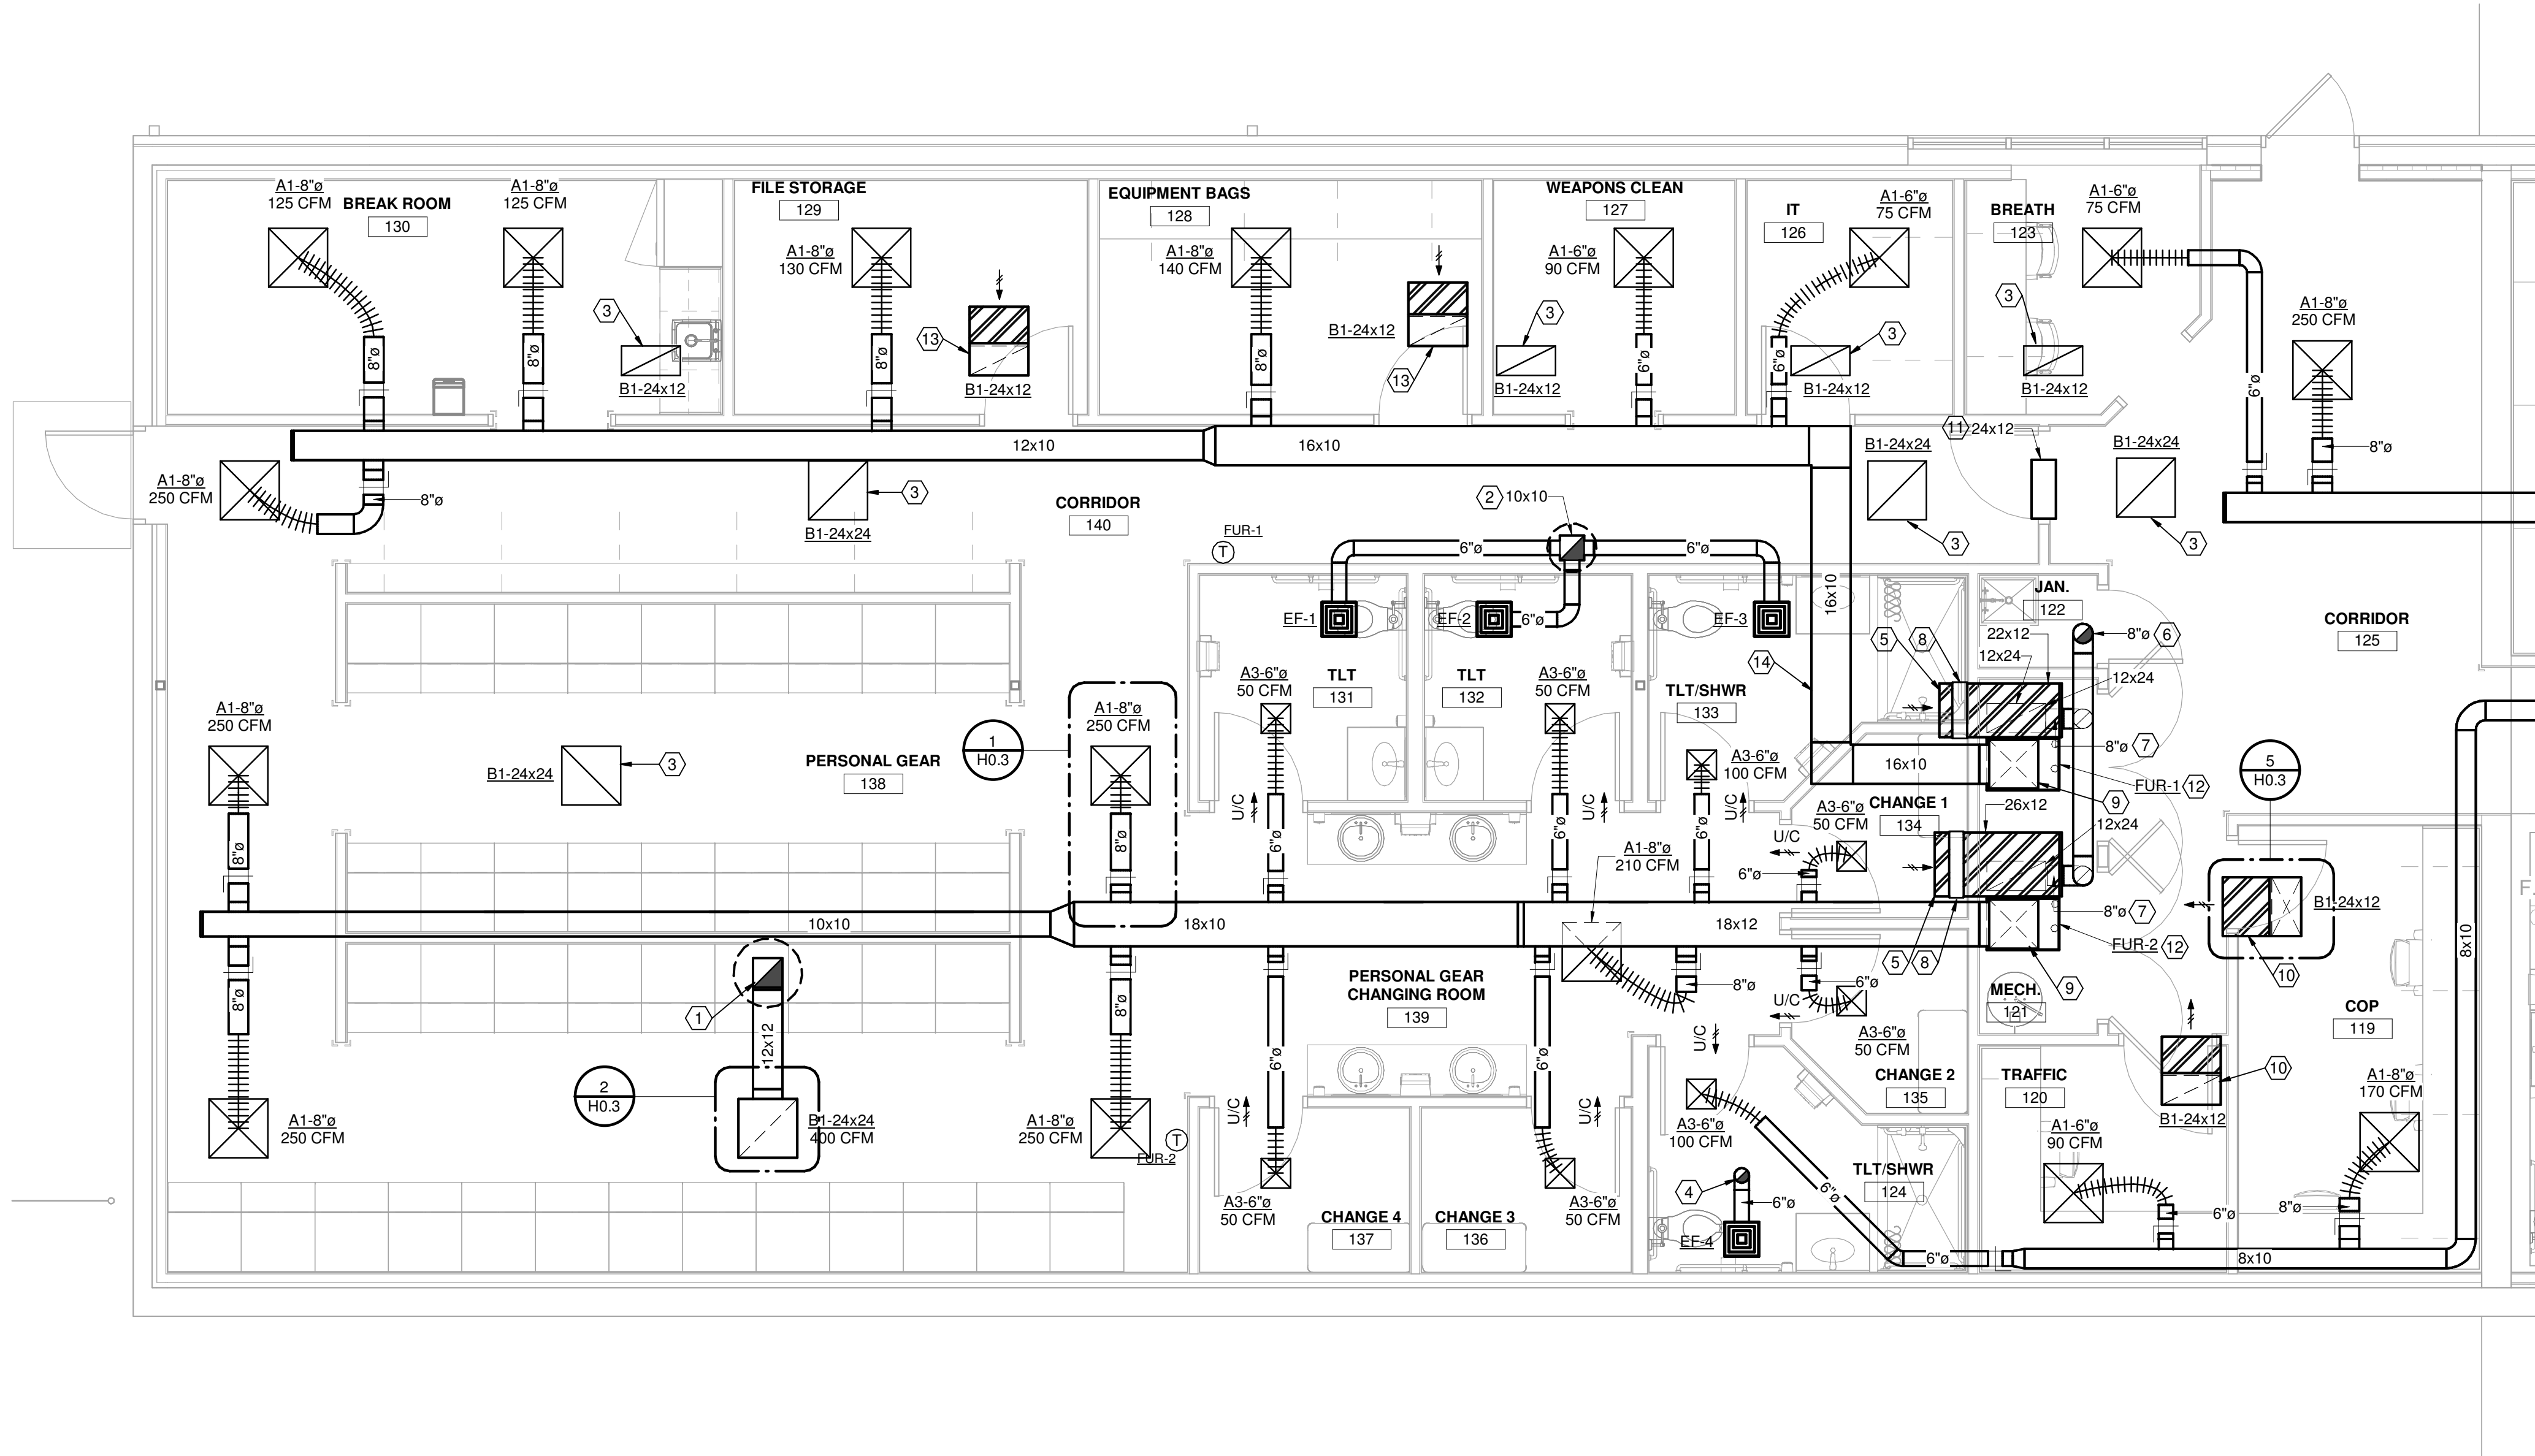

1 FLOOR PLAN - WEST - NEW WORK  
1/4" = 1'-0"

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TITLE HVAC FLOOR PLAN - WEST - NEW WORK	

SHEET NO.



A. ALL DUCTWORK AND PIPING SHALL BE SEISMICALLY BRACED AND SUPPORTED FROM THE STRUCTURE BASED ON THE BUILDING BEING AN ESSENTIAL FACILITY. ALL SEISMIC BRACING CALCULATIONS AND DESIGN SHALL BE DELEGATED DESIGN AND THE RESPONSIBILITY OF THIS CONTRACTOR.

1. DUCT UP THROUGH ROOF AND TERMINATE WITH GOOSENECK. REFER TO DETAIL ON SHEET H0.3.
2. PROVIDE TRANSFER AIR GRILLE AND SOUND BOOT. REFER TO DETAIL ON SHEET H0.3
3. GRILLE OPEN TO RETURN AIR PLENUM.
4. DUCT TO RISE OVER STRUCTURAL BEAM AND BACK DOWN WITHIN ROOF JOIST SPACE
5. DUCT OPEN TO PLENUM SPACE.
6. VENTILATION AIR INTAKE DUCT UP THROUGH ROOF TO INTAKE VENTILATOR. CONTRACTOR SHALL PATCH AND SEAL PENETRATION WEATHERTIGHT.
7. PROVIDE VENTILATION AIR DUCT TO RETURN MAIN DUCT. PROVIDE WITH MANUAL BALANCE DAMPER. BALANCE VENTILATION AIR TO AIRFLOW INDICATED IN VENTILATION SCHEDULE.
8. PROVIDE DUCT MOUNTED SMOKE DETECTOR. PROVIDE WITH VISUAL ALARM INDICATOR. INDICATOR SHALL BE MOUNTED IN CEILING OR WALL IN CORRIDOR FOR VISIBILITY. ALL WIRING BY E.C.
9. PROVIDE SUPPLY DUCT PLENUM FROM UNIT UP INTO PLENUM SPACE.
10. PROVIDE TRANSFER AIR DUCT WITH 1" LINER UP FROM GRILLE THROUGH PLENUM AND ROOM WALL. REFER TO DETAIL ON SHEET H0.3 FOR SIZE.
11. PROVIDE TRANSFER AIR DUCT ABOVE CEILING THROUGH WALL. SIZE AS INDICATED.
12. PROVIDE GAS FURNACE. UNIT MOUNTED ON FULL UNIT SIZE DEPTH BY MIN. 18" TALL BOTTOM RETURN STRUCTURAL PLENUM. PROVIDE WITH 2" WIDE FILTER RACK IN PLENUM. PROVIDE FLEXIBLE DUCT CONNECTION FROM RETURN MAIN TO PLENUM BOX AND AT UNIT SUPPLY CONNECTION.
13. GRILLE FOR STORM SHELTER SHALL BE LOCATED IN BLOCK WALL. LOCATE GRILLE IN BLOCK SPACING. FINAL LOCATION TO BE FIELD COORDINATED. PROVIDE WITH 3-HOUR FIRE DAMPER. REFER TO FIRE DAMPER DETAILS ON SHEET H0.3.
14. PROVIDE DUCT MOUNTED SMOKE DETECTOR IN VERTICAL RETURN AIR DUCT MAIN. DETECTOR MUST BE PLACED UPSTREAM OF THE VENTILATION AIR CONNECTION TO PREVENT AIR DILUTION. PROVIDE WITH VISUAL ALARM INDICATOR. INDICATOR SHALL BE MOUNTED IN CEILING OR WALL IN CORRIDOR FOR VISIBILITY. ALL WIRING BY E.C.



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## Harrison Township District 10 Sheriff Substation Renovation

6001 N Dixie Dr, Dayton, OH 45414

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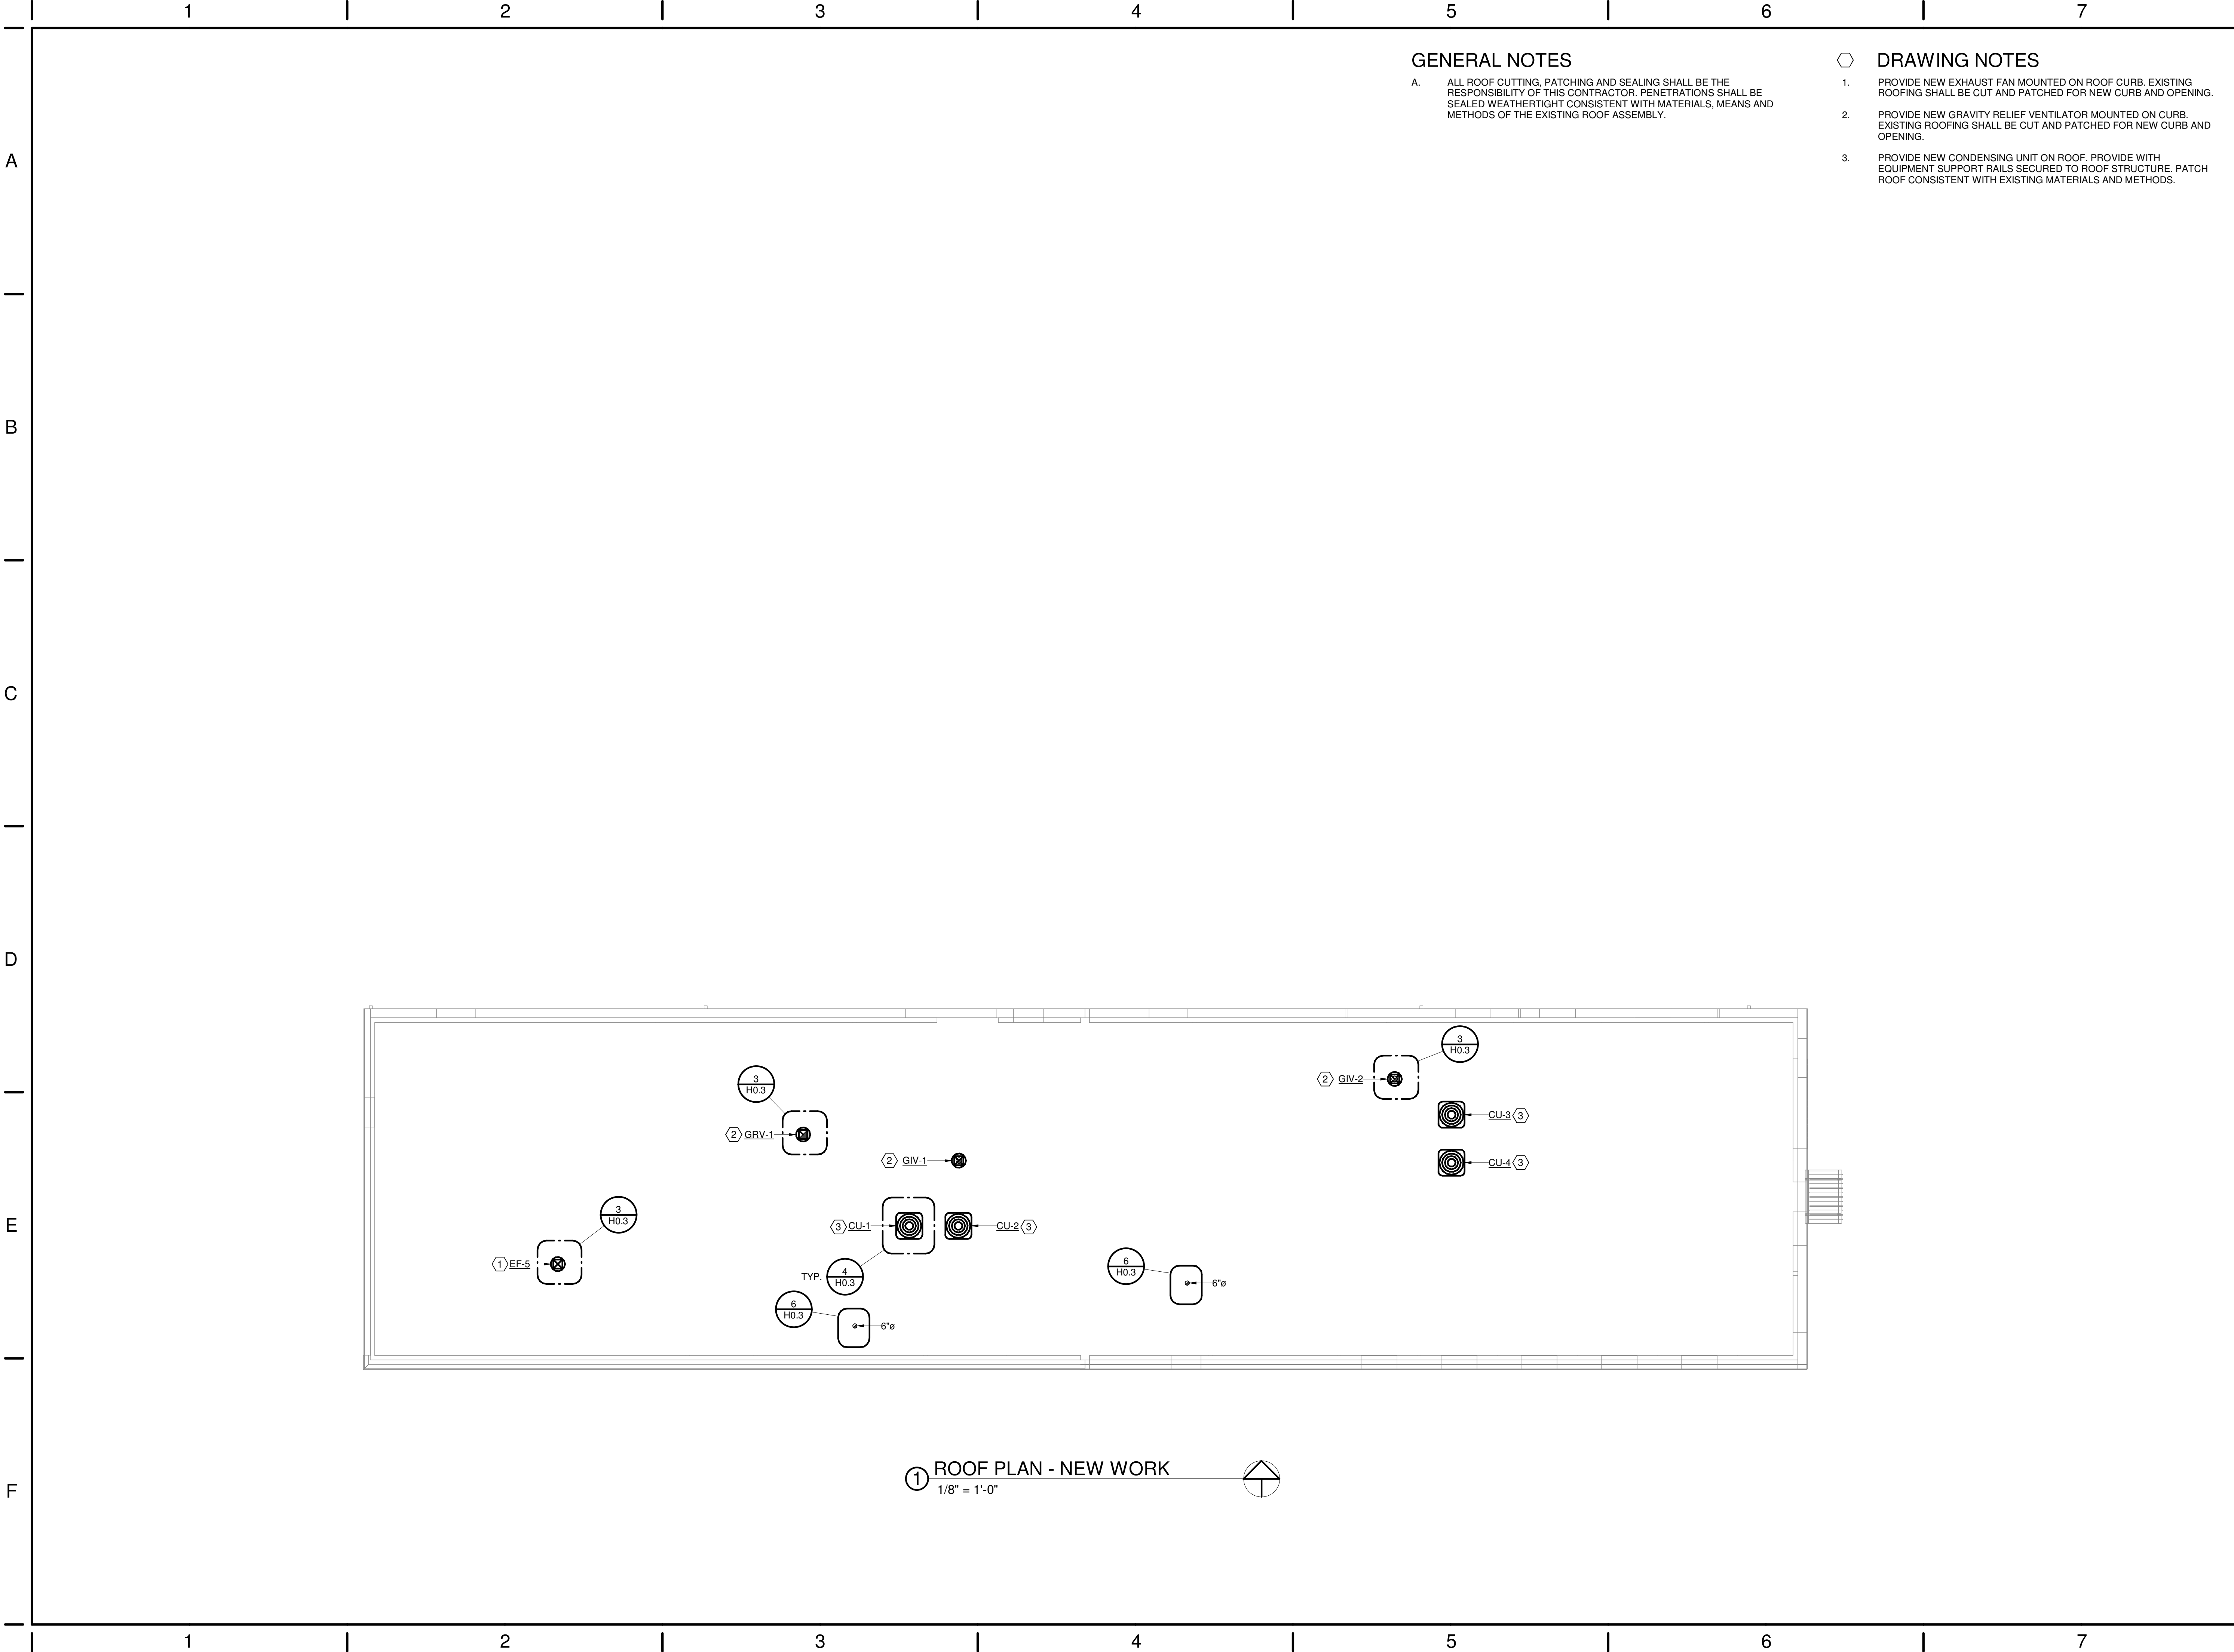
TITLE  
HVAC FLOOR PLAN -  
EAST - NEW WORK

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SHEET NO.

## H2.2






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TITLE  
**HVAC ROOF PLAN**

SHEET NO.  
**H2.3**

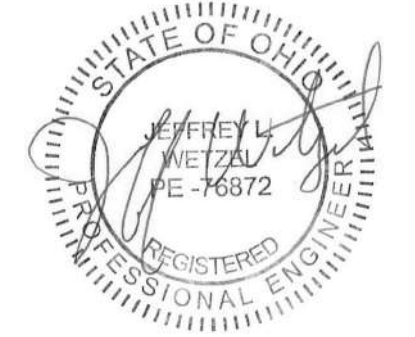

ALTERNATE DESCRIPTION


- A. AS A DEDUCT ALTERNATE, CONTRACTOR SHALL PROVIDE THE COST REDUCTION TO REDUCE THE BASE BID HVAC DESIGN FOR THE WEST AREA TO ONLY AS SHOWN ON THIS PLAN. THIS INCLUDES NOT INSTALLING THE FUR-1 FULL SYSTEM, EXHAUST FAN SYSTEMS EF-1, EF-2, EF-3 AND EF-5, GRAVITY VENTILATOR GIV-1 AND PORTION OF FUR-2 DUCT SYSTEM.
- B. REFER TO SHEET H2.1 FOR THE BASE BID HVAC SCOPE OF WORK.

GENERAL NOTES

- A. ALL DUCTWORK AND PIPING SHALL BE SEISMICALLY BRACED AND SUPPORTED FROM THE STRUCTURE BASED ON THE BUILDING BEING AN ESSENTIAL FACILITY. ALL SEISMIC BRACING CALCULATIONS AND DESIGN SHALL BE DELEGATED DESIGN AND THE RESPONSIBILITY OF THIS CONTRACTOR.

DRAWING NOTES

- GRILLE OPEN TO RETURN AIR PLENUM.
- DUCT UP THROUGH ROOF. TERMINATE WITH GOOSENECK WITH BIRDSCREEN.
- DUCT OPEN TO PLENUM SPACE.
- VENTILATION AIR INTAKE DUCT UP THROUGH ROOF TO INTAKE VENTILATOR. CONTRACTOR SHALL PATCH AND SEAL PENETRATION WEATHERTIGHT.
- PROVIDE VENTILATION AIR DUCT TO RETURN MAIN DUCT. PROVIDE WITH MANUAL BALANCE DAMPER. BALANCE VENTILATION AIR TO AIRFLOW INDICATED IN VENTILATION SCHEDULE.
- PROVIDE DUCT MOUNTED SMOKE DETECTOR. PROVIDE WITH VISUAL ALARM INDICATOR. INDICATOR SHALL BE MOUNTED IN CEILING OR WALL IN CORRIDOR FOR VISIBILITY. ALL WIRING BY E.C.
- PROVIDE SUPPLY DUCT PLENUM FROM UNIT UP INTO PLENUM SPACE.
- PROVIDE GAS FURNACE. UTILIZE UNIT FULL SIZE SIDE RETURN CONNECTION. PROVIDE WITH 2" WIDE FILTER. PROVIDE FLEXIBLE DUCT CONNECTION IN RETURN MAIN AND AT UNIT SUPPLY CONNECTION. ROUTE SCHEDULE 40 PVC VENT PIPING UP THROUGH ROOF AND TERMINATE PER MANUFACTURER GUIDELINES.
- PROVIDE TRANSFER AIR DUCT WITH 1" LINER UP FROM GRILLE THROUGH PLENUM AND ROOM WALL. REFER TO DETAIL ON SHEET H0.3 FOR SIZE.

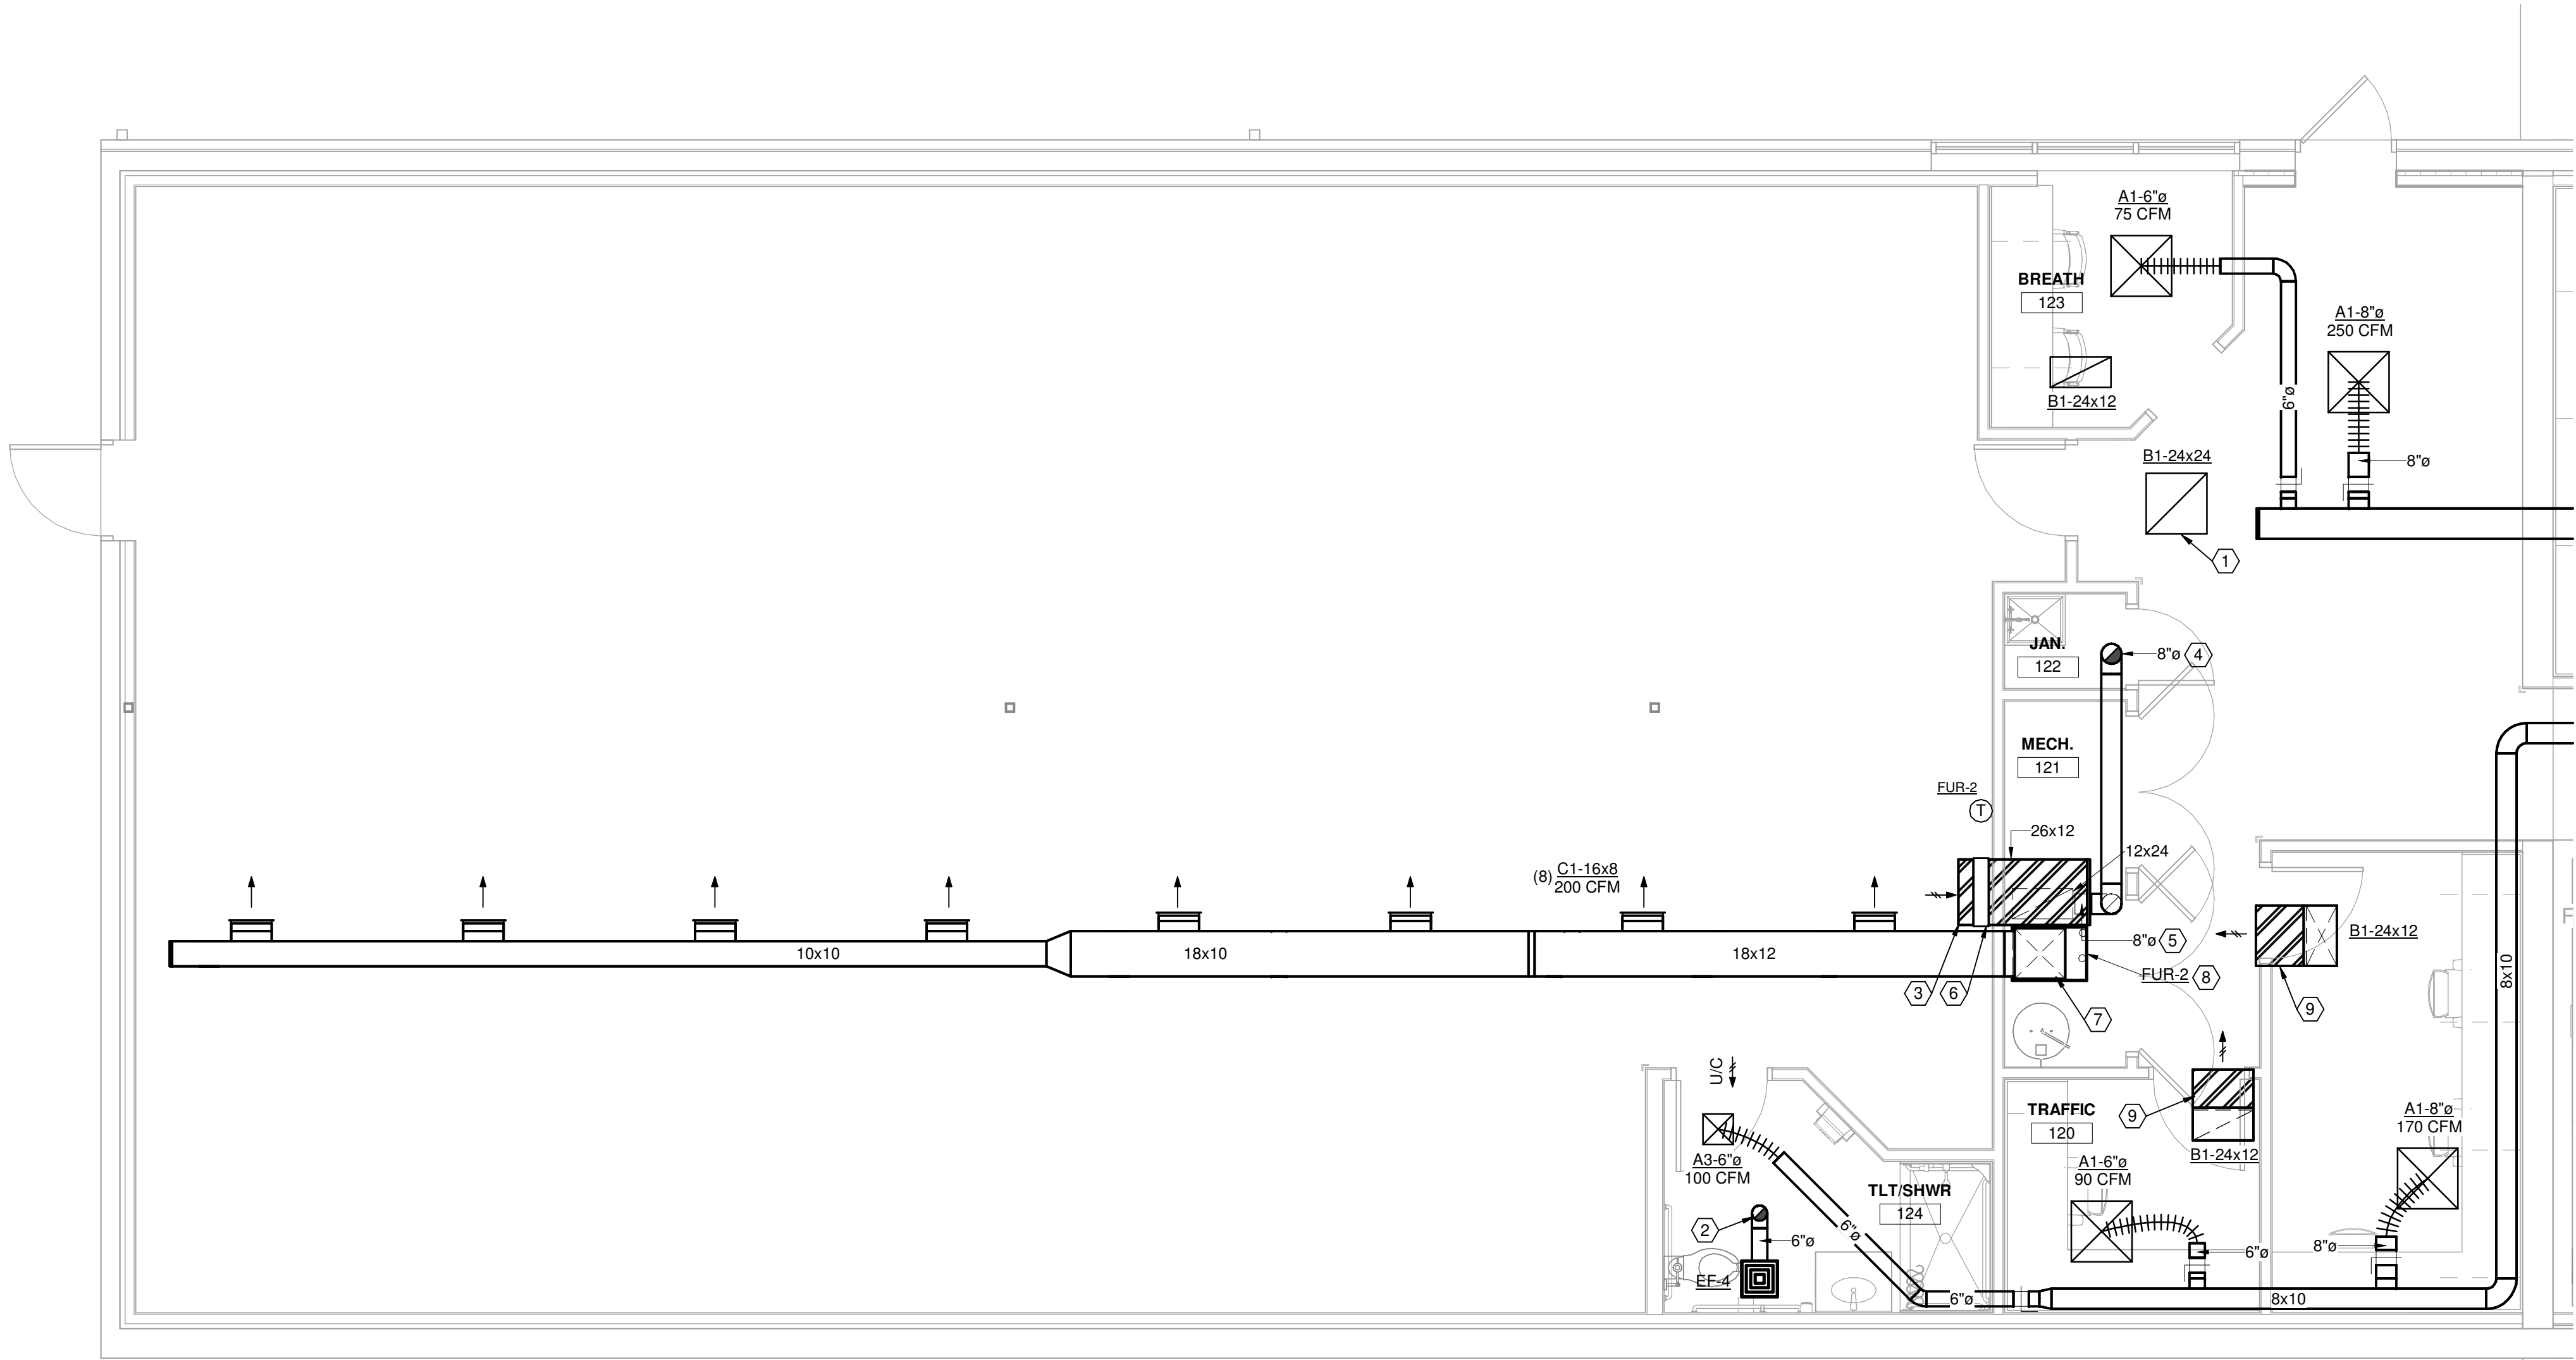

① HVAC ALTERNATE 1 PLAN - WEST  
1/4" = 1'-0"

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HVAC ALTERNATE PLAN

SHEET NO.  
**H2.4**



GENERAL LIGHTING/POWER NOTES

1. LIGHT FIXTURES DESIGNATED AS "NIGHT LIGHTS" SHALL BE ON UNSWITCHED CIRCUIT, UNLESS NOTED.
2. EXIT LIGHTS SHALL BE ON UNSWITCHED CIRCUIT, UNLESS NOTED.
3. ALL RECESSED DOWNLIGHTS MOUNTED IN GRID CEILING SHALL BE CENTERED IN CEILING TILE, UNLESS NOTED.
4. IN ALL MECHANICAL ROOMS, COORDINATE EXACT LOCATION OF LIGHT FIXTURES WITH HVAC DUCTWORK.
5. CONDUCTORS FOR BRANCH CIRCUITRY ARE #12 AWG MINIMUM, UNLESS NOTED. DERATE PER CODE WHERE CIRCUITS ARE COMBINED.
6. PROVIDE A GREEN GROUND CONDUCTOR IN ALL BRANCH CIRCUITRY. DERATE PER CODE WHERE CIRCUITS ARE COMBINED.
7. ALL CONDUIT DROPS FOR PLENUM RATED CABLES SHALL BE PROVIDED WITH A CONDUIT BUSHING ABOVE CEILING.
8. WHERE TERMINATED IN J-BOX, ALL SPARE CIRCUITRY SHALL BE LABELED WITH PANEL AND CIRCUIT NUMBER.
9. COORDINATE WITH MECHANICAL CONTRACTOR AND PROVIDE ALL NECESSARY AUXILIARY CONTACTS, RELAY, ETC. IN MOTOR STARTERS FOR REQUIRED CONTROL OF MECHANICAL EQUIPMENT.
10. DO NOT SUPPORT CONDUIT OFF OF CEILING GRID, CEILING GRID SUPPORTS, MECHANICAL SUPPORTS, OR ANY OTHER TRADE'S SUPPORTS. INSTALL CONDUITS AND BOXES ON SEPARATE SUPPORTS FROM BAR JOIST OR STRUCTURE.
11. COORDINATE OUTLET LOCATIONS FOR ALL KITCHEN AND BAR EQUIPMENT PRIOR TO ROUGH-IN.
12. NEW FIRE ALARM DEVICES SHOWN FOR REFERENCE ONLY. FINAL DESIGN AND PERMIT DRAWINGS TO BE PROVIDED BY FIRE ALARM MANUFACTURERS THROUGH A DELEGATED DESIGN APPROACH. ANNUNCIATING STROBES SHALL BE SYNCHRONIZED. PROVIDE ADEQUATE POWER FOR NEW PANELS TO SUPPORT ALL NEW DEVICES PROVIDING ADDITIONAL 20% CAPACITY ON NAC CIRCUIT.





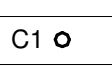

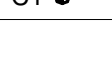







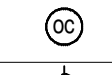

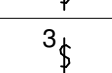
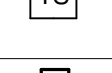
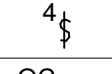
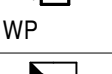
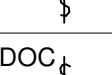

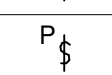
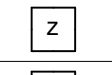

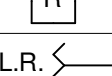
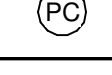






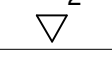
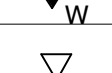
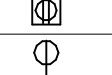


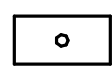




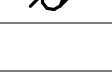



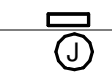
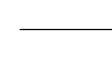
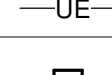


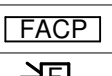
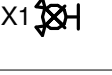
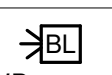
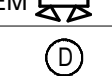

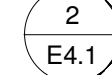

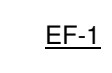

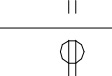


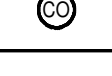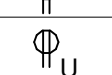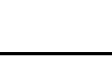

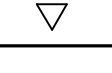ABBREVIATIONS

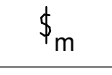
- AAMPS
- AFFABOVE FINISHED FLOOR
- AFGABOVE FINISHED GRADE
- BKRBREAKER
- CCONDUIT
- CATVCABLE TELEVISION
- CUHCABINET UNIT HEATER
- CKTCIRCUIT
- CU COPPER
- EEXISTING
- EFEXHAUST FAN
- ELECELECTRICAL
- EMEMERGENCY
- EMTEMERGENCY METALLIC TUBING
- FCUFAN COIL UNIT
- GGROUND
- GFIGROUND FAULT INTERRUPTER
- GRCGALVANIZED RIGID CONDUIT
- HPHORSEPOWER
- JJUNCTION BOX
- KVAKILOVOLT AMPERE
- KWKILOWATTS
- LGTLIGHTING
- MECHMECHANICAL
- NICNOT IN CONTRACT
- NLNIGHT LIGHT
- NTSNOT TO SCALE
- PVCPOLYVINYL CHLORIDE
- P PHASE (POLE)
- TTBT TELEPHONE TERMINAL BOX
- TTYPTYPICAL
- UONUNLESS OTHERWISE NOTED
- UVUNIT VENTILATOR
- VVOLTS
- VAVVARIABLE AIR VOLUME
- VIFVERIFY IN FIELD
- WWATTS
- WCWATER COOLER
- WPWEATHERPROOF
- UHUUNIT HEATER
- UNOUNLESS NOTED OTHERWISE

GENERAL PROJECT NOTES

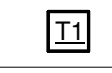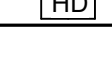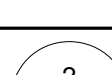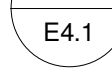1. WORK SHALL BE DONE IN ACCORDANCE WITH LOCAL, STATE OF OHIO, 2023 NEC AND NATIONAL CODES, RECOMMENDATIONS, REGULATIONS, AND REQUIREMENTS.
2. COORDINATE ELECTRICAL REQUIREMENTS FOR NEW WORK WITH THE PLUMBING AND MECHANICAL CONTRACTORS. VERIFY VOLTAGE, PHASE AND ACCESSORY REQUIREMENTS, SUCH AS MOTOR STARTERS AND DISCONNECTS.
3. CONTRACTOR SHALL PERFORM ALL CUTTING AND PATCHING AS REQUIRED FOR HIS WORK. OPENING IN WALLS, FLOORS AND CEILINGS SHALL BE FILLED IN, PATCHED, PAINTED AND FINISHED IN A MANNER TO MATCH THE QUALITY OF THE EXISTING, LIKE ADJACENT SURFACES.
4. NEW OPENINGS IN EXISTING WALLS AND FLOORS SHALL BE CORE DRILLED OR SAW CUT. OPENINGS IN NEW WALLS AND FLOORS SHALL BE PLANNED AND COORDINATED WITH GENERAL CONTRACTOR FOR THE INSTALLATION OF APPROPRIATE SLEEVES.
5. ALL CONDUIT SHALL BE 3/4" MINIMUM U.N.O. MC CABLE IS ALLOWED.
6. CONDUIT SHALL BE CONCEALED IN CEILING OR WALLS WHEREVER POSSIBLE.
7. ALL BRANCH CIRCUITS AND FEEDERS SHALL CONTAIN A GREEN INSULATED GROUND CONDUCTOR. GROUNDING BY MEANS OF RACEWAY IS NOT PERMITTED.
8. REFER TO MECHANICAL, PLUMBING, AND ARCHITECTURAL PLANS FOR EXACT LOCATION OF EQUIPMENT.
9. CONTRACTOR SHALL COORDINATE EXACT HEIGHT OF DEVICES DESIGNED AS OVER COUNTER WITH CASE WORK AND FURNITURE DRAWINGS.
10. VERIFY CEILING TYPES PER THE ARCHITECTURAL REFLECTED CEILING PLAN. PROVIDE APPROPRIATE TYPE FIXTURE, LAY-IN FOR GRID, FLANGE FOR DRYWALL, ETC.
11. VERIFY AND COORDINATE MOUNTING HEIGHTS AND LOCATIONS OF ALL DEVICES MOUNTED IN CASEWORK OR ABOVE COUNTERS WITH SPECIFIC EQUIPMENT FURNISHED.
12. NO MORE THAN 3 PHASE CONDUCTORS SHALL BE INSTALLED IN ANY ONE CIRCUIT, UNLESS NOTED OTHERWISE. EACH BRANCH CIRCUIT SHALL CONTAIN THEIR OWN NEUTRAL CONDUCTOR. NO SHARED NEUTRALS.
13. CONTRACTOR SHALL PROVIDE ALL FIRESTOPPING FOR CONDUIT OR CABLE TRAY PENETRATIONS THAT PENETRATE ACOUSTICAL RATED OR SMOKE AND FIRE RATED ASSEMBLIES. SEE ARCHITECTURAL DRAWINGS FOR LOCATIONS OF ALL RATED ASSEMBLIES. ALL RATED PENETRATIONS SHALL BE FIRESTOPPED TO ORIGINAL ASSEMBLY RATING. ALL NON-RATED FLOOR PENETRATIONS SHALL BE SEALED WATER TIGHT WITH A FLEXIBLE SEALANT.
14. PROVIDE ALL PULL BOXES, IN ACCESSIBLE AREA, THAT EXCEED NEC NUMBER OF BENDS OR LENGTH IN FEEDER AND BRANCH CIRCUITS. INSTALL BOXES WHERE REQUIRED PER CODE.
15. ALL WIRING DEVICES SHALL BE OF HEAVY DUTY COMMERCIAL GRADE CONSTRUCTION. REFER TO ARCHITECTURAL SHEETS AND CODE SHEET FOR ALL FIRE-RATED PARTITION LOCATIONS AND RATINGS. COORDINATE COLORS WITH ARCHITECT.
16. CONTRACTOR IS RESPONSIBLE FOR ALL CORE-DRILLS REQUIRED FOR INSTALLATION OF ELECTRICAL WORK.
17. ROUTING OF CIRCUITRY INSTALLED IN CASEWORK, CABINETRIES, ETC. SHALL BE COORDINATED FOR PROPER CONCEALMENT AND FUNCTION OF CASEWORK, CABINETRIES, ETC.
18. VERIFY THE LOCATION OF ALL UTILITIES PRIOR TO EXCAVATION, TRENCHING, OR DRILLING.
19. ALL ROOF PENETRATIONS OR PATCHES SHALL BE MADE PER ROOFING MANUFACTURER WARRANTY REQUIREMENTS.
20. ALL EXPOSED METAL CONDUITS ARE TO BE PAINTED TO MATCH THE ADJACENT SURFACE. COORDINATION OF PAINTING OF CONDUIT IS TO BE BY THE ELECTRICAL CONTRACTOR, WITH PAINTING BY OTHERS.
21. ELECTRICAL CONTRACTOR SHALL BE RESPONSIBLE FOR PROVIDING ALL REQUIRED JUNCTION BOXES, PULL BOXES, ETC FOR A COMPLETE INSTALLATION PER THE N.E.C. AND LOCAL CODES. ALL CONDUCTORS SHALL BE RATED FOR 90 DEGREE CELSIUS.
22. COORDINATE WORK WITH OTHER TRADES. COORDINATION OR SCHEDULING SHALL BE RESPONSIBILITY OF THE INVOLVED CONTRACTORS.
23. ALL LOW VOLTAGE CABLING INSTALLED IN SPACES WITHOUT A LAY-IN OR WITH A HARD CEILING SHALL BE INSTALLED IN CONDUIT AND BOXES.
24. ALL LOADS CALCULATED AND SHARED ON THESE PLANS ARE INTENDED FOR ENGINEERING USE ONLY AND NOT INTENDED TO BE USED BY ANYONE ELSE FOR ANY REASON. ANY USE OF THESE CALCULATIONS BY ANYONE OTHER THAN L2 ENGINEERING IS DONE AT THEIR OWN RISK.
25. FINAL COORDINATION WITH EQUIPMENT IS THE RESPONSIBILITY OF THE E.C. COORDINATION SHOWN ON PLANS IS FOR THE BASIS OF DESIGN. ANY CHANGES TO EQUIPMENT FOR ANY REASON MUST BE COORDINATED BY THE E.C. PRIOR TO ROUGH IN OR PURCHASING OF ELECTRICAL EQUIPMENT.

ELECTRICAL LEGEND

LIGHTING		FIRE ALARM	
A1	 LIGHTING FIXTURE. REFER TO FIXTURE SCHEDULE. LETTER INDICATES TYPE.	 FIRE ALARM PULL STATION, 44" AFF MOUNTING HEIGHT	
A1	 EMERGENCY LIGHTING FIXTURE WITH EMERGENCY BATTERY BACKUP. "NL" INDICATES NIGHT LIGHT CIRCUIT. REFER TO FIXTURE SCHEDULE FOR BATTERY REQUIREMENTS.	 FIRE ALARM HORN/STROBE. 80" AFF MOUNTING HEIGHT	
C1	 LIGHTING FIXTURE. LETTER INDICATES TYPE.	 FIRE ALARM DUCT MOUNTED SMOKE DETECTOR. S = SUPPLY, R = RETURN - COORDINATE WITH DUCTWORK. MAKE SAMPLING TUBE FULL WIDTH OF DUCT IN LENGTH. PROVIDE SMOKE DETECTOR FOR DAMPER OPERATION AND 120 VOLT POWER CONNECTION AS SHOWN ON THE POWER DRAWINGS. COORDINATE ALL CONNECTIONS WITH MECHANICAL CONTRACTOR. CONNECT TO ALARM SYSTEM.	
C1	 EMERGENCY LIGHTING FIXTURE WITH EMERGENCY BATTERY BACKUP.	 FIRE ALARM CEILING MOUNTED SMOKE DETECTOR.	
X1	 CEILING MOUNTED EXIT SIGN. REFER TO FIXTURE SCHEDULE. SHADED AREA DENOTES FACE(S) OF UNIT. CONNECT TO LOCAL UNSWITCHED LIGHTING CIRCUIT.	 FIRE ALARM ANNUNCIATOR PANEL.	
X1	 WALL MOUNTED EXIT SIGN. REFER TO FIXTURE SCHEDULE. SHADED AREA DENOTES FACE(S) OF UNIT. CONNECT TO LOCAL UNSWITCHED LIGHTING CIRCUIT.	 FIRE ALARM CONTROL PANEL.	
EM	 EMERGENCY EGRESS LIGHT. REFER TO FIXTURE SCHEDULE.	 FIRE ALARM STROBE. 80" AFF MOUNTING HEIGHT.	
	 CEILING MOUNTED DAYLIGHT SENSOR.	 BLUE EXTERIOR STROBE LIGHT FOR FIRE DEPARTMENT CONNECTION WP - WEATHERPROOF	
	 CEILING MOUNTED OCCUPANCY SENSOR.	 SPRINKLER SYSTEM FLOW SWITCH FURNISHED AND INSTALLED BY THE FIRE PROTECTION CONTRACTOR, CONNECTED BY ELECTRICAL CONTRACTOR.	
	 SINGLE POLE WALL SWITCH. 120/277 VOLT, 20 AMP. 44" AFF.	 SPRINKLER SYSTEM GATE VALVE. SUPERVISORY SWITCH FURNISHED AND INSTALLED BY THE FIRE PROTECTION CONTRACTOR, CONNECTED BY ELECTRICAL CONTRACTOR.	
	 THREE WAY WALL SWITCH. 120/277V, 20 AMP. 44" AFF	 FIRE ALARM STROBE. 80" AFF MOUNTING HEIGHT.	
	 FOUR WAY WALL SWITCH. 120/277V, 20 AMP. 44" AFF	 MAGNETIC DOOR HOLD OPEN.	
	 OCCUPANCY SENSOR WALL SWITCH. 120/277V, 20 AMP. 44" AFF	 FIRE ALARM REMOTE POWER SUPPLY.	
	 OCCUPANCY SENSOR WALL SWITCH WITH 0-10V DIMMING. 120/277V, 20 AMP. 44" AFF	 FIRE ALARM MONITOR MODULE.	
	 SINGLE POLE WALL SWITCH WITH PILOT LIGHT. 120/277V, 20 AMP. 44" AFF	 FIRE ALARM CONTROL RELAY MODULE.	
	 EXTERIOR LIGHT FIXTURE. ER, EXISTING TO REMAIN, PL1 - NEW FIXTURE. REFER TO FIXTURE SCHEDULE.	 END OF THE LINE RESISTOR.	
	 PHOTOCELL	 FIRE ALARM CONTROL RELAY MODULE.	
		 CARBON MONOXIDE DETECTOR	
POWER		DATA & COMMUNICATION	
	 DUPLEX RECEPTACLE. 120 VOLT, 20 AMP. 18" AFF UNO.	 DATA /COMMUNICATION OUTLET. TWO PORTS REFER TO DETAIL FOR MOUNTING REQUIREMENTS.	
	 DUPLEX RECEPTACLE WITH USB PLUG. 120 VOLT, 20 AMP. 18" AFF UNO.	 WALL PHONE. 54" AFF.	
	 DUPLEX RECEPTACLE MOUNTED AT 44" OR ABOVE BACKSPLASH. 120 VOLT, 20 AMP.	 DATA OUTLET. 18" AFF.	
	 DOUBLE DUPLEX RECEPTACLE. 120 VOLT, 20 AMP. 18" AFF UNO.	 DATA/COMMUNICATION. FOUR PORT DATA, 18" AFF.	
	 120 VOLT DOUBLE DUPLEX, 20 AMP RECEPTACLE MOUNTED AT 46" AFF OR 4" ABOVE BACKSPLASH.	 DATA/COMMUNICATION. FOUR PORT DATA, 18" AFF.	
	 DUPLEX RECEPTACLE WITH GROUND FAULT PROTECTION. 120 VOLT, 20 AMP. 18" AFF UNO, WP-WEATHERPROOF BOX	 WIRELESS ACCESS CONNECTION POINT WITH CEILING MOUNTED CISCO WIRELESS DEVICE.	
	 FLUSH FLOOR DUPLEX, DATA, AND AV RECEPTACLE IN FLOOR BOX		
	 120 VOLT SINGLE 20 AMP RECEPTACLE.		
	 DUPLEX RECEPTACLE. CEILING MOUNTED		
	 SPECIAL PURPOSE RECEPTACE. REFER TO FLOOR PLANS FOR NEMA CONFIGURATION.		
	 FRACTIONAL HP MOTOR STARTER WITH THERMAL OVERLOADS.		
	 ELECTRICAL MOTOR.		
	 HOMERUN TO PANELBOARD. NOTION INDICATES PANEL AND CIRCUIT NUMBER. (ALL CONDUCTORS SHALL BE #10 UNLESS NOTED OTHERWISE.)		
	 ELECTRICAL PANELBOARD.		
	 JUNCTION BOX.		
	 CONDUIT STUB-OUT AND CAP BELOW GRADE. MARK STUB-OUT AT GRADE LEVEL.		
	 UNDERGROUND HIGH VOLTAGE OR SECONDARY SERVICE FEED.		
	 SAFETY DISCONNECT SWITCH (NON-FUSED). 4X INDICATES ENCLOSURE TYPE.		
	 SAFETY DISCONNECT SWITCH (FUSED).		
	 COMBINATON MOTOR STARTER/DISCONNECT. WITH HOA SWITCH AT UNIT (FUSIBLE). OR (CIRCUIT BREAKER FOR ELEVATOR).		
	 TRANSFORMER (NUMBER INDICATES WHICH TRANSFORMER).		
	 HAND DRYER, VERIFY MOUNTING WITH SUPPLIER		
GENERAL		ELECTRICAL INDEX OF DRAWINGS	
	DETAIL # _____ DETAIL REFERENCE TAG, DRAWING # REFER TO DETAIL SHEETS	SHEET NUMBER	SHEET NAME
	KEYNOTE FOR DRAWING	E0.1	ELECTRICAL LEGEND AND GENERAL NOTES
	DETAIL REFERENCE TAG (SECTION)	E0.2	ELECTRICAL EQUIPMENT AND LIGHTING SCHEDULE
	MECHANICAL EQUIPMENT TAG. REFER TO EQUIPMENT DATA SCHEDULE.	E0.3	ELECTRICAL SPECIFICATIONS
	INDICATES NEW WORK.	E1.1	ELECTRICAL POWER AND LIGHTING - DEMOLITION
	INDICATES TO BE REMOVED.	E2.1	ELECTRICAL POWER AND LIGHTING - NEW WORK
	INDICATES EXISTING TO REMAIN.	E2.2	ELECTRICAL POWER AND LIGHTING - NEW WORK - ALTERNATE 1
		E3.1	ELECTRICAL POWER ROOF PLAN - NEW WORK
		E4.1	PANELBOARD SCHEDULES AND SINGLE LINE DIAGRAM

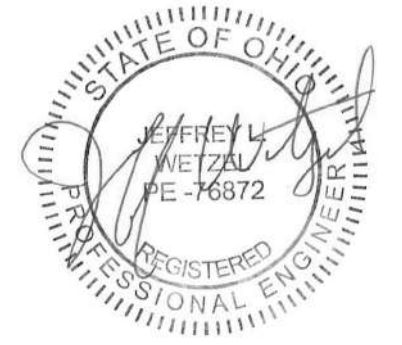

Harrison Township District 10  
Sheriff Substation Renovation

6001 N Dixie Dr, Dayton, OH 45414

ISSUE		
NO.	DATE	DESCRIPTION
	01/22/2026	FOR CONSTRUCTION

DATE	01.22.2026
JOB NO.	2025139
DRAWN	JZC
CHECKED	RLS

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TITLE  
ELECTRICAL LEGEND  
AND GENERAL NOTES

SHEET NO.

E0.1



A

B

C

D

E

F

EQUIPMENT ELECTRICAL DATA SCHEDULE																										
PLAN SYMBOL	DESCRIPTION/LOCATION	LOAD CHARACTERISTICS						STARTER						DISCONNECT					CTRL DEVICE			PANEL	CIRCUIT	FEEDER SIZE/ RACEWAY	NOTES	PLAN SYMBOL
		KW	HP	VOLTAGE	PHASE	FLA	SPEED DRIVE	TYPE	NEMA SIZE	FURNISH BY	INSTALL BY	AUXIL. RELAY	LOCATION	TYPE	FURNISH BY	INSTALL BY	SWITCH/ FUSE SIZE	LOCATION	TYPE	FURNISH BY	INSTALL BY					
CU-1	CONDENSING UNIT	-	-	208	1	14.08	-	-	-	-	-	-	-	-	-	-	30A	-	-	-	-	B	7,9	(2) #10 (1) #10 GDN IN .75"C	-	CU-1
CU-2	CONDENSING UNIT	-	-	208	1	23.28	-	-	-	-	-	-	-	-	-	-	40A	-	-	-	-	B	8,10	(2) #8 (1) #10 GDN IN 1"C	-	CU-2
CU-3	CONDENSING UNIT	-	-	208	1	24.88	-	-	-	-	-	-	-	-	-	-	50A	-	-	-	-	B	1,3	(2) #8 (1) #10 GDN IN 1"C	-	CU-3
CU-4	CONDENSING UNIT	-	-	208	1	24.88	-	-	-	-	-	-	-	-	-	-	50A	-	-	-	-	B	2,4	(2) #8 (1) #10 GDN IN 1"C	-	CU-4
FUR-1	FURNACE	-	-	120	1	13.52	-	-	-	-	-	-	-	-	-	-	15A	-	-	-	-	B	11	(2) #12 (1) #12 GRD IN .75"C	-	FUR-1
FUR-2	FURNACE	-	-	120	1	13.36	-	-	-	-	-	-	-	-	-	-	15A	-	-	-	-	B	12	(2) #12 (1) #12 GRD IN .75"C	-	FUR-2
FUR-3	FURNACE	-	-	120	1	13.36	-	-	-	-	-	-	-	-	-	-	15A	-	-	-	-	B	13	(2) #12 (1) #12 GRD IN .75"C	-	FUR-3
FUR-4	FURNACE	-	-	120	1	13.36	-	-	-	-	-	-	-	-	-	-	15A	-	-	-	-	B	14	(2) #12 (1) #12 GRD IN .75"C	-	FUR-4
EF-1	EXHAUST FAN	-	.01	120	1	-	-	-	-	-	-	-	-	-	-	-	20A	-	-	-	-	A	37	(2) #12 (1) #12 GRD IN .75"C	-	EF-1
EF-2	EXHAUST FAN	-	.01	120	1	-	-	-	-	-	-	-	-	-	-	-	20A	-	-	-	-	A	37	(2) #12 (1) #12 GRD IN .75"C	-	EF-2
EF-3	EXHAUST FAN	-	.01	120	1	-	-	-	-	-	-	-	-	-	-	-	20A	-	-	-	-	A	37	(2) #12 (1) #12 GRD IN .75"C	-	EF-3
EF-4	EXHAUST FAN	-	.01	120	1	-	-	-	-	-	-	-	-	-	-	-	20A	-	-	-	-	A	37	(2) #12 (1) #12 GRD IN .75"C	-	EF-4
EF-5	EXHAUST FAN	-	.01	120	1	-	-	-	-	-	-	-	-	-	-	-	20A	-	-	-	-	A	37	(2) #12 (1) #12 GRD IN .75"C	-	EF-5
EF-6	EXHAUST FAN	-	.01	120	1	-	-	-	-	-	-	-	-	-	-	-	20A	-	-	-	-	A	37	(2) #12 (1) #12 GRD IN .75"C	-	EF-6
ABBREVIATIONS:																										
CC - CONTROL CONTRACTOR		FS - FUSED SWITCH				GC - GENERAL CONTRACTOR				VC - VENTILATION CONTRACTOR																
CP - CORD/PLUG		FSC - FIRE SUPPRESSION CONTRACTOR				HC - HEATING CONTRACTOR				TS - THERMOSTAT																
EC - ELECTRICAL CONTRACTOR		FSEC - FOOD SERVICE EQUIP. CONTRACTOR				PC - PLUMBING CONTRACTOR				NFS - NON FUSED SWITCH																
ES - EQUIPMENT SUPPLIER		FVNR - FULL VOLTAGE NON-REVERSING				SC - SPRINKLER CONTRACTOR				SW - HORSEPOWER RATED SWITCH																
NOTES:																										
1 - XXX																										

LIGHTING FIXTURE SCHEDULE																				
FIXTURE SYMBOL	FIXTURE VOLTAGE	FIXTURE INPUT WATTS	TEMPERATURE (K)	DELIVERED LUMENS	MANUFACTURER AND MODEL NUMBER	OTHER ACCEPTABLE MANUFACTURER	DIFFUSER MEDIA	CLASSIFICATION	TRIM COLOR						MOUNTING	SIZE (IN.)			NOTES	
								EM - EMERGENCY N - NORMAL HAZ - HAZARDOUS HB - HIGH BAY LB - LOW BAY HM - HIGH MAST	WHITE	NICKEL	CHROME	BRUSHED NICKEL	STANDARD	SEE NOTE	S - SURFACE R - RECESSED SM - STEM MTD. WM - WALL MTD. C - CHAIN MTD. UC - UNDER CAB. CS - CEIL. SURF.	DIAMETER OR WIDTH	LENGTH	DEPTH		
A1	UNV	24	3500	3061	ILP #DNT4-30L-U-935	AS PRE-APPROVED	ACRYLIC	N	X							S	2.8	49.3	2.5	-
B1	UNV	30	3500	3684	ILP #VPAN22-33L-U-35	AS PRE-APPROVED	FROSTED ACRYLIC	N	X							R	24.1	24.1	5.2	-
B2	UNV	28	3500	3578	ILP #VPAN24-33L-U-35	AS PRE-APPROVED	FROSTED ACRYLIC	N	X							R	24.1	48.1	5.2	-
C1	UNV	17	3500	2030	GREENCREATIVE #SLFT-6-9-CCT5S-DUALDIM	AS PRE-APPROVED	POLYCARBONATE	N	X							R	6	DIA	4.12	-
-	-	-	-	-	-	AS PRE-APPROVED	-	-	X	X	X	X	X	X		-	-	-	-	-
-	-	-	-	-	-	AS PRE-APPROVED	-	-	X	X	X	X	X	X		-	-	-	-	-
X1	-	-	-	-	COMPASS #CCR	AS PRE-APPROVED	EMERGENCY EGRESS	EM	X							UNIVERSAL	19.25	8.125	1.75	-
ER	-	-	-	-	COMPASS #CORS	AS PRE-APPROVED	EMERGENCY EGRESS	EM	X							WM-8'-0"	4.5	DIA	6.7	-
17 17	-	-	-	-	COMPASS #CU2	AS PRE-APPROVED	EMERGENCY EGRESS	EM	X							WM-8'-0"	4	9	2.75	-
NOTES:																				
1. BLACK/ GOLD.																				

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STATE OF OHIO

JEFFREY A. WETZEL

REGISTERED PROFESSIONAL ENGINEER

NO. 166372

Harrison Township District 10

Sheriff Substation Renovation

6001 N Dixie Dr, Dayton, OH 45414

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DRAWN JZC

CHECKED RLS

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TITLE  
ELECTRICAL EQUIPMENT  
AND LIGHTING  
SCHEDULE

SHEET NO.  
E0.2



ELECTRICAL SPECIFICATIONS

GENERAL PROVISIONS

A. REFERENCE

1. THE GENERAL CONDITIONS AND OTHER CONTRACT DRAWINGS AS SET FORTH IN THE FOREGOING PAGES ARE HEREBY INCORPORATED INTO AND BECOME A PART OF THE SPECIFICATIONS FOR WORK UNDER THIS PROJECT, INsofar AS THEY APPLY HERETO.
2. ALL SPECIFICATIONS UNDER THIS DIVISION TITLE ARE DIRECTED TO AND ARE THE RESPONSIBILITY OF THE ELECTRICAL CONTRACTOR, UNLESS OTHER TRADES OR PERSONS ARE SPECIFICALLY MENTIONED, "ELECTRICAL CONTRACTOR" IS INFERRED AND INTENDED.

B. CONTRACT DRAWINGS

1. THE DRAWINGS ACCOMPANYING THESE SPECIFICATIONS ARE COMPLEMENTARY EACH TO THE OTHER AND WHAT IS CALLED FOR BY ONE SHALL BE AS IF CALLED FOR BY BOTH.
2. CONSULT ALL CONTRACT DRAWINGS WHICH MAY AFFECT THE LOCATION OF EQUIPMENT, CONDUIT AND WIRING AND MAKE MINOR ADJUSTMENTS IN LOCATION TO SECURE COORDINATION.
3. WIRING LAYOUT IS SCHEMATIC AND EXACT LOCATIONS SHALL BE DETERMINED BY FIELD CONDITIONS.
4. OTHER THAN MINOR ADJUSTMENTS SHALL BE SUBMITTED TO THE OWNER'S REPRESENTATIVE FOR APPROVAL BEFORE PROCEEDING WITH THE WORK.

C. JOB-SITE COPY OF DOCUMENTS

1. MAINTAIN AT THE SITE, ONE COPY OF ALL DRAWINGS, SPECIFICATIONS, ADDENDA APPROVED SHOP DRAWINGS, CHANGE ORDERS AND OTHER MODIFICATIONS, IN GOOD ORDER AND MARKED TO RECORD ALL CHANGES MADE DURING CONSTRUCTION. THESE SHALL BE AVAILABLE TO THE OWNER'S REPRESENTATIVE. THE DRAWINGS MARKED TO RECORD ALL CHANGES MADE DURING CONSTRUCTION SHALL BE DELIVERED TO THE OWNER'S REPRESENTATIVE FOR THE OWNER UPON COMPLETION OF THE WORK. AN ADDITIONAL SET OF DRAWINGS WILL BE FURNISHED BY THE OWNER'S REPRESENTATIVE FOR THIS PURPOSE UPON REQUEST.

D. MANUFACTURER'S DRAWINGS

1. THE CONTRACTOR SHALL SUBMIT TO THE ARCHITECT FOR REVIEW, (4) COPIES OF MANUFACTURER'S DRAWINGS AND WIRING DIAGRAMS (OR ELECTRONIC SUBMITTALS IN PDF FORMAT), THE ENGINEER WILL REVIEW CONTRACTOR'S SHOP DRAWINGS AND RELATED SUBMITTALS (AS INDICATED BELOW) WITH RESPECT TO THE ABILITY OF THE DETAILED WORK, WHEN COMPLETE, TO BE A PROPERLY FUNCTIONING INTEGRAL ELEMENT OF THE OVERALL SYSTEM DESIGNED BY THE ENGINEER. BEFORE SUBMITTING A SHOP DRAWING OR ANY RELATED MATERIAL TO THE ENGINEER, CONTRACTOR SHALL: REVIEW EACH SUCH SUBMISSION FOR CONFORMANCE WITH THE MEANS, METHODS, TECHNIQUES, SEQUENCES, AND OPERATIONS OF CONSTRUCTION, AND SAFETY PRECAUTIONS AND PROGRAMS INCIDENTAL THERETO, ALL OF WHICH ARE THE SOLE RESPONSIBILITY OF CONTRACTOR; APPROVE EACH SUCH SUBMISSION BEFORE SUBMITTING IT; AND SO STAMP EACH SUCH SUBMISSION BEFORE SUBMITTING IT. THE ENGINEER SHALL ASSUME THAT NO SHOP DRAWING OR RELATED SUBMITTAL COMPRISES A VARIATION UNLESS CONTRACTOR ADVISES ENGINEER OTHERWISE VIA A WRITTEN INSTRUMENT WHICH IS ACKNOWLEDGED BY ENGINEER IN WRITING. THE ITEMS, TYPES OF SUBMITTALS AND RELATED MATERIAL (IF ANY) CALLED FOR ARE INDICATED BELOW:

ITEMS SHOP DRAWINGS TYPE SUBMITTALS REQUIRED

LIGHTING FIXTURES  
WIRING DEVICES  
LIGHTING CONTROLS

E. GUARANTEES

1. THE ELECTRICAL CONTRACTOR SHALL BE RESPONSIBLE FOR ALL DEFECTS, REPAIRS AND REPLACEMENTS IN MATERIALS AND WORKMANSHIP FOR A PERIOD OF ONE (1) YEAR AFTER DATE OF SUBSTANTIAL COMPLETION AS DETERMINED BY THE OWNER'S REPRESENTATIVE. PRODUCT GUARANTEES GREATER THAN ONE (1) YEAR SHALL BE PASSED ALONG TO THE OWNER FOR FULL BENEFIT OF THE MANUFACTURER'S WARRANTY.

WORK INCLUDED

A. INSTALLATION, MATERIALS, AND WORKMANSHIP

6. FURNISH AND INSTALL ALL NECESSARY ANCHORS, SUPPORTS, STRAPS, BOXES, FITTINGS AND OTHER SIMILAR APPURTENANCES NOT INDICATED ON THE DRAWINGS BUT WHICH ARE REQUIRED FOR A COMPLETE AND PROPERLY INSTALLED SYSTEM CONSISTENT WITH THE ARCHITECTURAL TREATMENT OF THE BUILDING.
7. THE ELECTRICAL CONTRACTOR, INsofar AS THE WORK IS CONCERNED, SHALL AT ALL TIMES KEEP THE PREMISES IN A NEAT AND ORDERLY CONDITION, AND AT THE COMPLETION OF THE WORK, SHALL PROPERLY CLEAN UP AND CART AWAY DEBRIS AND EXCESS MATERIALS. ELECTRICAL CONTRACTOR SHALL BE RESPONSIBLE FOR THE COST OF DUMPSTER & REFUSE DISPOSAL AS REQUIRED FOR ELECTRICAL WORK.
8. ALL MATERIALS SHALL BE NEW AND UNDETERIORATED AND OF A QUALITY NOT LESS THAN THE MINIMUM SPECIFIED.

B. COORDINATION OF PLANS AND SPECIFICATIONS

1. CONTACT THE OWNER'S REPRESENTATIVE IMMEDIATELY IF THERE IS ANY QUESTIONS REGARDING THE MEANING OR INTENT OF EITHER PLANS OR SPECIFICATIONS, OR UPON NOTICING ANY DISCREPANCIES OR OMISSIONS IN EITHER PLANS OR SPECIFICATIONS.

C. CUTTING AND PATCHING

1. PATCHING SHALL MATCH EXISTING SURFACES IN KIND AND FINISH AND SHALL BE DONE BY THE GENERAL CONTRACTOR AT THE ELECTRICAL CONTRACTOR'S EXPENSE.
2. REPAIR OF DAMAGES, BY THE ELECTRICAL CONTRACTOR, TO NEWLY PATCHED AND REFINISHED AREAS SHALL BE DONE BY THE GENERAL CONTRACTOR AT THE ELECTRICAL CONTRACTOR'S EXPENSE, TO MATCH EXISTING CONDITION.
3. WHERE REQUIRED TO MAINTAIN FIRE RATING, OPENINGS SHALL BE SEALED UTILIZING 3M BRAND FIRE BARRIER PENETRATION SEALING SYSTEMS. FIRE BARRIER OR FIRE STOP SYSTEMS FROM CROUSE-HINDS, THOMAS & BETTS OR DOW CORNING MAY BE USED AT CONTRACTOR'S OPTION. THIS INCLUDES HOLES LEFT DUE TO REMOVAL OF EXISTING CONDUITS, BUS DUCT, ETC. OPENINGS SHALL BE TEMPORARILY FIRE STOPPED UNTIL PERMANENT FIRE STOPPING IS DONE.

D. CLEANING AND PAINTING

1. ALL ELECTRICAL EQUIPMENT SHALL BE KEPT DRY AND CLEAN DURING THE CONSTRUCTION PERIOD. INTERIOR OF ALL ENCLOSURES SHALL BE CLEANED OF DIRT AND DEBRIS BEFORE INSTALLING TRIM OR COVERS.
2. ALL FINISHED SURFACES OF EQUIPMENT FURNISHED UNDER THIS CONTRACT SHALL BE THOROUGHLY CLEANED OF DIRT AND ALL SCRATCHED OR DAMAGED SURFACES SHALL BE TOUCHED UP WITH MATCHING MATERIALS BEFORE FINAL ACCEPTANCE OF THE WORK.
3. WHEN ALL WORK IS COMPLETED AND ALL WORK HAS BEEN SATISFACTORILY TESTED AND ACCEPTED BY THE OWNER'S REPRESENTATIVE, ALL CONDUIT AND OTHER EXPOSED SURFACES SHALL BE THOROUGHLY CLEANED.

CODES AND FEES

A. CODES:

1. ALL WORK PERFORMED UNDER THIS SPECIFICATION SHALL BE DONE IN ACCORDANCE WITH THE LATEST EDITION OF THE NATIONAL ELECTRICAL CODE AS PREPARED AND PUBLISHED BY THE NATIONAL FIRE PROTECTION ASSOCIATION AND ANY APPLICABLE STATE OR LOCAL CODES.

B. FEES:

1. OBTAIN AND PAY FOR ANY AND ALL PERMITS REQUIRED BY ALL LAWS AND REGULATIONS AND PUBLIC AUTHORITY HAVING SUCH JURISDICTION.

TESTS AND SPECIFICAIONS

- A. OBTAIN ALL INSPECTIONS REQUIRED BY ALL LAWS, ORDINANCES, RULES, REGULATIONS OR PUBLIC AUTHORITY HAVING JURISDICTION AND OBTAIN CERTIFICATES OF SUCH INSPECTIONS AND SUBMIT SAME TO THE OWNER'S REPRESENTATIVE. PAY ALL FEES, CHARGES AND OTHER EXPENSES IN CONNECTION THEREIN. OBTAIN OCCUPANCY PERMIT AS REQUIRED BY OWNER. FINAL PAYMENT SHALL NOT BE MADE UNTIL OCCUPANCY PERMIT IS OBTAINED.
- B. WORK SHALL BE UNACCEPTABLE WHEN FOUND TO BE DEFECTIVE OR CONTRARY TO THE PLANS SPECIFICATIONS, CODES SPECIFIED OR ACCEPTED STANDARDS OF GOOD WORKMANSHIP.
- C. THE CONTRACTOR SHALL PROMPTLY CORRECT ALL WORK FOUND UNACCEPTABLE BY THE OWNER'S REPRESENTATIVE WHETHER OBSERVED BEFORE OR AFTER SUBSTANTIAL COMPLETION AND WHETHER OR NOT FABRICATED, INSTALLED OR COMPLETED. THE CONTRACTOR SHALL BEAR ALL COSTS OF CORRECTING SUCH UNACCEPTABLE WORK, INCLUDING COMPENSATION FOR THE OWNERS REPRESENTATIVE ADDITIONAL SERVICES MADE NECESSARY THEREBY.
- D. THE ELECTRICAL CONTRACTOR SHALL TEST AND OBTAIN ACCEPTANCE FOR THE FOLLOWING SYSTEMS:
1. EMERGENCY LIGHTING.  
2. RECEPTACLE AND EQUIPMENT POWER.  
3. LIGHTING.  
4. LIGHTING CONTROLS

CONDUIT

- A. FURNISH AND INSTALL ALL CONDUITS, BOXES, FITTINGS, ETC., FOR A COMPLETE RACEWAY SYSTEM.
- B. ALL WIRING SHALL BE RUN IN EMT CONDUIT OR MC CABLE UNLESS OTHERWISE NOTED.
- C. ALL CONDUIT SIZES STATED HEREIN OR MARKED ON THE DRAWINGS ARE MINIMUM SIZE AND SHALL BE NO LESS THAN 1/2" UNLESS OTHERWISE NOTED.
- D. ALL CONDUIT SHALL BE SUBSTANTIALLY SUPPORTED BY PIPE STRAPS OR SUITABLE CLAMPS OR HANGERS ATTACHED TO THE ELEMENTS OF THE BUILDING STRUCTURE TO PROVIDE RIGID INSTALLATION; IN NO CASE SHALL CONDUIT BE ATTACHED OR SUPPORTED FROM ADJOINING PIPE OR INSTALLED IN SUCH A MANNER AS TO PREVENT THE READY REMOVAL OF OTHER PIPE FOR REPAIRS. "MINERALAC" TYPE SUPPORTS AND "UNISTRUT" TYPE ONE BOLT SUPPORTS WITH SQUARE ENDS SHALL NOT BE USED AT ANY LOCATION.

WIRE AND CABLE

- A. ALL CONDUCTORS SHALL BE STRANDED AND OF THE AWG SIZE AND TYPE SHOWN ON THE DRAWINGS. WHERE NO SIZE OR TYPE IS SHOWN, CONDUCTORS SHALL NOT BE LESS THAN #12 TYPE XHHW, THHN, OR THWN. ALL CONDUCTORS SHALL BE COPPER AND HAVE 600 VOLT INSULATION; BE UL LABELED AND OF AMERICAN MANUFACTURER.
- B. ALL CONNECTIONS ARE TO BE MADE USING PRESSURE TYPE TERMINALS.
- C. THE FOLLOWING COLOR CODE SHALL BE USED:

208 VOLT

PHASE A BLACK  
PHASE B RED  
PHASE C BLUE  
NEUTRAL WHITE  
EQUIPMENT GROUND GREEN

- D. CONDUCTORS NO. 10 AWG OR SMALLER SHALL HAVE INSULATION COLORED AS NOTED ABOVE.

- E. CONDUCTORS NO. 8 AWG OR LARGER SHALL HAVE INSULATION COLORED AS NOTED ABOVE OR COLORED TAPE, MINIMUM SIZE 1/2", WRAPPED TWICE AROUND AT THE FOLLOWING POINTS:
1. AT EACH TERMINAL.  
2. AT EACH CONDUIT ENTRANCE.  
3. AT INTERVALS NOT MORE THAN 12 INCHES APART.  
4. IN ALL BOXES, PANEL TUBS, SWITCHBOARDS, ETC.

- F. ALL BRANCH CIRCUITS SHALL BE MARKED IN THE PANELBOARD GUTTERS. MARKERS SHALL INDICATE CORRESPONDING BRANCH-CIRCUIT NUMBERS.

- G. EACH BRANCH CIRCUIT REQUIRING A NEUTRAL SHALL BE FURNISHED WITH A SEPARATE INDIVIDUAL NEUTRAL CONDUCTOR.

BOXES AND PLATES

- A. FURNISH AND INSTALL ALL OUTLET, JUNCTION, AND PULLBOXES AS INDICATED ON THE DRAWINGS AND AS NECESSARY TO INSTALL THE REQUIRED CONDUIT AND WIRING IN A NEAT AND WORKMANLIKE MANNER.
- B. PULLBOXES AND JUNCTION BOXES SHALL BE GALVANIZED AND OF THE CORRECT SIZE AND SIZE AND GAUGE, IN ACCORDANCE WITH CODE REQUIREMENTS AND SHALL BE UL LABELED.
- C. FLUSH OUTLET, JUNCTION AND PULLBOXES SHALL BE PRESSED STEEL GALVANIZED OR SHERARDIZED AND SHALL BE A MINIMUM OF 4" SQUARE OR OCTAGONAL SIMILAR TO APPLETON #40.
- D. SWITCH PLATES ON FLUSH AND CAST BOXES SHALL BE SIERRA NOS. P-1, P-2, P-3 ETC., AS REQUIRED, AND SHALL BE MADE OF BLACK PLASTIC.
- E. DUPLEX RECEPTACLE PLATES ON FLUSH AND CAST BOXES SHALL BE SIERRA NO. P-8 BLACK PLASTIC.
- F. ALL BOXES SHALL BE RIGIDLY SUPPORTED FROM BUILDING STRUCTURE INDEPENDENT OF THE CONDUIT SYSTEM. BOXES CAST INTO MASONRY OR CONCRETE ARE CONSIDERED TO BE RIGIDLY SUPPORTED.

SWITCHES

- A. 120V-20A LEGRAND #CS20AAC1BK, HUBBELL #CS120BK, EATON #CS120BK
- 120V-20A 3-WAY LEGRAND #CS20AAC3BK, HUBBELL #CS320BK, EATON #CS320BK
- 120V-20A 4-WAY LEGRAND #CS20AAC4BK, HUBBELL #CS420BK, EATON #CS420BK
- 120V-20A OC LEGRAND #DSW-301-BK, HUBBELL #AD200BK22, EATON #OSD10A-BK
- 120V-20A DOC LEGRAND #DW-311-BK, HUBBELL #ADD2000BK1, EATON #OS10D7-BK
- 120V-20A PILOT LEGRAND #692WG, HUBBELL #HBL1221PL, EATON #AH1221PL

RECEPTACLES

- A. 120V-20A LEGRAND #CR20BK, HUBBELL #CR20BK, EATON #CR20BK
- 120V-20A TR LEGRAND #TR20BK, HUBBELL #CR20BKTR, EATON #TRCR20BK
- 120V-20A GF LEGRAND #2097TRABK, HUBBELL #GFTR20BK, EATON #SGF20BK
- 120V-20A USB LEGRAND #TR20USBAC6BK, HUBBELL #USB20ACPD0BK, EATON #TRUSBPDAC20BK
- 120V-20A WP/GF LEGRAND #2097TRWRBK, HUBBELL #GFRTW20BK, EATON #TWRSGF20BK

WIRING DEVICES

- A. WIRING DEVICES SHALL BE FURNISHED IN STRICT ACCORDANCE WITH THE CATALOG NUMBERS AND MANUFACTURERS LISTED IN THE SCHEDULE WHICH FOLLOWS. OTHER SPECIAL PURPOSE DEVICES SHALL BE AS SPECIFIED ON THE DRAWINGS.
- B. COORDINATE DEVICE COLOR WITH ARCHITECT.

IDENTIFICATION


- H. EACH PIECE OF ELECTRICAL EQUIPMENT AND INDIVIDUAL SWITCHES, ALL DISCONNECTS, STARTERS ALL EXHAUST FAN MANUAL STARTING SWITCHES, ALL POWER AND LIGHTING PANELS, ALL CABINETS AND PULL BOXES, ETC., SHALL BE IDENTIFIED ON THE FRONT COVER OR TRIM WITH ITS NAME AND/OR DESIGNATION NUMBER OR LETTER AS SHOWN ON THE DRAWINGS AND WITH THE VOLTAGE AVAILABLE WITHIN THE PANEL.
- I. IDENTIFICATION SHALL BE IN THE FORM OF LAMINATED PLASTIC NAMEPLATES, BLACK FACE, WITH THE LETTERS ENGRAVED INTO THE WHITE BACKGROUND, MINIMUM 1/4" HIGH. PLATES SHALL BE DRILLED ON EACH END FOR SHEETMETAL SCREW ATTACHMENT, NO "DYMO" OR SIMILAR TYPE LABELS WILL BE ALLOWED.
- J. THE FOLLOWING IS AN EXAMPLE OF THE NAMEPLATE LAYOUT AND WORDING:
- AC-1 DISCONNECT  
208V - 1Ø CKT B-1,2
- K. PLASTIC NAMEPLATES SHALL BE ATTACHED TO FACE OF ELECTRICAL DEVICE BY SHEETMETAL SCREWS. LOCATE PLATE SO WORDING READS HORIZONTALLY AND PLATE DOES NOT OBSTRUCT OTHER IDENTIFICATION PLATES, LATCHES OR OPERATORS.
- L. WHERE CIRCUIT BREAKERS OR FUSES ARE APPLIED IN COMPLIANCE WITH THE SERIES COMBINATION RATINGS MARKED ON THE EQUIPMENT BY THE MANUFACTURER, THE EQUIPMENT ENCLOSURE(S) SHALL BE LEGIBLY MARKED IN THE FIELD TO INDICATE THE EQUIPMENT HAS BEEN APPLIED WITH A SERIES COMBINATION RATING. THE MARKING SHALL BE READILY VISIBLE AND STATE "CAUTION - SERIES RATED SYSTEM."

GROUNDING

- A. ALL FEEDERS AND BRANCH CIRCUITS OVER 100 VOLTS SHALL INCLUDE A GROUNDING CONDUCTOR SIZED IN ACCORDANCE WITH NEC TABLE 250.122, EXCEPT NOT BE SMALLER THAN #12 FOR POWER AND LIGHTING CIRCUITS AND #14 FOR CONTROL CIRCUITS. ALL GROUND CONDUCTORS SHALL BE GREEN, OR AS SPECIFIED UNDER SECTION "WIRE AND CABLE."
- B. ALL GROUND CLAMPS SHALL BE PENN-UNION "GPL" TYPE OR SIMILAR BY O.Z. OR BURNDY.
- C. CONDUIT FOR SOLITARY GROUND CONDUCTORS SHALL BE RIGID SCHEDULE 40 PVC NON-METALLIC ELECTRICAL CONDUIT WITH UL LABEL. SOLITARY GROUND CONDUCTORS SHALL NOT BE PLACED THROUGH METALLIC SLEEVES OR CONDUITS AND SHALL NOT BE COMPLETELY ENCIRCLED BY METALLIC HANGERS OR SUPPORTS.
- D. THE GROUND CONDUCTOR SHALL BE CONNECTED TO THE NEUTRAL IN ONLY TWO LOCATIONS - ON THE SUPPLY SIDE OF THE SERVICE DISCONNECT MEANS PER NEC 250.24 AND ON SEPARATELY DERIVED SYSTEMS PER NEC 250.30.
- E. AT EACH RECEPTACLE BOX, THE GROUND CONDUCTOR SHALL ENTER AND CONNECT, WITH NORMAL WIRING CONNECTOR, TO: 1) THE GROUND PIGTAIL TO RECEPTACLE; 2) THE GROUND PIGTAIL TO BOX GROUND SCREW; AND 3) THE OUTGOING GROUND CONDUCTOR TO NEXT DEVICE, IF NOT AT END OF RUN, METAL TO METAL CONTACT BETWEEN THE DEVICE YOKE AND THE OUTLET BOX IS NOT ACCEPTABLE AS A BOND FOR EITHER SURFACE MOUNTED BOXES OR FLUSH TYPE BOXES.
- F. CONDUIT SYSTEM SHALL BE ELECTRICALLY CONTINUOUS. ALL LOCK NUTS SHALL CUT THROUGH ENAMELED OR PAINTED SURFACES ON ENCLOSURES, WHERE ENCLOSURES AND NON-CURRENT CARRYING METALS ARE ISOLATED FROM THE CONDUIT SYSTEM. USE BONDING JUMPERS WITH APPROVED CLAMPS. WHERE REDUCING WASHERS ARE USED AND WHERE CONCENTRIC OR ECCENTRIC KNOCKOUTS ARE NOT COMPLETELY REMOVED BONDING BUSHINGS SHALL BE REQUIRED.

LIGHTING FIXTURES

- A. FLUSH FIXTURES MAY BE FURNISHED WITH PRE-WIRED FEATURE PROVIDED THEY ARE UL APPROVED FOR 75.C WIRING AND THE JUNCTION BOX CAPACITY IS SUFFICIENT FOR THE CIRCUIT WIRING REQUIREMENTS.
- B. CLEARANCES FOR RECESSED PORTIONS OF FIXTURES FROM COMBUSTIBLE MATERIAL AND THERMAL INSULATION, SHALL BE IN ACCORDANCE WITH NEC ARTICLE 410.66.
- C. ANY FIXTURES SCRATCHED, BENT, CRACKED OR IN ANY WAY DAMAGED BEFORE ACCEPTANCE BY OWNER SHALL BE REPLACED AT THIS CONTRACTOR'S EXPENSE.
- D. ALL FIXTURES SHALL BE IN WORKING ORDER AT THE TIME OF FINAL ACCEPTANCE OF THE WORK BY THE OWNER.
- E. ALL LIGHTING FIXTURES ARE TO BE GROUNDED ON THE INTERIOR OF THE FIXTURE HOUSING, ON CLEAN BARE METAL (FREE OF PAINT), BY USE OF A PIGTAIL AND FASTENED BY A SCREW USED FOR NO OTHER PURPOSE.

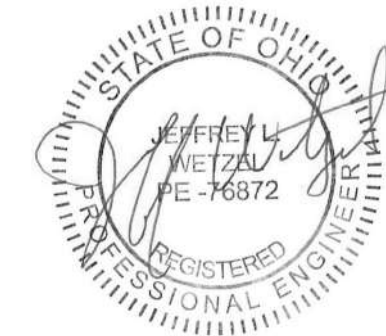

ISSUE		
NO.	DATE	DESCRIPTION

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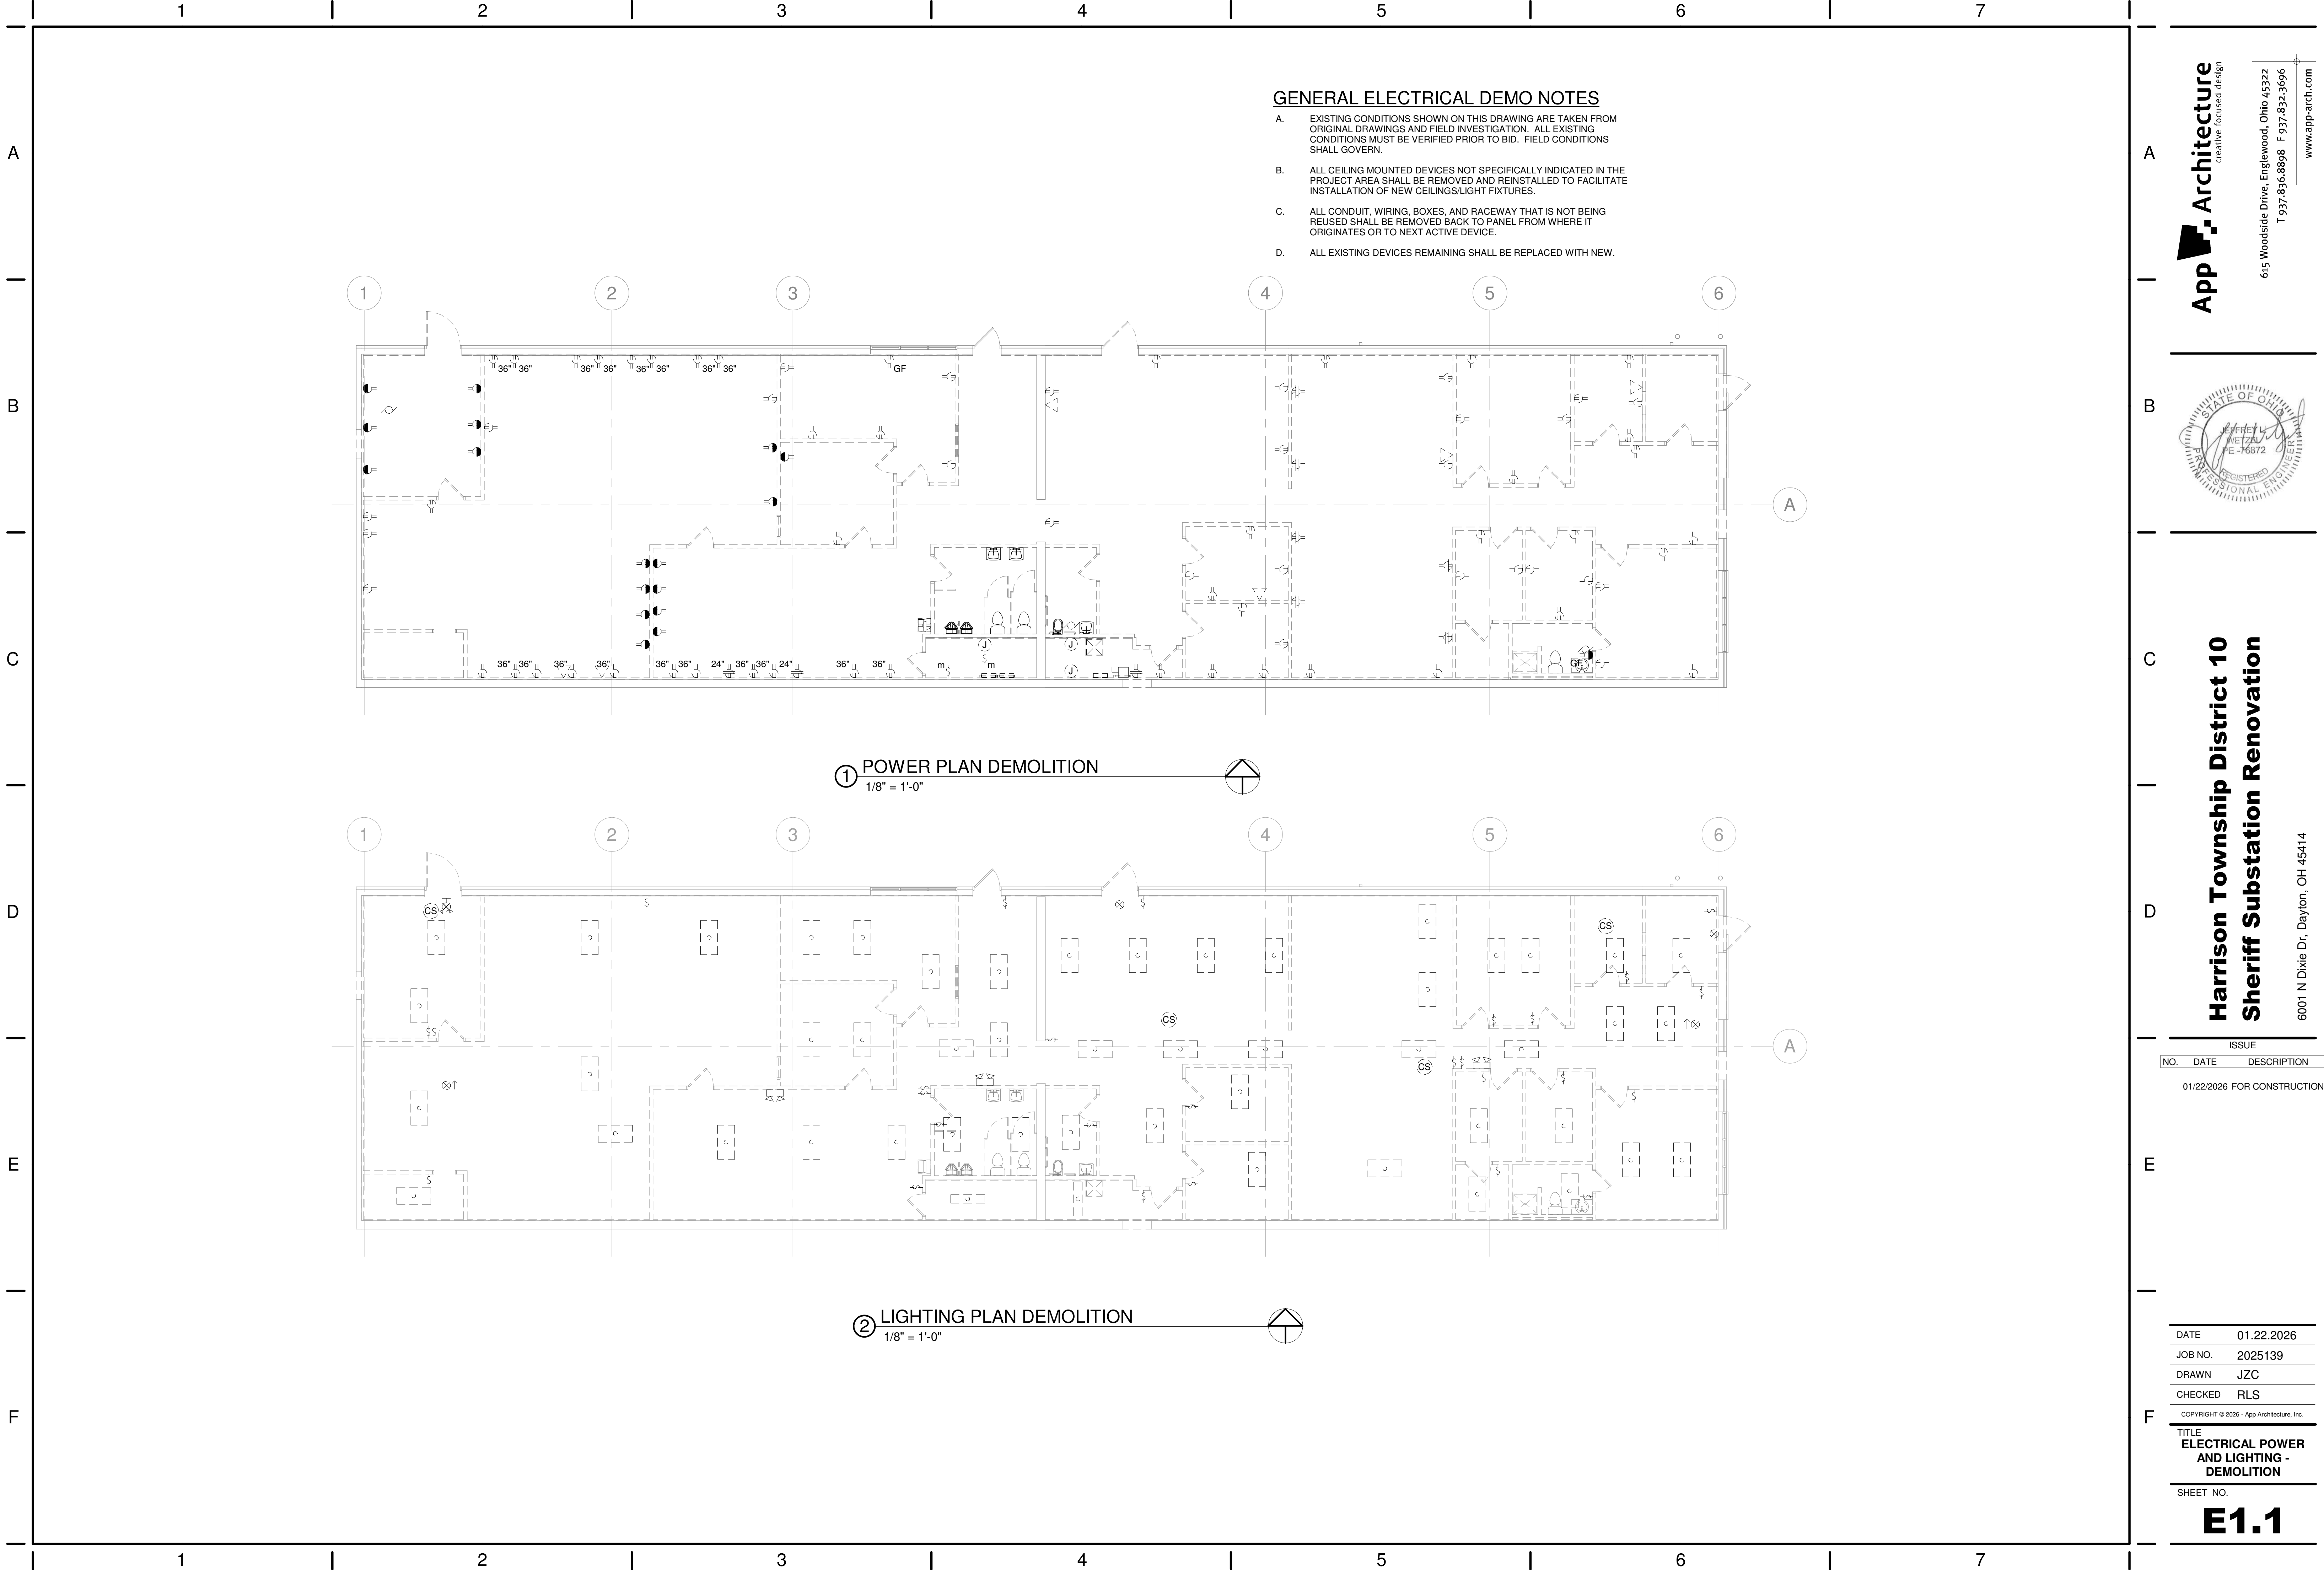
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JOB NO.	2025139
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CHECKED	RLS

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TITLE	
ELECTRICAL SPECIFICATIONS	

SHEET NO.

E0.3





Harrison Township District 10  
Sheriff Substation Renovation

6001 N Dixie Dr, Dayton, OH 45414

ISSUE		
NO.	DATE	DESCRIPTION
01/22/2026 FOR CONSTRUCTION		

DATE	01.22.2026
JOB NO.	2025139
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TITLE ELECTRICAL POWER AND LIGHTING - DEMOLITION	
SHEET NO.	

E1.1




BASE BID DESCRIPTION


- A. THE ELECTRICAL BASE BID FOR THE WEST AREA SHALL INCLUDE ALL ELECTRICAL SCOPE SHOWN ON THIS SHEET.
- B. AS A DEDUCT ALTERNATE, CONTRACTOR SHALL PROVIDE THE COST REDUCTION TO SHELL THE WEST AREA SPACE. REFER TO SHEET E2.2 FOR ALTERNATE ELECTRICAL PLAN FOR FURTHER DETAILS.

DRAWING NOTES

1. PROVIDE 6" STEEL MULTIOUTLET SYSTEM WITH TAMPER RESISTANT RECEPTACLES AT 9" ON CENTER. LEGRAND #WH20GB609 OR EQUAL.
2. SECURITY CAMERAS BY OWNER. ELECTRICAL CONTRACTOR TO COORDINATE WITH IT VENDOR.

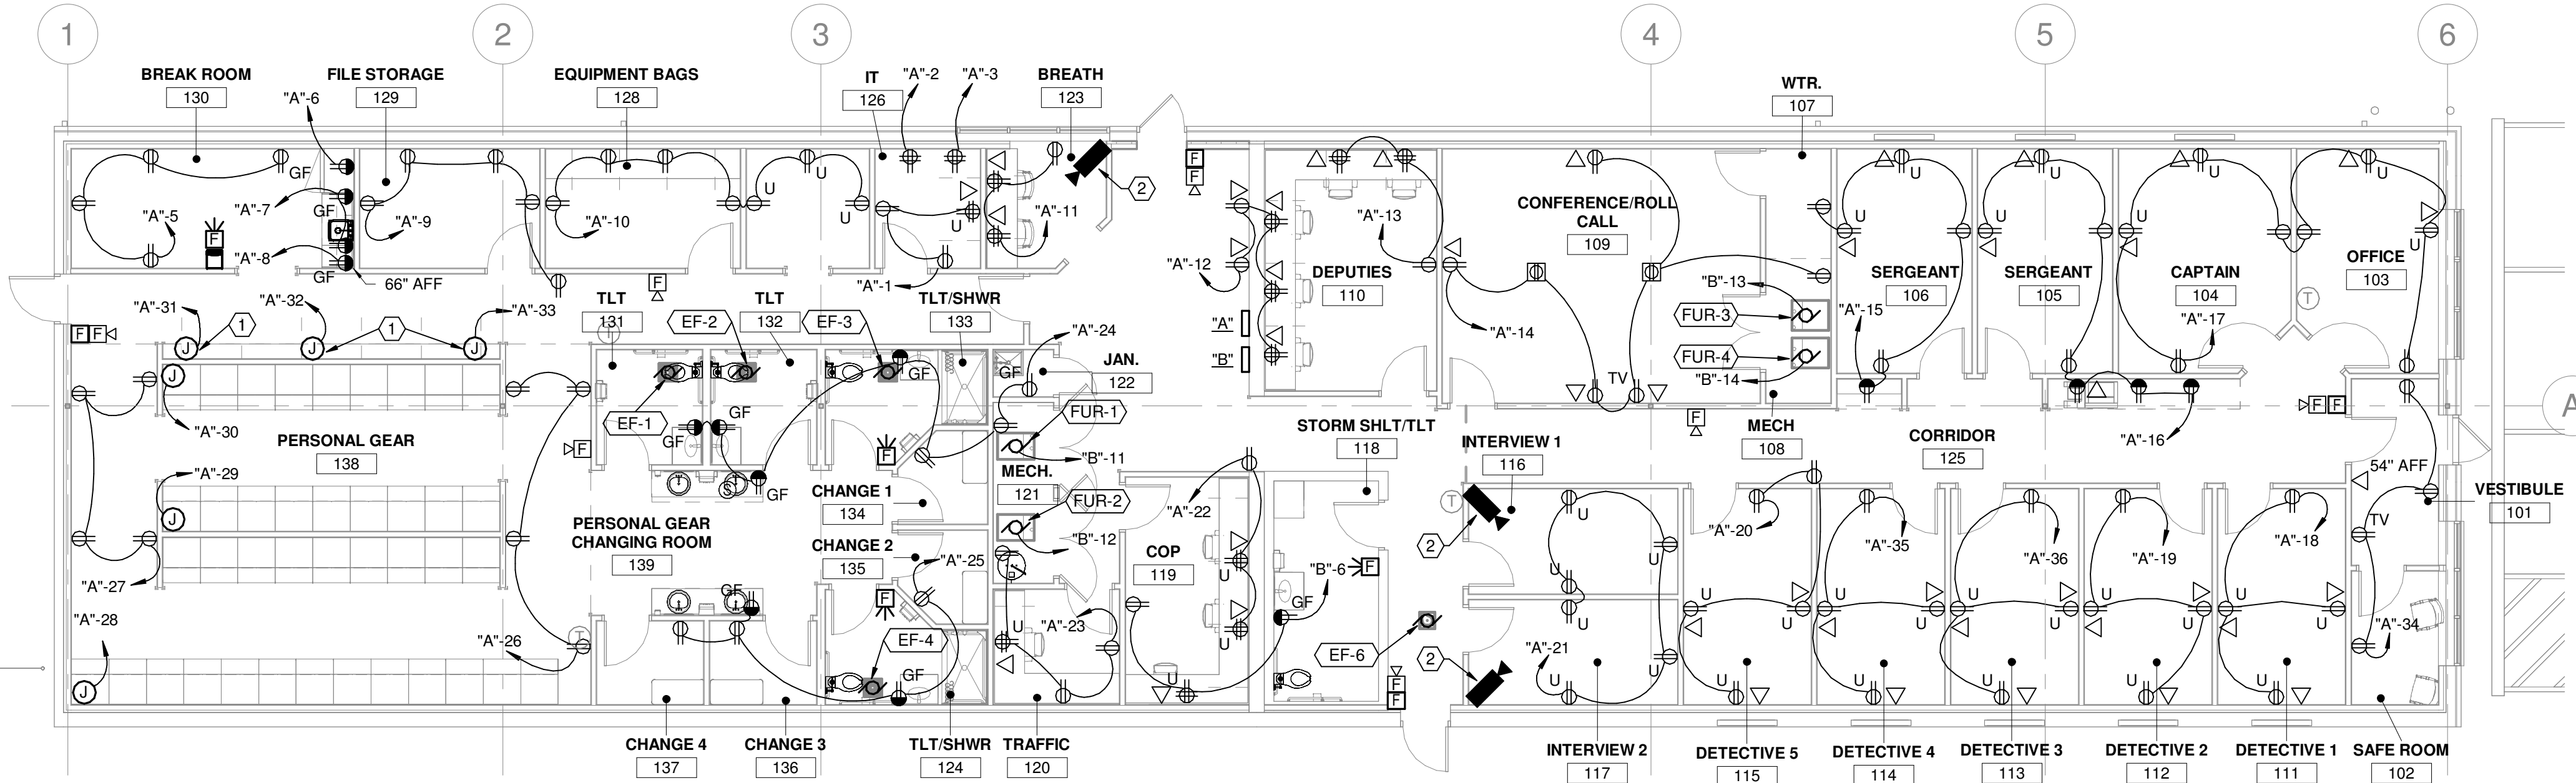

2 POWER PLAN NEW WORK  
1/8" = 1'-0"

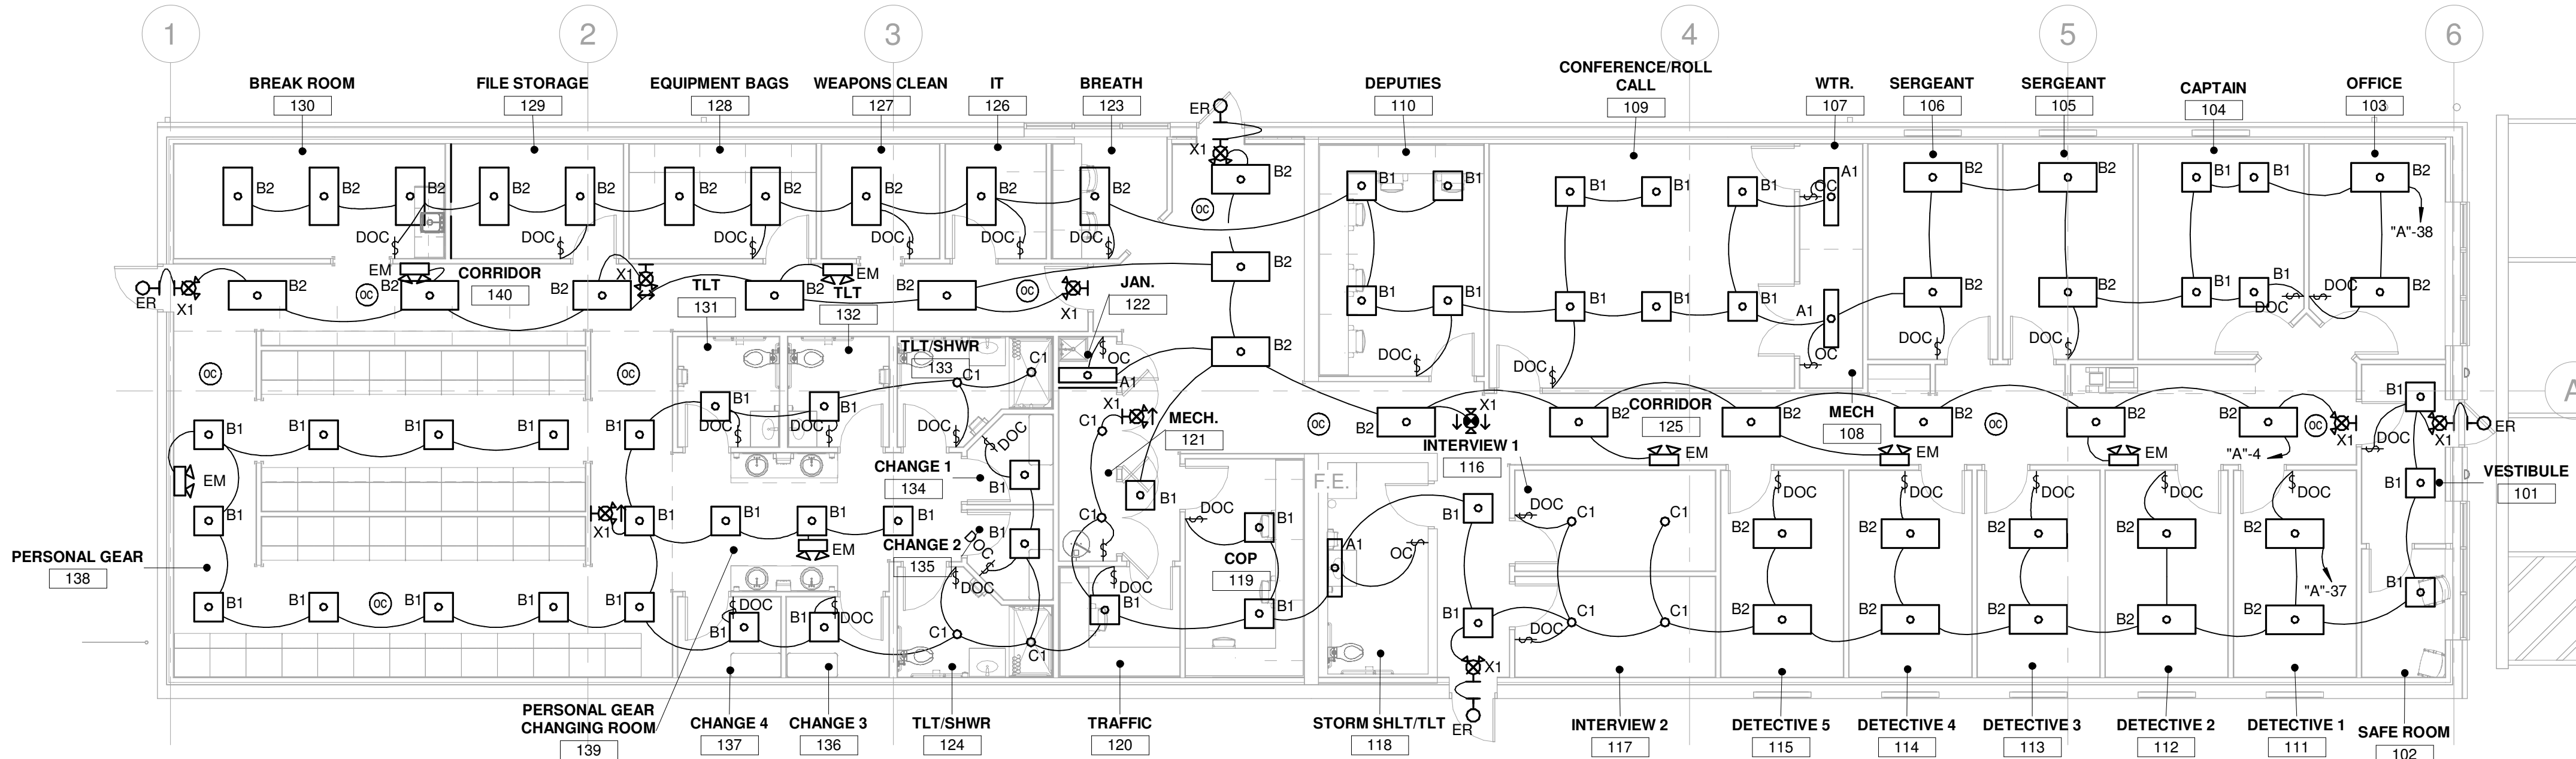

1 LIGHTING PLAN NEW WORK  
1/8" = 1'-0"

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DATE	01.22.2026
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TITLE ELECTRICAL POWER AND LIGHTING - NEW WORK	
SHEET NO.	



- A. AS A DEDUCT ALTERNATE, CONTRACTOR SHALL PROVIDE THE COST REDUCTION TO REDUCE THE BASE BID ELECTRICAL DESIGN FOR THE WEST AREA TO ONLY AS SHOWN ON THIS PLAN.
- B. REFER TO SHEET E2.1 FOR THE BASE BID ELECTRICAL SCOPE OF WORK.

1. PROVIDE 6" STEEL MULTIOUTLET SYSTEM WITH TAMPER RESISTANT RECEPTACLES AT 9" ON CENTER. LEGRAND #WH20GB609 OR EQUAL
2. SECURITY CAMERAS BY OWNER. ELECTRICAL CONTRACTOR TO COORDINATE WITH IT VENDOR.
3. EC TO PROVIDE TEMPORARY SUPPORT FROM STRUCTURE FOR LIGHTING FIXTURES UNTIL CEILING GRID INSTALLATION.



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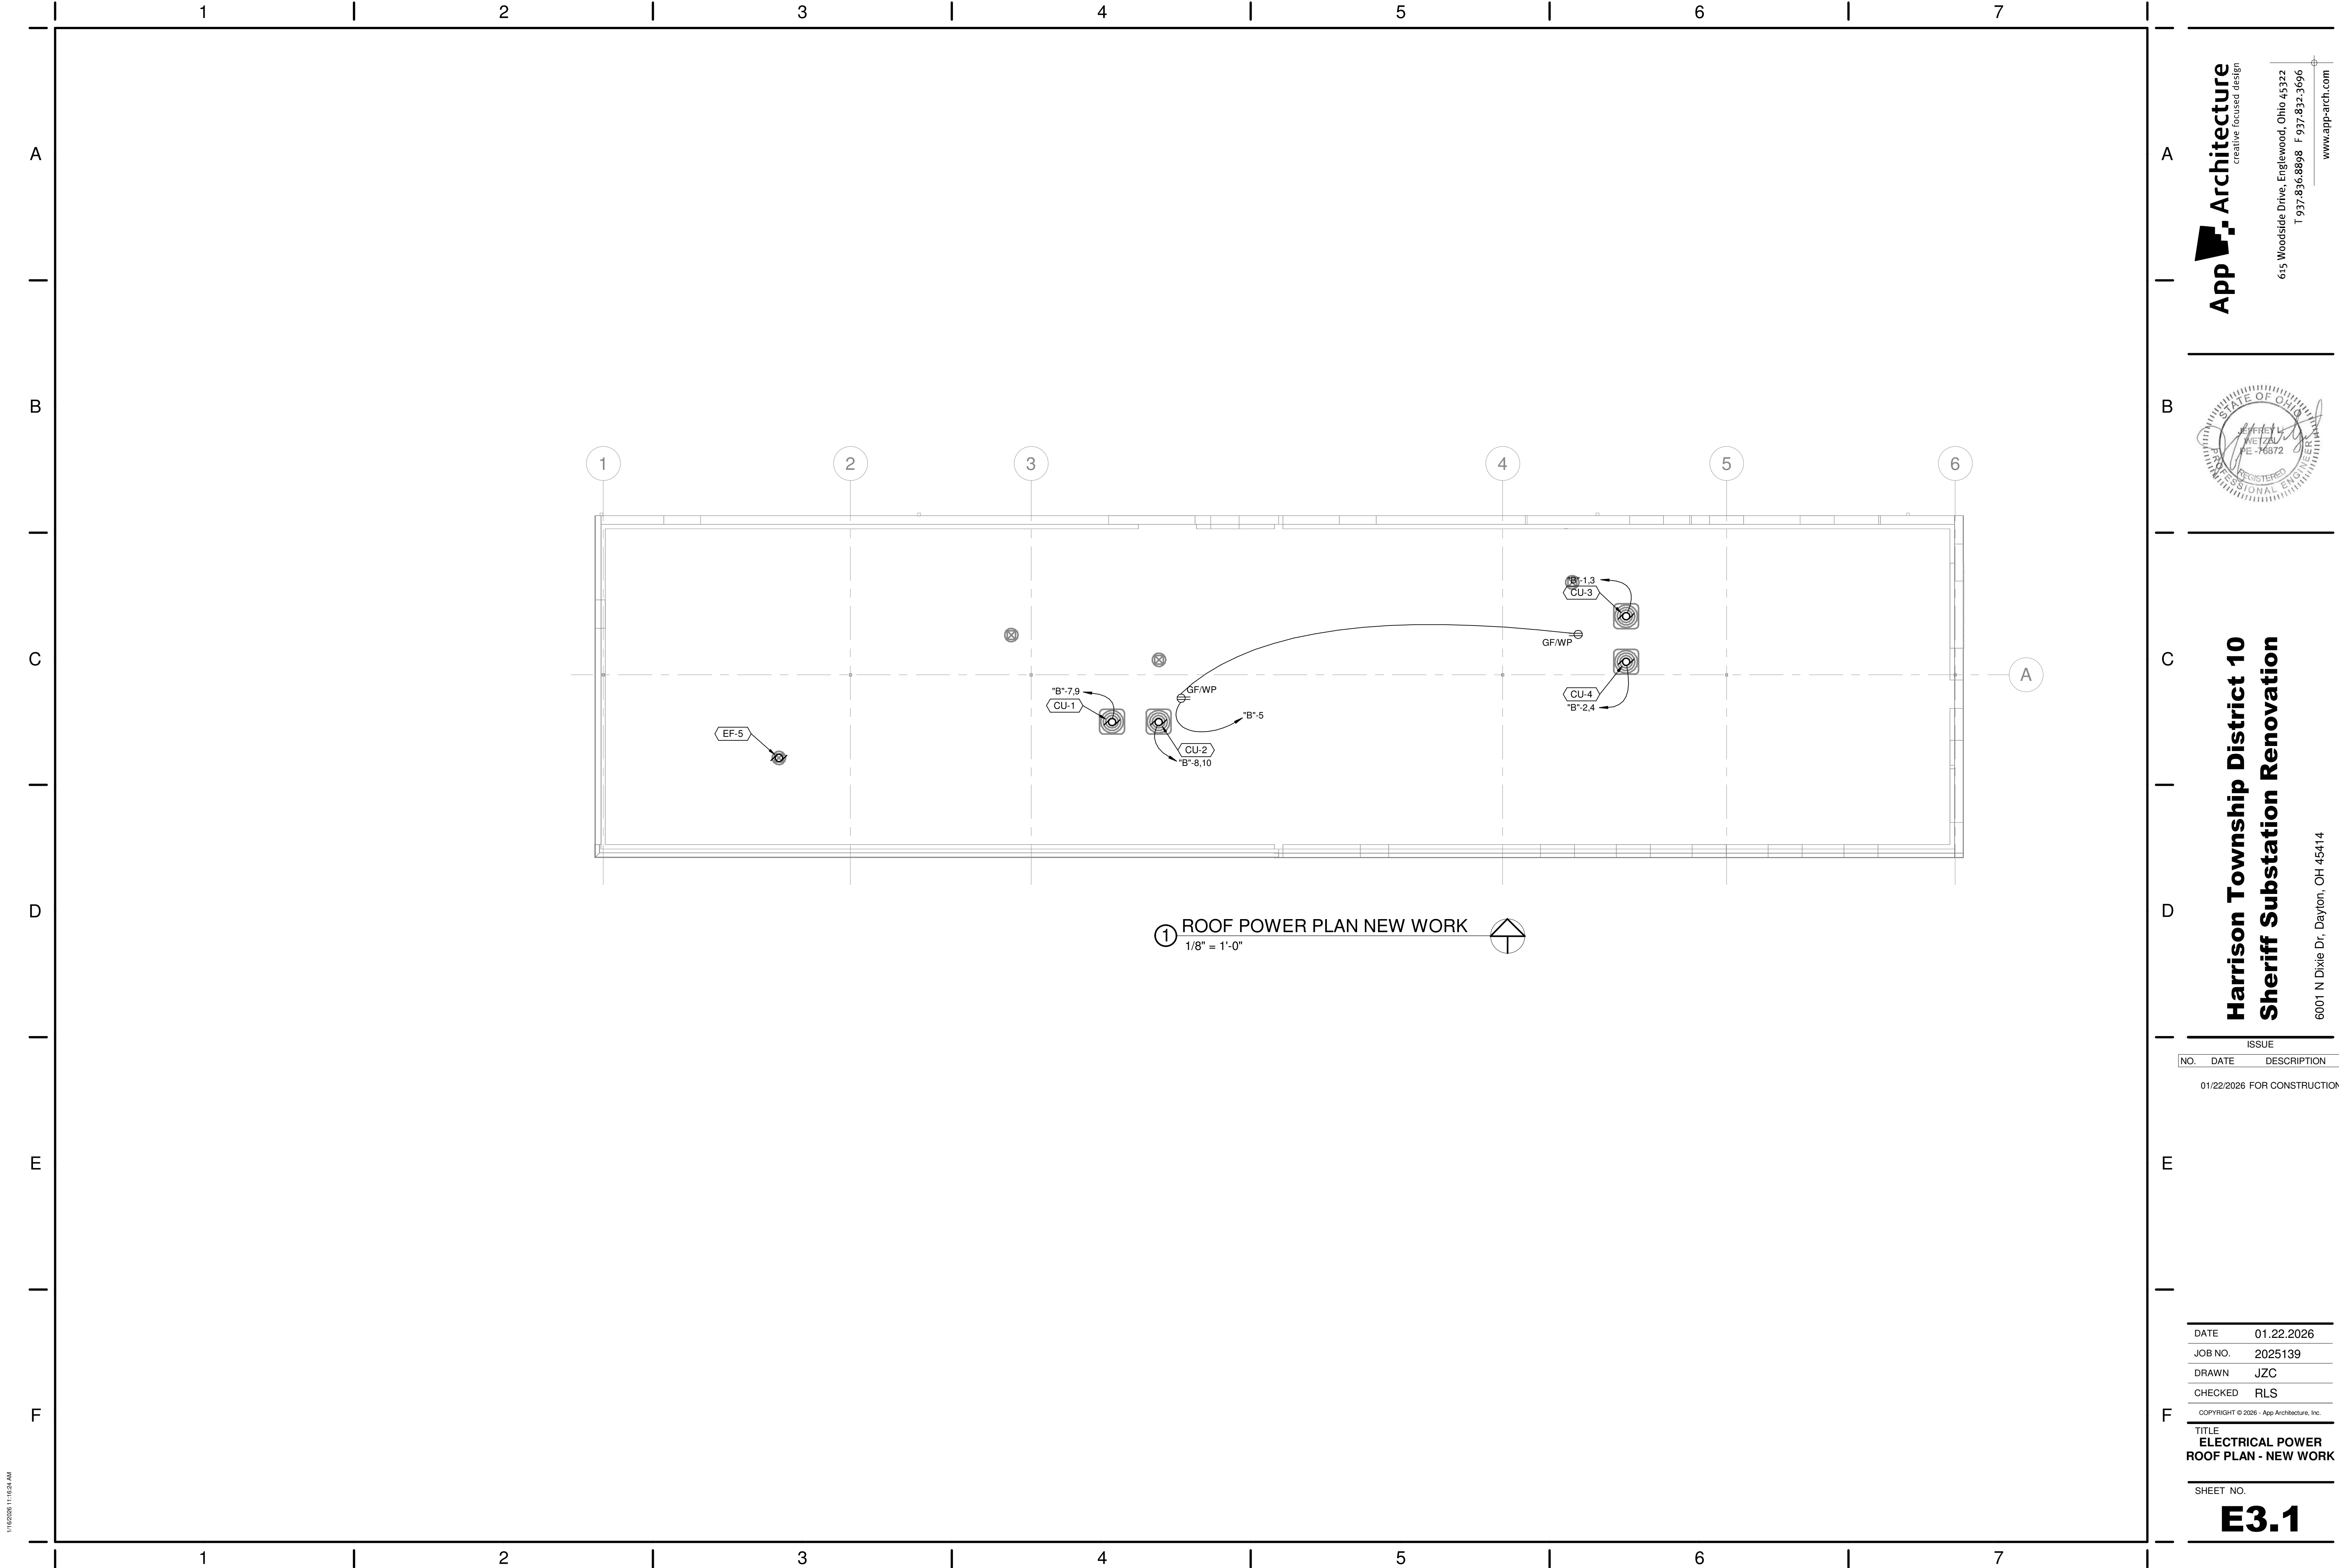
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TITLE  
ELECTRICAL POWER  
AND LIGHTING - NEW  
WORK - ALTERNATE 1

SHEET NO. \_\_\_\_\_

## E2.2






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Harrison Township District 10  
Sheriff Substation Renovation

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ELECTRICAL POWER  
ROOF PLAN - NEW WORK

SHEET NO.

E3.1

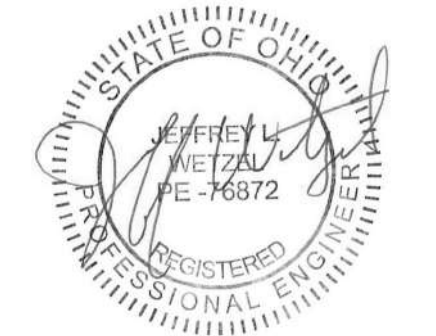

A

B


C

D

E

F

Branch Panel: "A"																	
Location: CORRIDOR 125				Volts: 120/208 Wye				A.I.C. Rating:									
Supply From:				Phases: 3				Mains Type:									
Mounting: Surface				Wires: 4				Mains Rating: 200 A									
Enclosure: Type 1								MCB Rating: 200 A									
Notes:																	
CKT	Circuit Description			Trip	Poles	A		B		C		Poles	Trip	Circuit Description			CKT
1	RCPT - IT (126)			20 A	1	720 360						1	20 A	RCPT - IT (126)			2
3	RCPT - IT (126)			20 A	1			360 446				1	20 A	LTG - CORRIDOR			4
5	RCPT - BREAK ROOM (130)			20 A	1					720 180		1	20 A	RCPT - REFRIGERATOR BREAK ROOM (130)			6
7	RCPT - BREAK ROOM (130)			20 A	1	360 180						1	20 A	RCPT - MICROWAVE BREAK ROOM (130)			8
9	RCPT - FILE STORAGE (129)			20 A	1			900 1260				1	20 A	RCPT - EQUIPMENT BAGS (128)			10
11	RCPT - BREATH (123)			20 A	1					900 1440		1	20 A	RCPT - DEPUTIES (110)			12
13	RCPT - DEPUTIES (110)			20 A	1	900 1620						1	20 A	CONFERENCE / ROOL CALL (109)			14
15	RCPT - SERGEANT (106)			20 A	1			1080 1260				1	20 A	RCPT - SERGEANT (105)			16
17	RCPT - CAPTAIN (104) / SARAH (103)			20 A	1					1440 720		1	20 A	RCPT - DETECTIVE (111) / SAFE ROOM (102)			18
19	RCPT - DETECTIVE 2 (112)			20 A	1	720 900						1	20 A	RCPT - DETECTIVE 4 (115)			20
21	RCPT - INTERVIEW 2 (117)			20 A	1			1080 900				1	20 A	RCPT - COP (119) AND STORM SHLT. (116)			22
23	RCPT - TRAFFIC (120)			20 A	1					720 1260		1	20 A	RCPT - TLT (131-134)			24
25	RCPT - CHANGE 2,3, AND 4 (135-137)			20 A	1	900 720						1	20 A	RCPT - PERSONAL GEAR (138)			26
27	RCPT - PERSONAL GEAR (138)			20 A	1			720 180				1	20 A	J-BOX - PERSONAL GEAR (138)			28
29	J-BOX - PERSONAL GEAR (138)			20 A	1					180 180		1	20 A	J-BOX - PERSONAL GEAR (138)			30
31	J-BOX - PERSONAL GEAR PLUG MOLD (138)			20 A	1	180 180						1	20 A	J-BOX - PERSONAL GEAR PLUG MOLD (138)			32
33	J-BOX - PERSONAL GEAR PLUG MOLD (138)			20 A	1			180 720				1	20 A	RCPT - SAFE ROOM (102)			34
35	RCPT - DETECTIVE 4 (114)			20 A	1					720 720		1	20 A	RCPT - DETECTIVE 3 (113)			36
37	LTG - SOUTH SIDE			20 A	1	1344 916						1	20 A	LTG - NORTH SIDE			38
39	SPARE			20 A	1			0 0				1	20 A	SPARE			40
41	SPARE			20 A	1					0 0		1	20 A	SPARE			42
43	SPARE			20 A	1	0 0						1	20 A	SPARE			44
45	SPARE			20 A	1			0 0				1	20 A	SPARE			46
47	SPACE			--	1					-- --		1	--	SPACE			48
49	SPACE			--	1	-- --						1	--	SPACE			50
51	SPACE			--	1			-- --				1	--	SPACE			52
53	SPACE			--	1					-- --		1	--	SPACE			54
Total Load:						10000 VA		9086 VA		9180 VA							
Total Amps:						83 A		76 A		77 A							
Legend:																	
Load Classification				Connected Load		Demand Factor		Estimated Demand		Panel Totals							
Receptacle				25560 VA		69.56%		17780 VA									
Lighting				2706 VA		100.00%		2706 VA									
										Total Conn. Load: 28266 VA							
										Total Est. Demand: 20486 VA							
										Total Conn.: 78 A							
										Total Est. Demand: 57 A							
Notes:																	

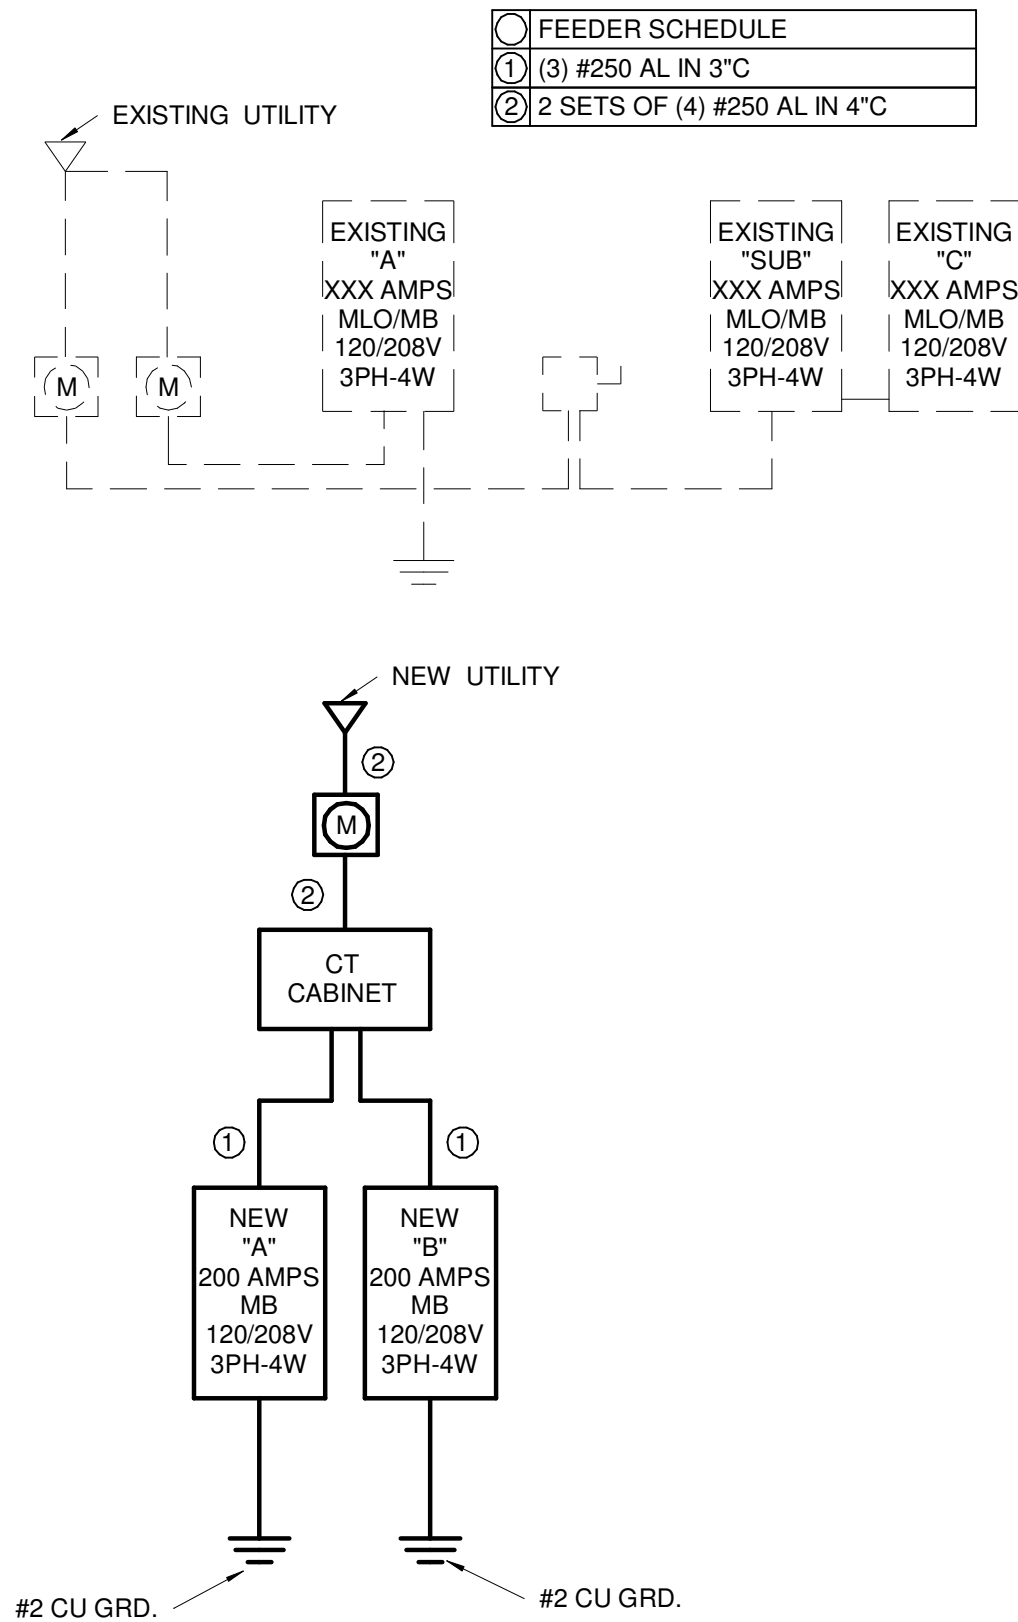

① SINGLELINE 1  
1 1/2" = 1'-0"


## DETAIL NOTES:

- 120V RECEPTACLE BRANCH CIRCUIT. REFER TO POWER PLANS
- 3/4" CONDUIT WITH CABLES TO CABLETRAY/DATA/COMM. BACKBOARD.
- SWITCH LEG.
- OR 4" ABOVE BACKSPASH
- STUB 1" CONDUIT TO ABOVE ACCESSIBLE CEILING. PROVIDE BUSHING
- 1" CONDUIT

## LEGEND

- DC DATA/COMMUNICATIONS OUTLET
- T TELEPHONE OUTLET
- TV AV BOX
- 120V POWER OUTLET
- SWITCH
- DOUBLE DUPLEX 120V POWER OUTLET

## TYPICAL DEVICE ELEVATION DETAILS

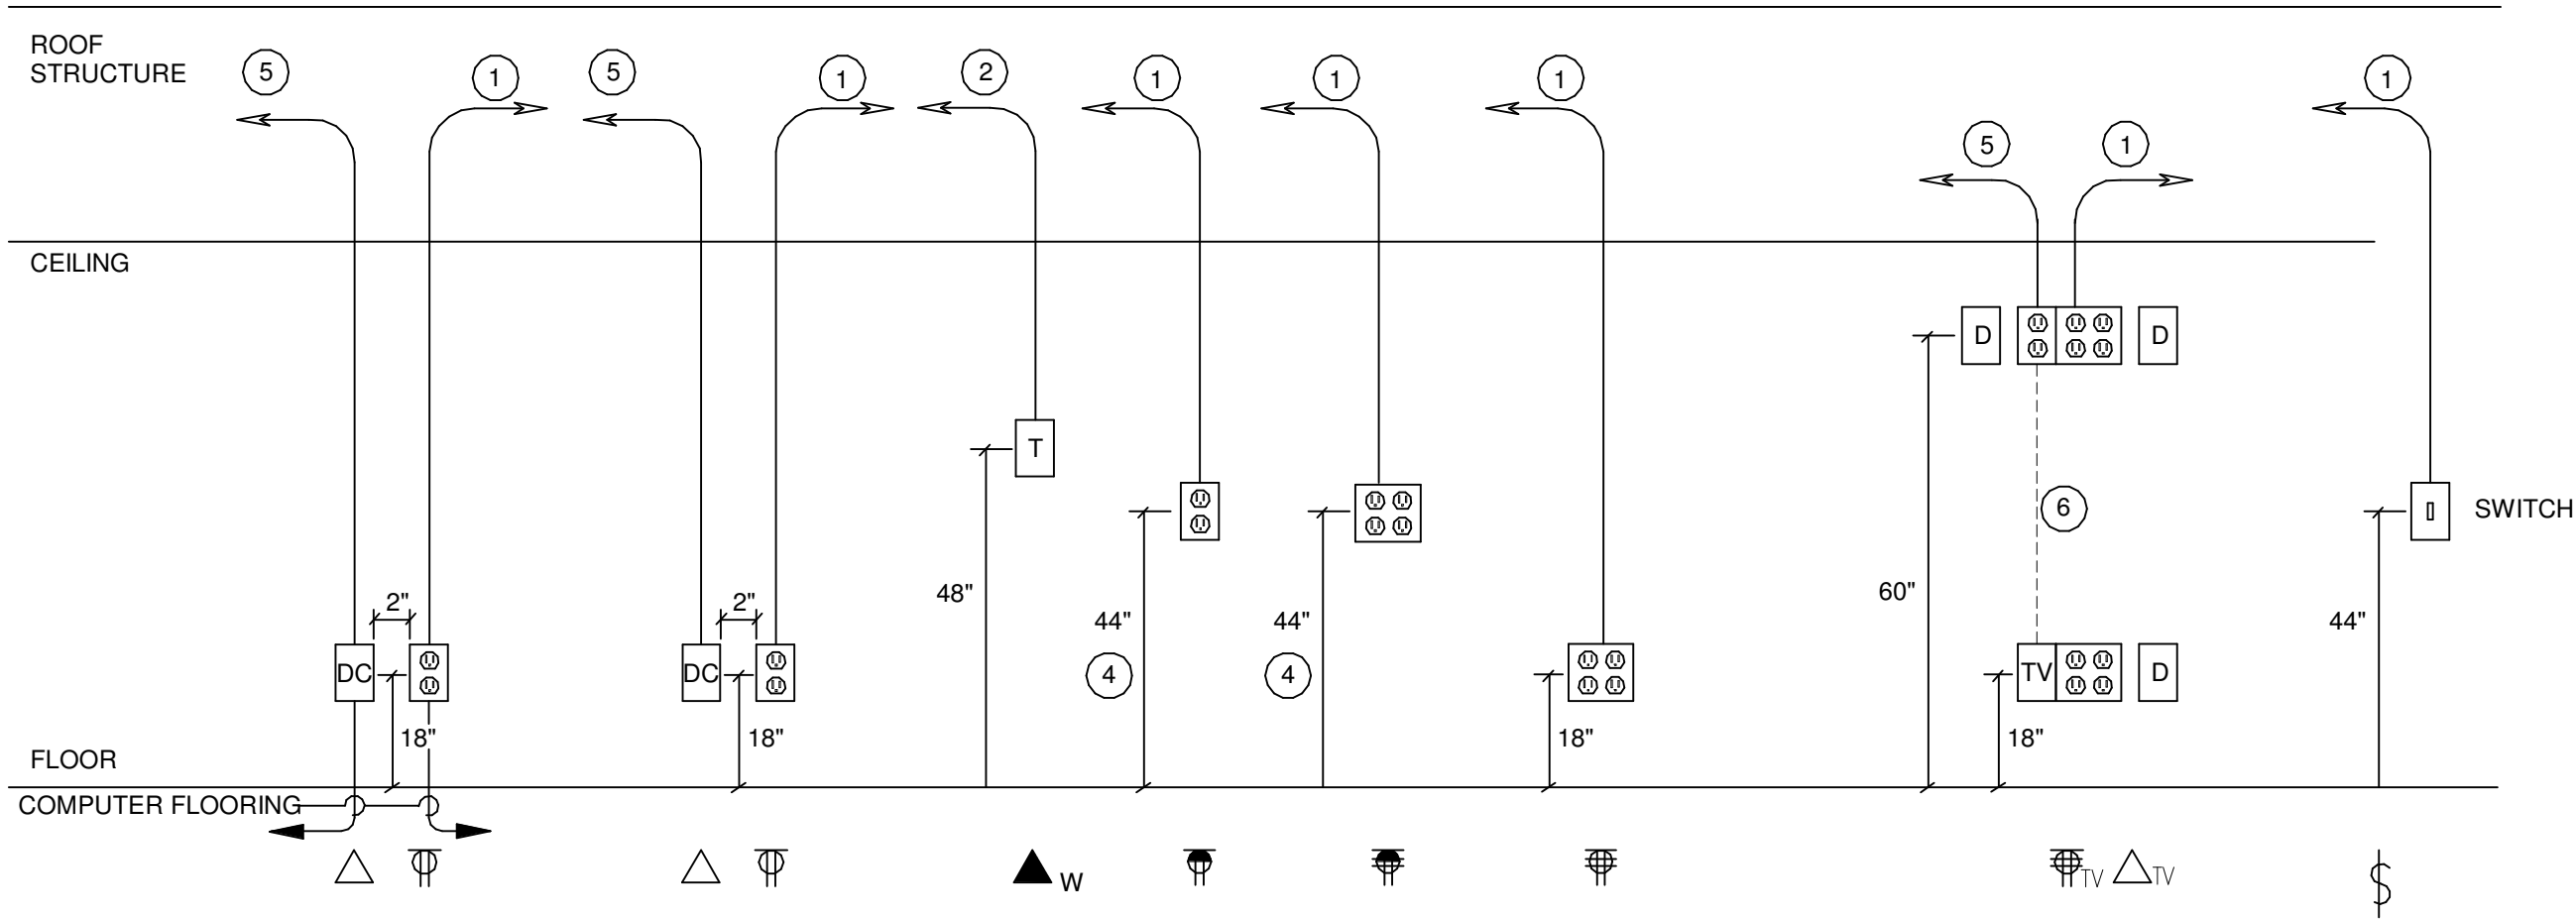

Branch Panel: "B"											
Location: CORRIDOR 125				Volts: 120/208 Wye				A.I.C. Rating:			
Supply From:				Phases: 3				Mains Type:			
Mounting: Surface				Wires: 4				Mains Rating: 200 A			
Enclosure: Type 1								MCB Rating: 200 A			
Notes:											
CKT	Circuit Description	Trip	Poles	A	B	C	Poles	Trip	Circuit Description	CKT	
1	CU-3	20 A	2	2779	2729		2	20 A	CU-4	2	
3	--	--	--		2779	2729	--	--	--	4	
5	RCPT - ROOF GF/WP	20 A	1			360	720	1	RCPT - COP (119) AND STORM SHLT. (116)	6	
7	CU-1	20 A	2	2729	2779		2	20 A	CU-2	8	
9	--	--	--		2729	2779	--	--	--	10	
11	FUR-1	20 A	1			1622	1603	1	FUR-2	12	
13	FUR-3	20 A	1	1603	1603			1	FUR-4	14	
15										16	
17										18	
19										20	
21										22	
23										24	
25										26	
27										28	
29										30	
31										32	
33										34	
35										36	
37										38	
39										40	
41										42	
Total Load:				14222 VA	11016 VA	4306 VA					
Total Amps:				127 A	100 A	36 A					
Legend:											
Load Classification			Connected Load		Demand Factor		Estimated Demand		Panel Totals		
Cooling			22031 VA		100.00%		22031 VA		Total Conn. Load: 29543 VA		
HVAC			6432 VA		100.00%		6432 VA		Total Est. Demand: 29543 VA		
Receptacle			1080 VA		100.00%		1080 VA		Total Conn.: 82 A		
									Total Est. Demand: 82 A		
Notes:											